CODE REVIEW

PROJECT ADDRESS: 12300 County Road 56 Routt County, Colorado

PROJECT OWNER:

(970) 405-6281

LOT SIZE: 47.58 Acres

PROJECT SIZE: 1,012 sf (667sf + 345 sf)

PROJECT DESCRIPTION:

A light-frame, off-grid, single-family dwelling unit with a loft and two porches.

JURISDICTION: Un-Incorporated Routt County Building Department

GOVERNING CODES:

2018 International Residential Code 2018 International Energy Conservation Code

OCCUPANCY: R-3

BUILDING HEIGHTS

CONSTRUCTION TYPE: V-B

Max allowable building height: 35'-0"

Proposed building height: 23'-0" above average grade

MEANS OF EGRESS

Exit Requirements per Floor: 2

Loft Access (R311.7.12)

FIXTURE COUNT

1 SHOWER / TUB 1 TOILET 2 SINKS

LIFE SAFETY LEGEND

FIRE EXTINGUISHER AND WALL MOUNTING BRACKET

MAXIMUM TRAVEL DISTANCE FROM FURTHEST POINT (USE THIS TAG IN CONJUNCTION WITH THE 'EGRESS DISTANCE' SCHEDULE FOR TOTALING OF ALL PATHS)

EMERGENCY EGRESS AND RESCUE OPENINGS

1. PROVIDE ONE WINDOW FROM EACH BEDROOM THAT HAS A MINIMUM NET CLEAR OPENING OF 5.7 SQUARE FEET WITH A MINIMUM NET CLEAR HEIGHT OF 24 INCHES AND A MINIMUM NET CLEAR WIDTH OF 20 INCHES. GRADE FLOOR EERO SHALL HAVE A NET CLEAR OPEINING OF NOT LESS THAN 5.0 SQUARE FEET PER R310.2.1.

2. BASEMENT EGRESS TO MEET THE REQUIREMENTS OF IRC 2018 SECTION 310 AS AMMENDED 5-308.

3. SMOKE ALARMS SHALL BE INSTALLED AS REQUIRED PER IRC 2018 SECTION R314 AND NFPA 72.

4. PROVIDE SMOKE ALARMS IN EACH SLEEPING ROOM, OUTSIDE OF EACH SLEEPING AREA IN THE IMMEDIATE VICINITY OF THE BEDROOMS, ON EACH FLOOR INCLUDING ASEMENTS AND HABITABLE ATTICS, AND NOT LESS THAN 3'-0" HORIZONTALLY FROM DOOR OPENING OF A BATHROOM THAT CONTAINS A BATHTUB OR SHOWER. ALARMS SHALL BE INTERCONNECTED IN SUCH A MANNER THAN THE ACTUATION OF ONE ALARM WILL ACTIVATE ALL OF THE ALARMS IN THE DWELLING.

5. SMOKE ALARMS SHALL RECEIVE THEIR PRIMARY POWER FROM THE BUILDING WIRING WHERE SUCH WIRING IS SERVED FROM A COMMERCIAL SOURCE, AND HERE PRIMARY POWER IS INTERUPPTED, SHALL RECEIVE POWER FROM A BATTERY. WIRING SHALL BE PERMENANT AND WITHOUT A DISCONNECTING SWITCH OTHER THAN THOSE REQUIRED FOR OVERCURRENT PROTECTION.

6. CARBON MONOXIDE ALARMS SHALL BE INSTALLED AS REQUIRED PER IRC 2018 SECTION R315.


7. FOR NEW CONSTRUCTION, CARBON MONOXIDE ALARMS SHALL BE PROVIDED IN DWELLING UNITS THAT CONTAIN A FUEL-FIRED APPLIANCE AND/OR THE DWELLING UNIT HAS AN ATTACHED GARAGE WITH AN OPENING THAT COMMUNICATED WITH THE DWELLING UNIT.

8. CARBON MONOXIDE ALARMS SHALL BE INSTALLED OUTSIDE OF EACH SEPARATE SLEEPINGAREA. WHERE A FUEL BURNING APPLIANCE IS LOCATED WITHIN A BEDROOM OR ITS ATTACHED BATHROOM, A CARBON MONOXIDE ALARM SHALL BE INSTALLED WITHIN THE BEDROOM.


9. COMBINATION SMOKE AND CARBON MONOXIDE ALARMS SHALL BE PERMITTED IN LIEU OF SEPARATE UNITS


ENERGY REQUIREMENTS


- 1. LIGHTING FIXTURES PENETRATING THE THERMAL ENVELOPE SHALL BE ICRATED, LEAKAGE RATED, AND SEALED TO THE GYPSUM WALLBOARD 2. AS REQUIRED PER N1102.4.4.
- 3. HOT WATER PIPES SHALL BE INSULATED AS REQUIRED PER N1103.4.
- 4. ALL EXHAUST FANS SHALL TERMINATE TO THE BUILDING EXTERIOR AS REQUIRED PER M1507.2.
- 5. MAKEUP AIR SYSTEMS SHALL BE INSTALLED FOR KITCHEN EXHAUST HOODS THAT EXCEED 400 CFM AS REQUIRED PER M1503.4. 6. ALL BATHROOMS AND TOILET ROOMS TO BE EQUIPPED WITH A MINIMUM 50 CFM INTERMITTENTLY OPERATIONG SOURCE SPECIFIC EXHAUST
- FAN. ALL KITCHENS TO BE EQUIPPED WITH A MINIMUM 100 CFM INTERMITTENTLY OPERATING SOURCE SPECIFIC EXHAUST FAN PER IRC M1507.4.
- 7. FACTORY-BUILT FIREPLACES SHALL BE LOSTED AND LABLED AND SHALL BE INSTALLED IN ACCORDANCE WITH THE CONDITIONS OF THE
- LISTING. FACTORY-BUILT FIREPLACES SHALL BE TESTED IN ACCORDANCE WITH UL 127 PER R1004.1.

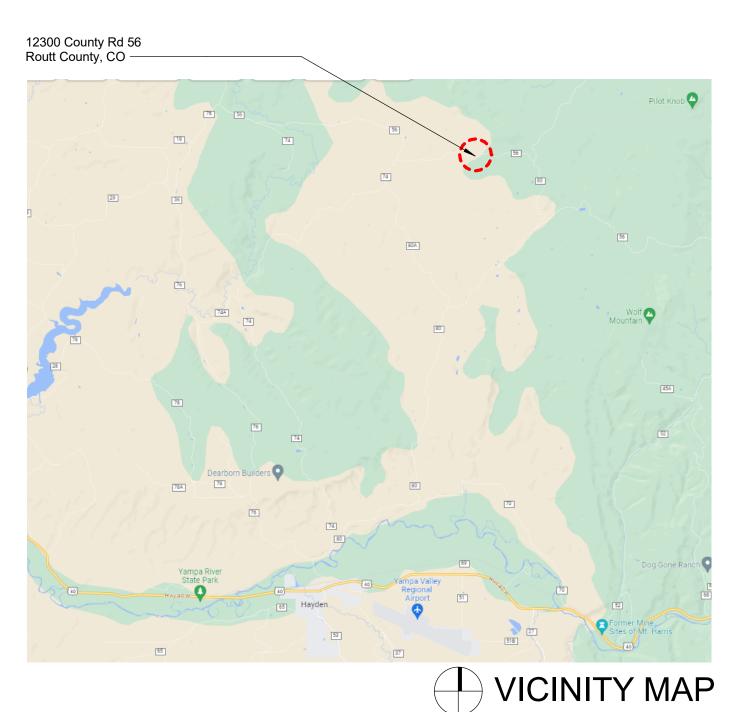


LOCATION OF PROPOSED

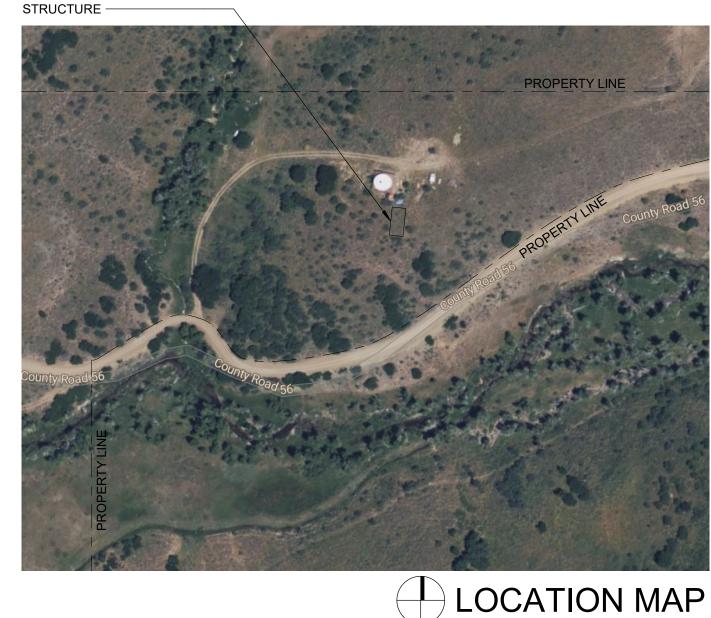

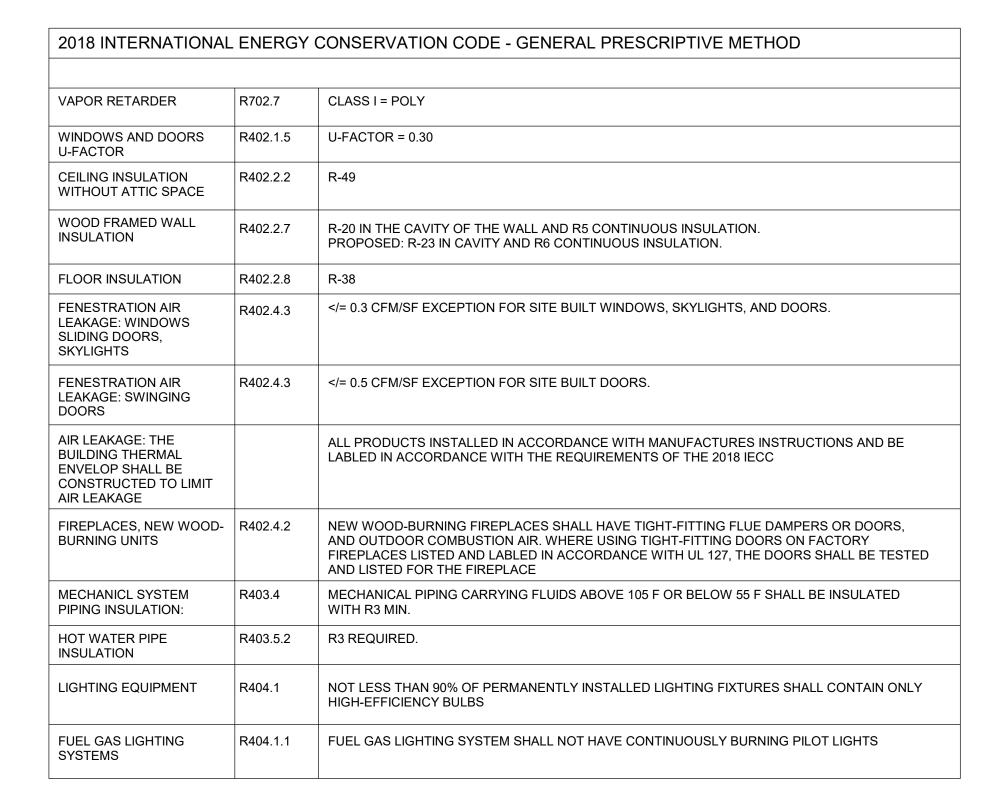

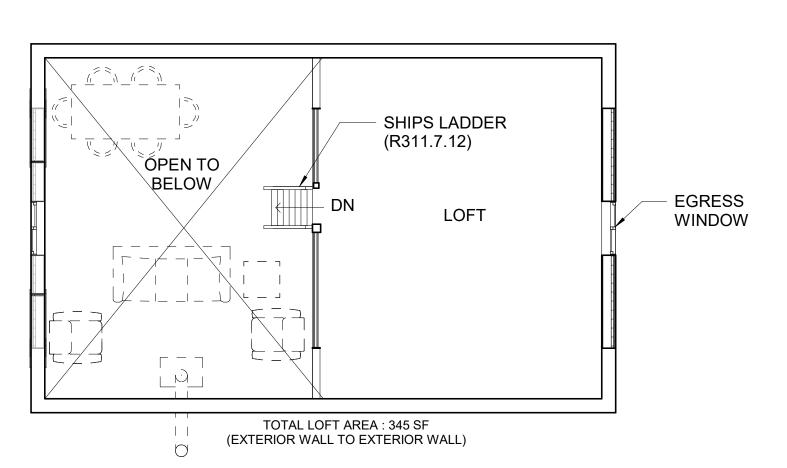


LOFT CODE PLAN B1

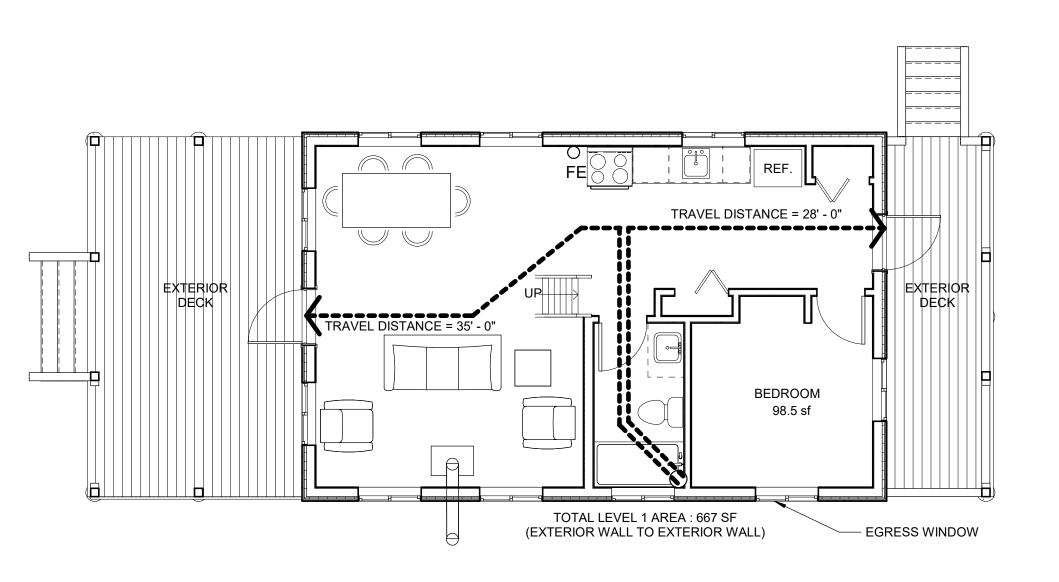


MAIN FLOOR CODE PLAN A1

SYMBOL LIST



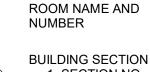

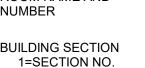


A101= SHEET NO.


1=ELEVATION NO.

A101= SHEET NO.




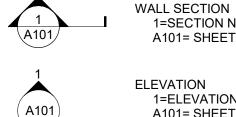

1=SECTION NO. A101= SHEET NO. **ELEVATION**

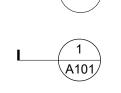


DETAIL SECTION 1=DETAIL NO. A101= SHEET NO

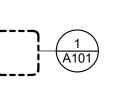






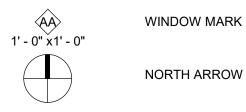


CEILING TAG W/ HEIGHT

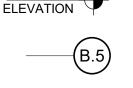


COLUMN GRID

LEVEL MARK



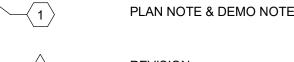


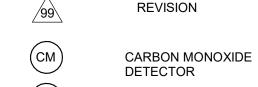


SMOKE DETECTOR


MATERIAL LEGEND


FACE BRICK (PLAN/SECTIO
CAST STONE (ELEVATION)
RIGID INSULATION
SPRAYED INSULATION
CONCRETE MASONRY

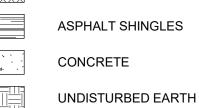


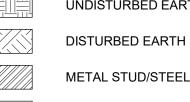




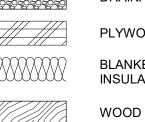

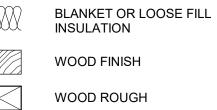

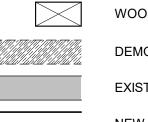

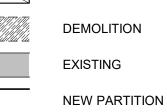


G001

REVISIONS

NO DESCRIPTION DATE

Issued For:


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GENERAL NOTES:
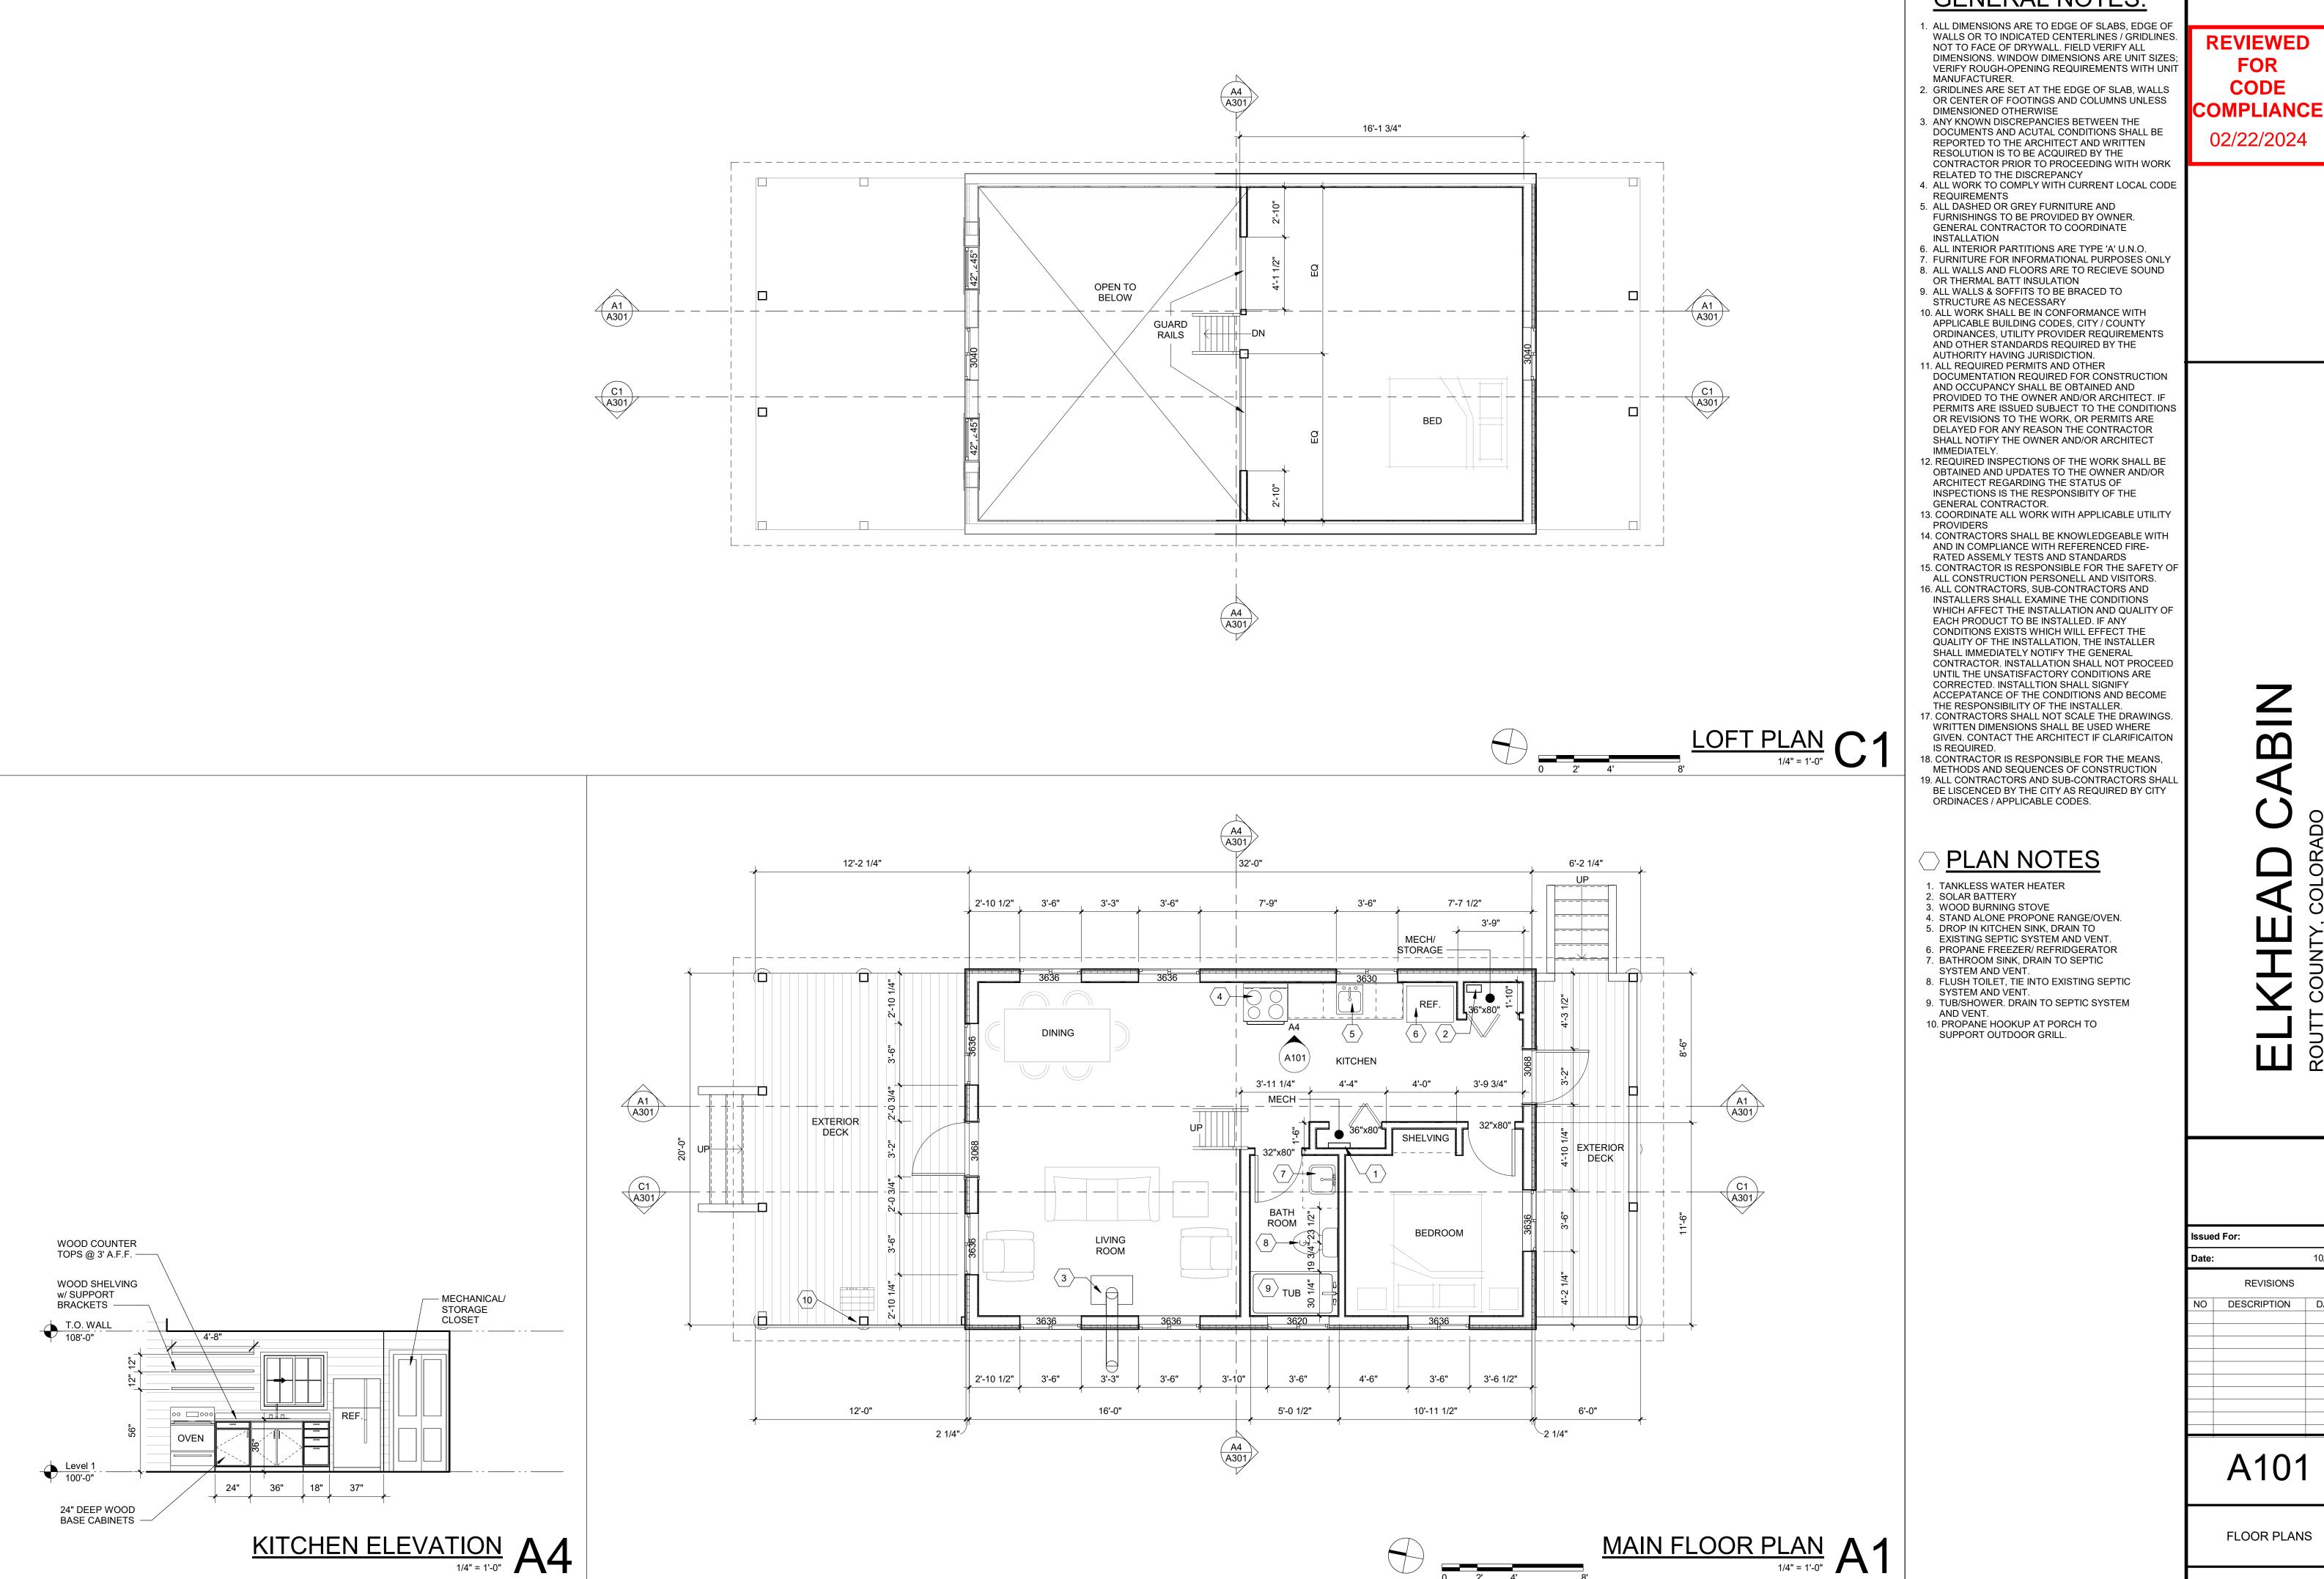
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Date:		10/27/23
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FLOOR PLANS




ROOFING

- 1. METAL ROOF PANEL ROOF COVERINGS SHALL BE APPLIED TO SOLID OR SPACED SHEATHING, EXCEPT WHERE THE ROOF COVERING IS SPECIFICALLY DESIGNED TO BE
- APPLIED TO SPACED SUPPORTS. R905.10.1 2. THE MINIMUM SLOPE FOR LAPPED, NONSOLDERED-SEAM METAL ROOFS WITHOUT APPLIED LAP SEALANT SHALL BE THREE UNITS VERTICAL IN 12 UNITS HORIZONTAL (25-
- 3. METAL-SHEET ROOF COVERINGS INSTALLED OVER STRUCTURAL DECKING SHALL COMPLY WITH TABLE R905.10.3(1). THE MATERIALS USED FOR METAL-SHEET ROOF COVERINGS SHALL BE NATURALLY CORROSION RESISTANT OR PROVIDED WITH CORROSION RESISTANCE IN ACCORDANCE WITH THE STANDARDS AND MINIMUM THICKNESS SHOWN IN TABLE R905.20.3(2)

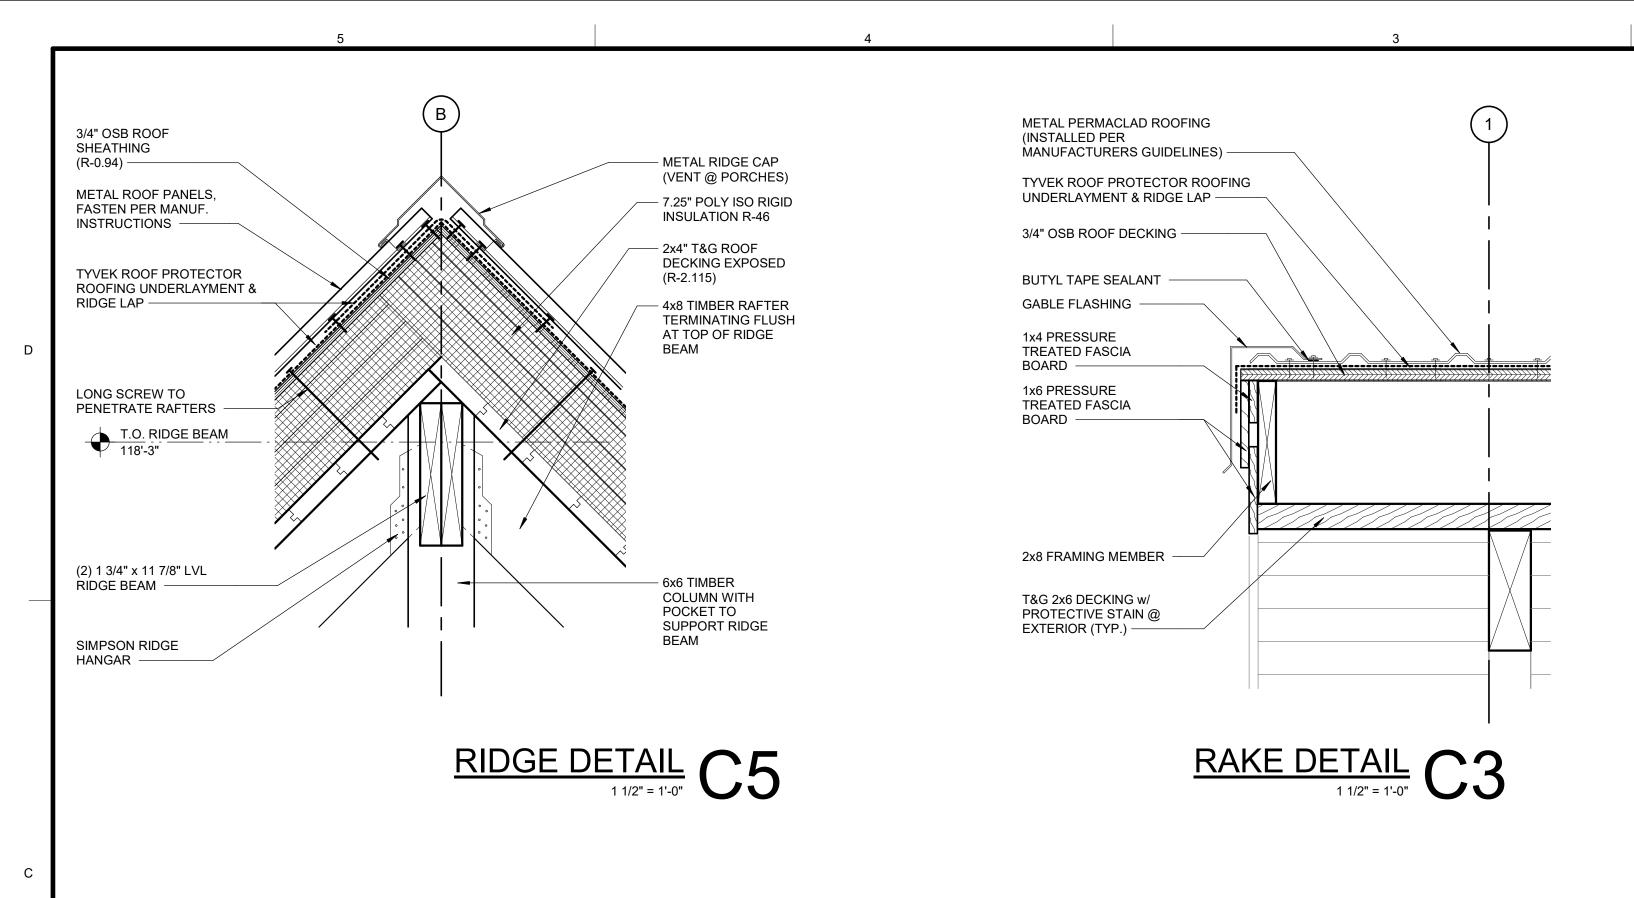 4. STAINLESS STEEL FASTENERS ARE ACCEPTABLE FOR METYAL ROOFS. R905.10.4

 5. UNDERLAYMENT SHALL COPLY WITH MANUFACTURERS INTRUCTIONS. R905.10

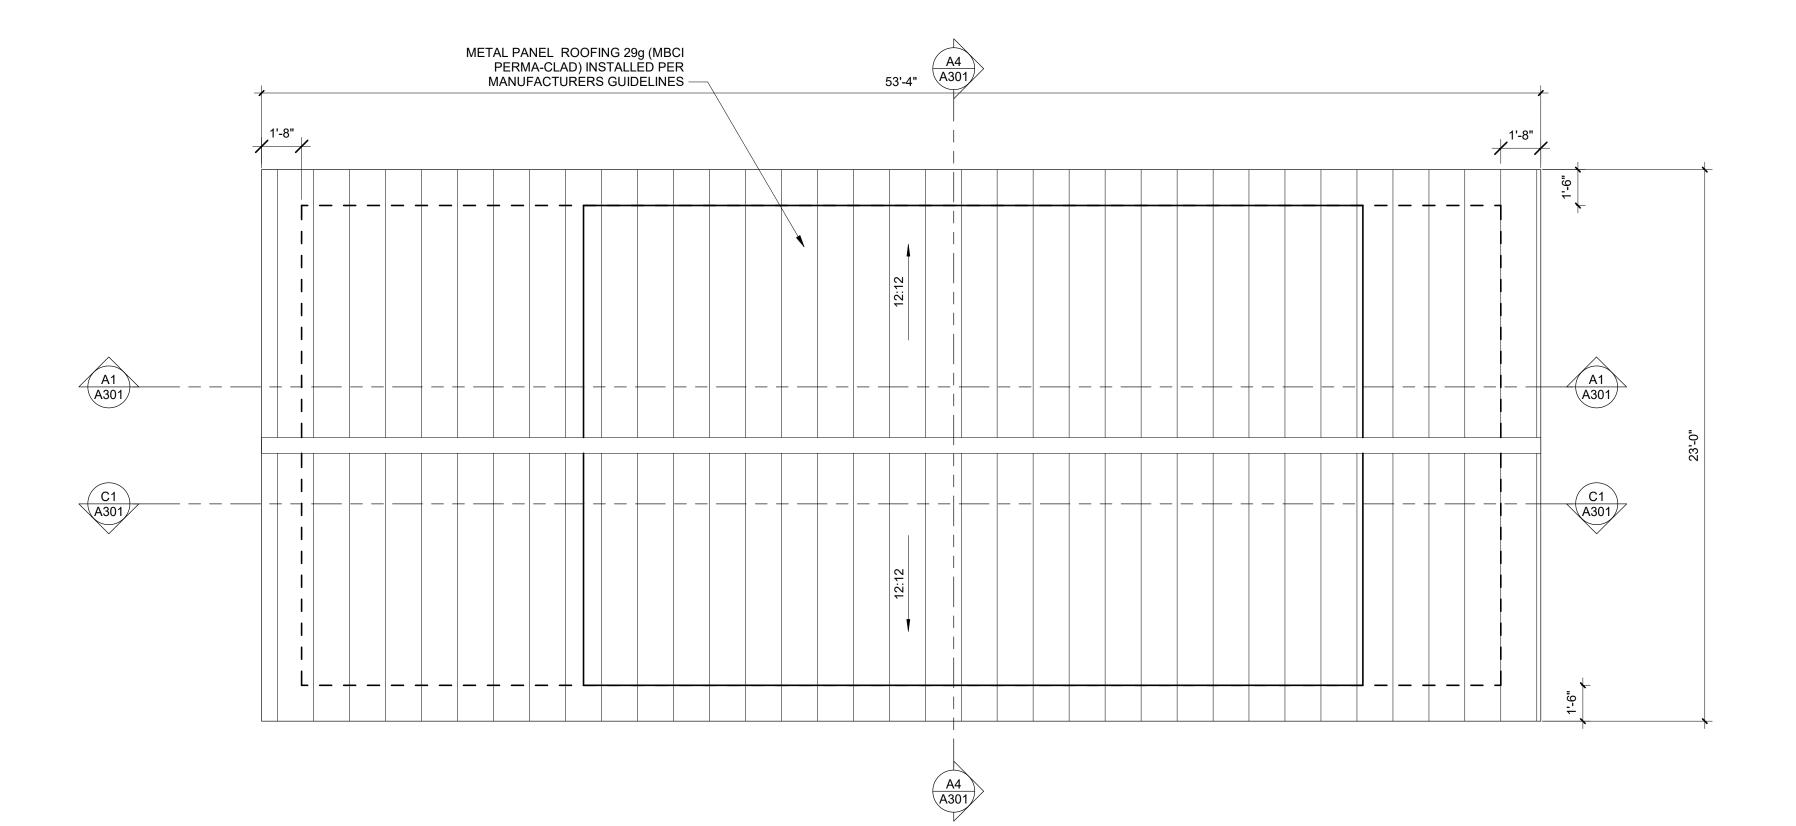

CODE COMPLIANCE

10/27/23

REVISIONS


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A114

ROOF PLAN

Issued For:

ROOF PLAN
1/4" = 1'-0"

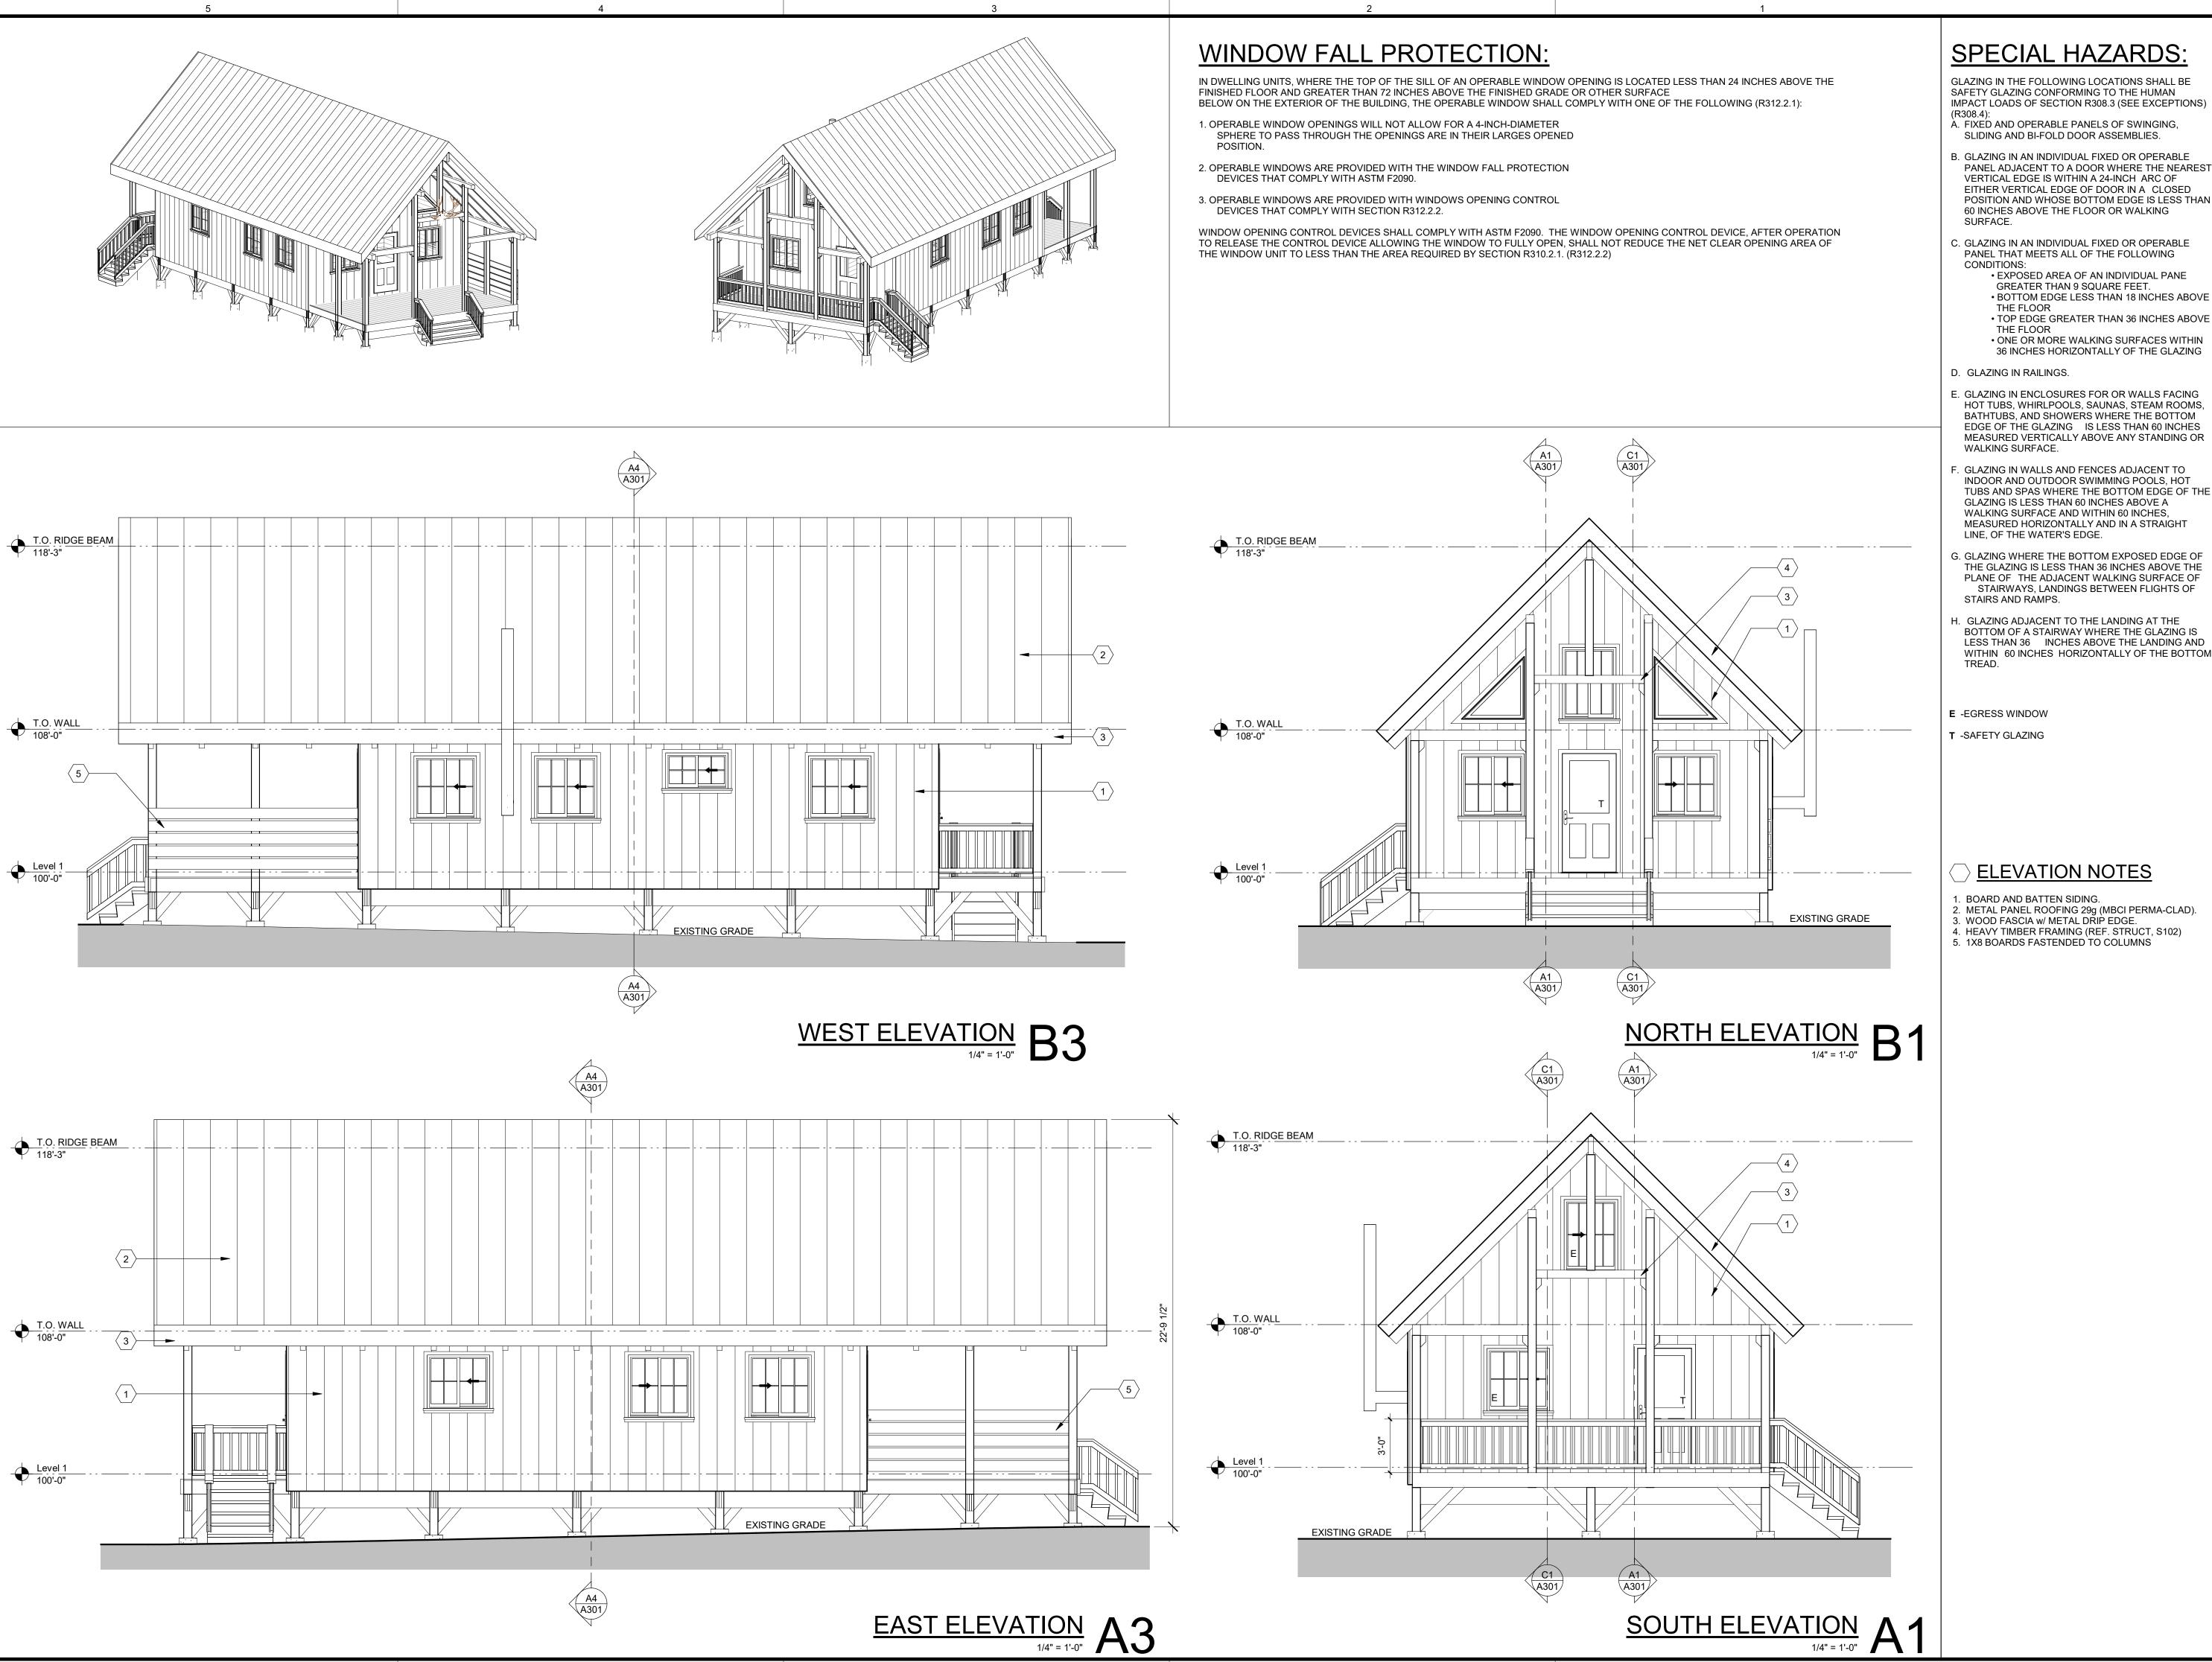

SPECIAL HAZARDS:

- GLAZING IN THE FOLLOWING LOCATIONS SHALL BE SAFETY GLAZING CONFORMING TO THE HUMAN IMPACT LOADS OF SECTION R308.3 (SEE EXCEPTIONS)
- À. FIXED AND OPERABLE PANELS OF SWINGING, SLIDING AND BI-FOLD DOOR ASSEMBLIES.
- B. GLAZING IN AN INDIVIDUAL FIXED OR OPERABLE PANEL ADJACENT TO A DOOR WHERE THE NEAREST VERTICAL EDGE IS WITHIN A 24-INCH ARC OF EITHER VERTICAL EDGE OF DOOR IN A CLOSED POSITION AND WHOSE BOTTOM EDGE IS LESS THAN 60 INCHES ABOVE THE FLOOR OR WALKING
- C. GLAZING IN AN INDIVIDUAL FIXED OR OPERABLE PANEL THAT MEETS ALL OF THE FOLLOWING CONDITIONS:
 - EXPOSED AREA OF AN INDIVIDUAL PANE GREATER THAN 9 SQUARE FEET.
 - BOTTOM EDGE LESS THAN 18 INCHES ABOVE THE FLOOR
 - THE FLOOR ONE OR MORE WALKING SURFACES WITHIN 36 INCHES HORIZONTALLY OF THE GLAZING
- D. GLAZING IN RAILINGS.
- E. GLAZING IN ENCLOSURES FOR OR WALLS FACING HOT TUBS, WHIRLPOOLS, SAUNAS, STEAM ROOMS, BATHTUBS, AND SHOWERS WHERE THE BOTTOM EDGE OF THE GLAZING IS LESS THAN 60 INCHES MEASURED VERTICALLY ABOVE ANY STANDING OR WALKING SURFACE.
- F. GLAZING IN WALLS AND FENCES ADJACENT TO INDOOR AND OUTDOOR SWIMMING POOLS, HOT TUBS AND SPAS WHERE THE BOTTOM EDGE OF THE GLAZING IS LESS THAN 60 INCHES ABOVE A WALKING SURFACE AND WITHIN 60 INCHES, MEASURED HORIZONTALLY AND IN A STRAIGHT LINE, OF THE WATER'S EDGE.
- G. GLAZING WHERE THE BOTTOM EXPOSED EDGE OF THE GLAZING IS LESS THAN 36 INCHES ABOVE THE PLANE OF THE ADJACENT WALKING SURFACE OF STAIRWAYS, LANDINGS BETWEEN FLIGHTS OF STAIRS AND RAMPS.
- H. GLAZING ADJACENT TO THE LANDING AT THE BOTTOM OF A STAIRWAY WHERE THE GLAZING IS LESS THAN 36 INCHES ABOVE THE LANDING AND WITHIN 60 INCHES HORIZONTALLY OF THE BOTTOM
- E -EGRESS WINDOW
- T -SAFETY GLAZING

ELEVATION NOTES

- BOARD AND BATTEN SIDING.
 METAL PANEL ROOFING 29g (MBCI PERMA-CLAD).
 WOOD FASCIA w/ METAL DRIP EDGE.
 HEAVY TIMBER FRAMING (REF. STRUCT, S102)
 1X8 BOARDS FASTENDED TO COLUMNS

REVIEWED CODE COMPLIANCE

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	10/27/23
REVISIONS	
DESCRIPTION	DATE

A201

ELEVATIONS

