
COMMUNITY OF PHIPPSBURG WASTEWATER TREATMENT IMPROVEMENT PROJECT

INAL DESIGN CTOBER 2023

		FI
		00
		SHEET INDEX
	SHEET NUMBER	SHEET TITLE
	GENERAL	
	G1	COVER & SHEET LIST
	G2	ABBREVIATIONS & SYMBOLS
	G3	GENERAL NOTES & REQUIREMENTS
	G4	DESIGN CRITERIA & MAJOR EQUIPMENT S
	G5	HYDRAULIC PROFILE
	G6	PROCESS FLOW DIAGRAM
	G7	PROCESS DETAILS
Γ	C0	METALS DETAILS

SHEET NUMBER	SHEET TITLE
GENERAL	
G1	COVER & SHEET LIST
G2	ABBREVIATIONS & SYMBOLS
G3	GENERAL NOTES & REQUIREMENTS
G4	DESIGN CRITERIA & MAJOR EQUIPMENT SUMMARY
G5	HYDRAULIC PROFILE
G6	PROCESS FLOW DIAGRAM
G7	PROCESS DETAILS
G8	METALS DETAILS
CIVIL	
C1	OVERALL SITE PLAN
C2	WWTP SITE PLAN
C3	SITE DEMOLITION & SEQUENCING PLAN
C4	WWTP GRADING PLAN
C5	LAGOON GRADING PLAN
C6	LAGOON RESTORATION PLAN
C7	EROSION CONTROL PLAN
C8	PRE-DEVELOPMENT DRAINAGE MAP
C9	POST DEVELOPMENT DRAINAGE MAP
C10	PROPOSED SEWER LINE PLAN & PROFILE
C11	PROPOSED SEWER LINE PLAN & PROFILE
C12	EFFLUENT DISCHARGE LINE CONNECTION DETAIL
C13	LAGOON CLOSURE PLAN
C14	EROSION CONTROL DETAILS
C15	CIVIL DETAILS
C16	CIVIL DETAILS II
C17	CIVIL DETAILS III

	SHEET INDEX
SHEET NUMBER	SHEET TITLE
PROCESS	
P1	BUILDING ISOMETRICS & INSTALLATION NOTES
P2	CONCRETE TANK LID PLAN
P3	CONCRETE TANK EQUIPMENT
P4	PROCESS PLAN
P5	PROCESS SECTION A
P6	PROCESS SECTION B
P7	PROCESS SECTION C
P8	PROCESS SECTIONS D
P9	PROCESS SECTION E & F
P10	P&ID LEGEND
P11	P&ID 1
P12	P&ID 2
P13	P&ID 3
P14	P&ID 4
STRUCTU	RAL
S1	GENERAL STRUCTURAL NOTES
S2	STRUCTURAL OBSERVATION REQUIREMENT & ABBREVIATIONS
S3	CONCRETE TANK FOUNDATION PLAN
S4	CONCRETE TANK LID PLAN
S5	CONCRETE TANK ELEVATION PLAN
S6	CONCRETE TANK ELEVATION PLAN
S7	STRUCTURAL DETAILS
ELECTRIC	AL
E1	ELECTRICAL NOTES & DETAILS
E2	ELECTRICAL LAYOUT
E3	ELECTRICAL ONE LINE & DETAILS

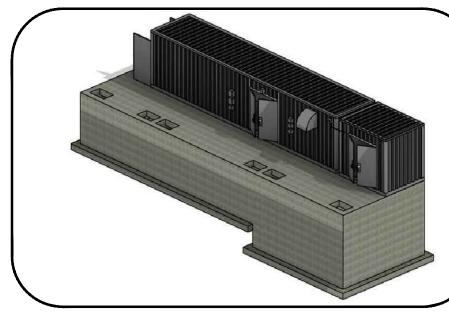

PROJECT ISOMETRIC



SITE PLAN NTS



LOCATION MAP NOT TO SCALE








COMMUNITY OF PHIPPSBURG

ROUTT COUNTY ENVIRONMENTAL HEALTH

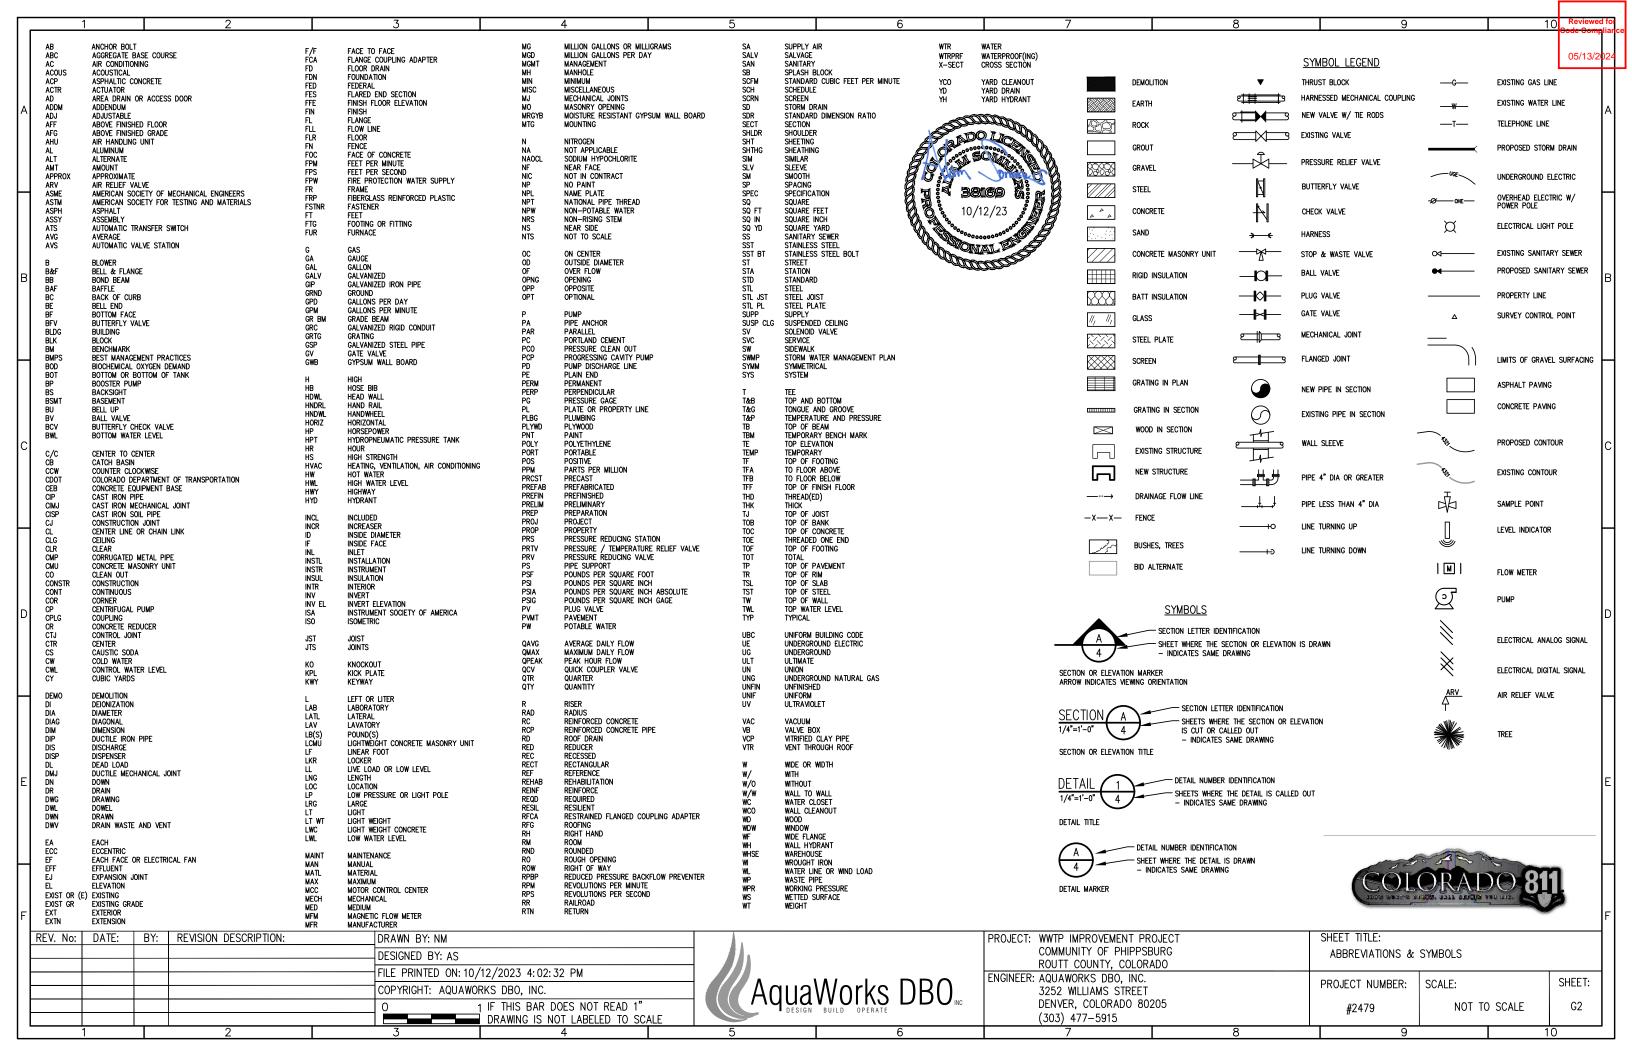

GENERAL NOTES:

- 1. PROJECT ADDRESS: 22158 COUNTY RD 12. PHIPPSBURG, CO 80469.
- 2. PRIOR TO COMMENCEMENT OF ANY CONSTRUCTION. THE CONTRACTOR SHALL GIVE THE OWNER SEVENTY-TWO (72) HOURS ADVANCE NOTICE.
- 3. NO BELOW GRADE UTILITIES WERE LOCATED FOR THIS PLAN SET, CONTRACTOR IS RESPONSIBLE TO VERIFY THE LOCATION OF ALL UTILITIES PRIOR TO CONSTRUCTION AND TO COORDINATE WITH THE APPROPRIATE UTILITY COMPANY. CONTRACTOR IS RESPONSIBLE TO PROTECT UTILITIES DURING CONSTRUCTION. IF A CONFLICT EXISTS AND/OR A DESIGN MODIFICATION IS REQUIRED, OWNER AND CONTRACTOR SHALL COORDINATE WITH ENGINEER TO MODIFY THE DESIGN. DESIGN MODIFICATION(S) MUST BE APPROVED BY THE OWNER PRIOR TO BEGINNING CONSTRUCTION AFFECTED. FOR UTILITY LOCATE INFORMATION, CONTACT UNCC: (800) 922-1987.
- ACTUAL LOCATIONS, DISTANCES, AND ELEVATIONS WILL BE GOVERNED BY ACTUAL FIELD CONDITIONS. CONTRACTOR TO FIELD VERIFY CONDITIONS AND REPORT ANY DISCREPANCIES TO THE
- 5 CONTRACTOR SHALL BE REQUIRED TO RESTORE THE ROUTE OF WORK AND ANY DAMAGED EXISTING LANDSCAPE, STRUCTURES, OR IMPROVEMENTS AS THE RESULT OF WORK TO ORIGINAL CONDITION OR BETTER PRIOR TO ACCEPTANCE OF WORK. CONTRACTOR RESPONSIBLE FOR RESTORING SITE TO PRE-CONSTRUCTION CONDITION.
- 6. NO UTILITY SERVICE MAY BE DISCONNECTED WITHOUT PRIOR APPROVAL OF THE OWNER OR OWNER'S REPRESENTATIVE.
- 7. CONTRACTOR TO PROVIDE AND MAINTAIN TEMPORARY PORTABLE RESTROOM FACILITIES FOR THE DURATION OF THE PROJECT.
- 8. CONTRACTOR SHALL EXHIBIT NECESSARY SAFETY PRECAUTIONS DURING CONSTRUCTION, WHICH INCLUDES, BUT IS NOT LIMITED TO, SIGNAGE, SECURITY, AND EXCAVATION AS SET FORTH BY OSHA, PUBLICATION 2226, "EXCAVATION AND TRENCHING OPERATIONS."
- 9. CONTRACTOR SHALL BE RESPONSIBLE FOR THE PROCUREMENT OF ALL PERMITS NECESSARY FOR THE CONSTRUCTION OF THE IMPROVEMENTS SHOWN.
- 10. CONTRACTOR SHALL VERIFY INVERT ELEVATIONS OF EXISTING MANHOLES, SEWER PIPES, STRUCTURES, AND OUTFALLS PRIOR TO CONSTRUCTION.
- 11. THE CONTRACTOR SHALL MAINTAIN ON SITE A FULL SET OF CONSTRUCTION DRAWINGS. RECORDING ALL INFORMATION PERTAINING TO THE CONSTRUCTION OF THE WASTEWATER TREATMENT PLANT IMPROVEMENTS. THESE RECORD DRAWINGS SHALL BE PROVIDED TO THE OWNER UPON COMPLETION OF THE PROJECT.
- 12. HORIZONTAL AND VERTICAL DEFLECTION OF THE PIPES SHALL NOT EXCEED MANUFACTURER'S RECOMMENDATIONS FOR THE PIPE MATERIAL AND TEST PRESSURE SPECIFIED.
- 13. CONTRACTOR SHALL NOT SCALE FROM DRAWINGS FOR CONSTRUCTION PURPOSES. ANY MISSING DIMENSIONS OR DISCREPANCIES IN PLANS, FIELD STAKING, FIELD CONDITIONS OR PHYSICAL FEATURES SHALL BE BROUGHT TO THE ATTENTION OF THE ENGINEER. IF CONTRACTOR PROCEEDS WITH THE WORK WITHOUT NOTIFYING ENGINEER HE DOES SO AT HIS OWN RISK.
- 14. IF CONFLICTS, QUESTIONS OR INTERPRETATION ARE REQUIRED CONTACT THE ENGINEER IN WRITING WITH A REQUEST FOR INFORMATION (RFI).

BUILDING REQUIREMENTS:

- 1. CONTRACTOR TO CONFORM TO CURRENT EDITION IBC, ROUTT COUNTY BUILDING CODES, AND OTHER APPLICABLE LOCAL CODES.
- 2. MAINTAIN EXISTING PORTABLE FIRE EXTINGUISHERS THROUGHOUT THE BUILDING PER IFC AND NFPA 10.

REQUIREMENTS:

ALL MATERIALS FOR POTABLE WATER SERVICE SHALL BE NSF 61 CERTIFIED DISINFECTION SYSTEMS B300-04 AWWA STANDARD FOR HYPOCHLORITES

- 1. CONTRACTOR TO COORDINATE MODIFICATIONS TO EXISTING ELECTRICAL SERVICE WITH UTILITY AND OWNER.
- 2. REFER TO ELECTRICAL DRAWINGS.

- 1. CONTRACTOR TO PROVIDE ALL SUPPORTS AS REQUIRED.
- 2. ALL PVC PROCESS PIPING SHALL BE SCH 80 UNLESS OTHERWISE NOTED.

PIPING IDENTIFICATION REQUIREMENTS:

- 1. INCLUDE FLOW DIRECTION ARROW TAPE ON ALL PIPING.
- 2. ALL PIPING SHALL EITHER BE PAINTED OR LABELED USING THE FOLLOWING COLOR SCHEDULE (NOT ALL MAY BE INCLUDED WITH THIS PROJECT):

SEWAGE DARK GRAY

SLUDGE BROWN WITH BLACK BANDS

POTABLE WATER DARK BLUE

NON-POTABLE WATER DARK BLUE WITH BLACK BANDS

RECLAIMED WATER PURPI F

CHEMICAL LINES

ALUM OR PRIMARY COAGULANT **ORANGE** AMMONIA WHITE

CARBON SLURRY **BLACK**

CAUSTIC YELLOW WITH GREEN BAND CHLORINE YELLOW

YELLOW WITH ORANGE BAND OZONE POLYMERS OR COAGULANTS ORANGE WITH GREEN BAND PURPLE WITH GREEN BAND POTASSIUM PERMANGANATE

LIGHT GREEN WITH ORANGE BAND SODA ASH

COMPRESSED AIR DARK GREEN GAS

RED





SYSTEM OWNER:

COMMUNITY OF PHIPPSBURG MR. SCOTT COWMAN

136 6TH STREET STEAMBOAT SPRINGS, CO 80487 ROUTT COUNTY ENVIRONMENTAL HEALTH 05/13/2

(970)870-5588

CIVIL PROCESS ENGINEER:

AQUAWORKS DBO, INC. MR. ADAM SOMMERS, P.E. 3252 WILLIAMS STREET DENVER, CO 80205 (303)477 - 5915

STRUCTURAL ENGINEER:


WALLACE STRUCTURAL CONSULTANTS MR. STEVE JACOB, P.E. 9800 PYRAMID CT, #305 ENGLEWOOD, CO 80112 (918)806 - 7339

ELECTRICAL ENGINEER:

DYNAMIC MEP CONSULTING ENGINEERS MR. MIKE BRUNGARDT, P.E. PO BOX 280782 DENVER, CO 80228 (303)421 - 3208

OPERATOR IN RESPONSIBLE CHARGE:

MR. SCOTT SMITH PO BOX 1078 CLARK, CO 80428 (970)846-9732

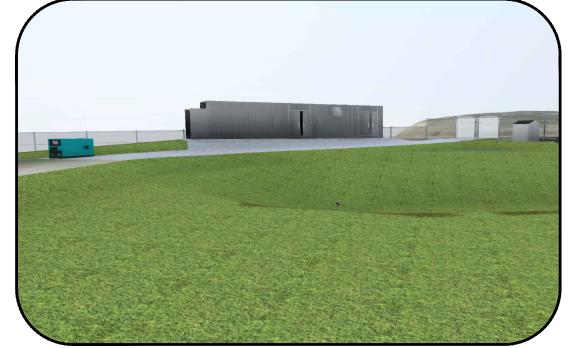

PROJECT VIEW

		N


NIO			
PROJECT: WWTP IMPROVEMENT PROJECT COMMUNITY OF PHIPPSBURG ROUTT COUNTY, COLORADO	SHEET TITLE: GENERAL NOTES &	REQUIREMENTS	
ENGINEER: AQUAWORKS DBO, INC. 3252 WILLIAMS STREET	PROJECT NUMBER:	SCALE:	SHEET:
DENVER, COLORADO 80205 (303) 477-5915	#2479	NOT TO SCALE	G3


REV. No:	DATE:	BY:	REVISION DESCRIPTION:	DRAWN BY: NM
				DESIGNED BY: AS
				FILE PRINTED ON: 10/12/2023 4:02:34 PM
				COPYRIGHT: AQUAWORKS DBO, INC.
				O 1 IF THIS BAR DOES NOT READ 1"
				DRAWING IS NOT LABELED TO SCALE


COPYRIGHT: AQUAWORKS DBO, INC.


O 1 IF THIS BAR DOES NOT READ 1"
DRAWING IS NOT LABELED TO SCALE

O 3 4 5 6 7 8 9 10

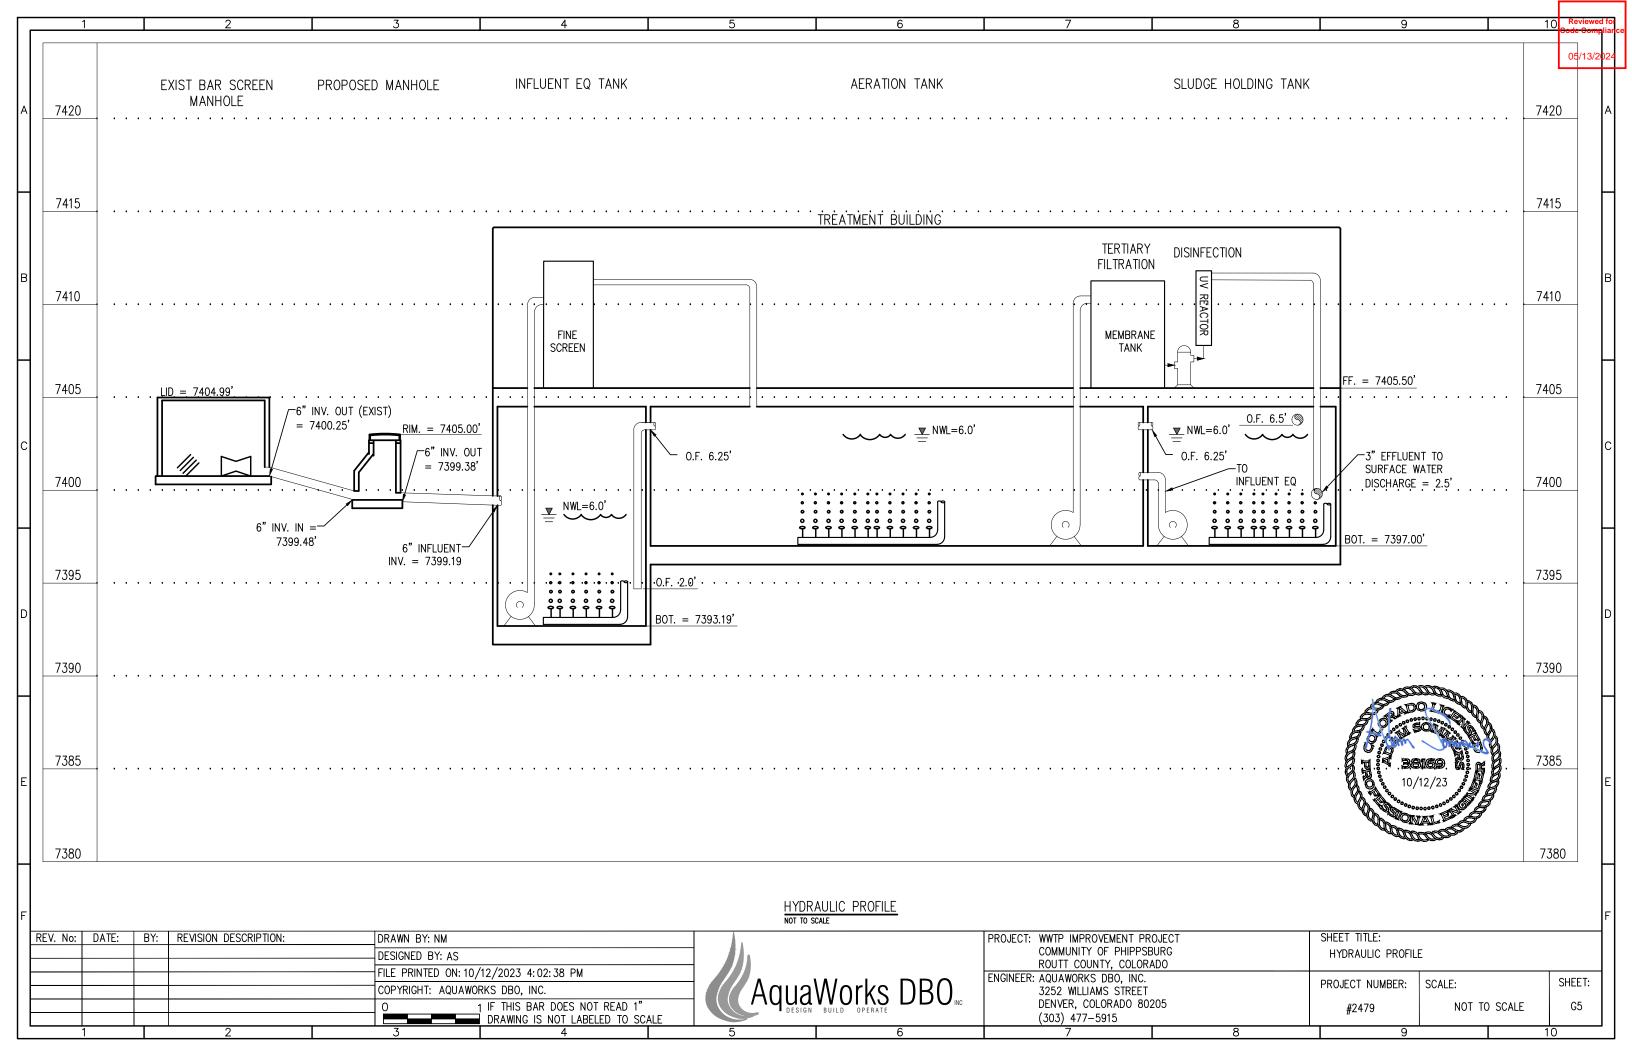


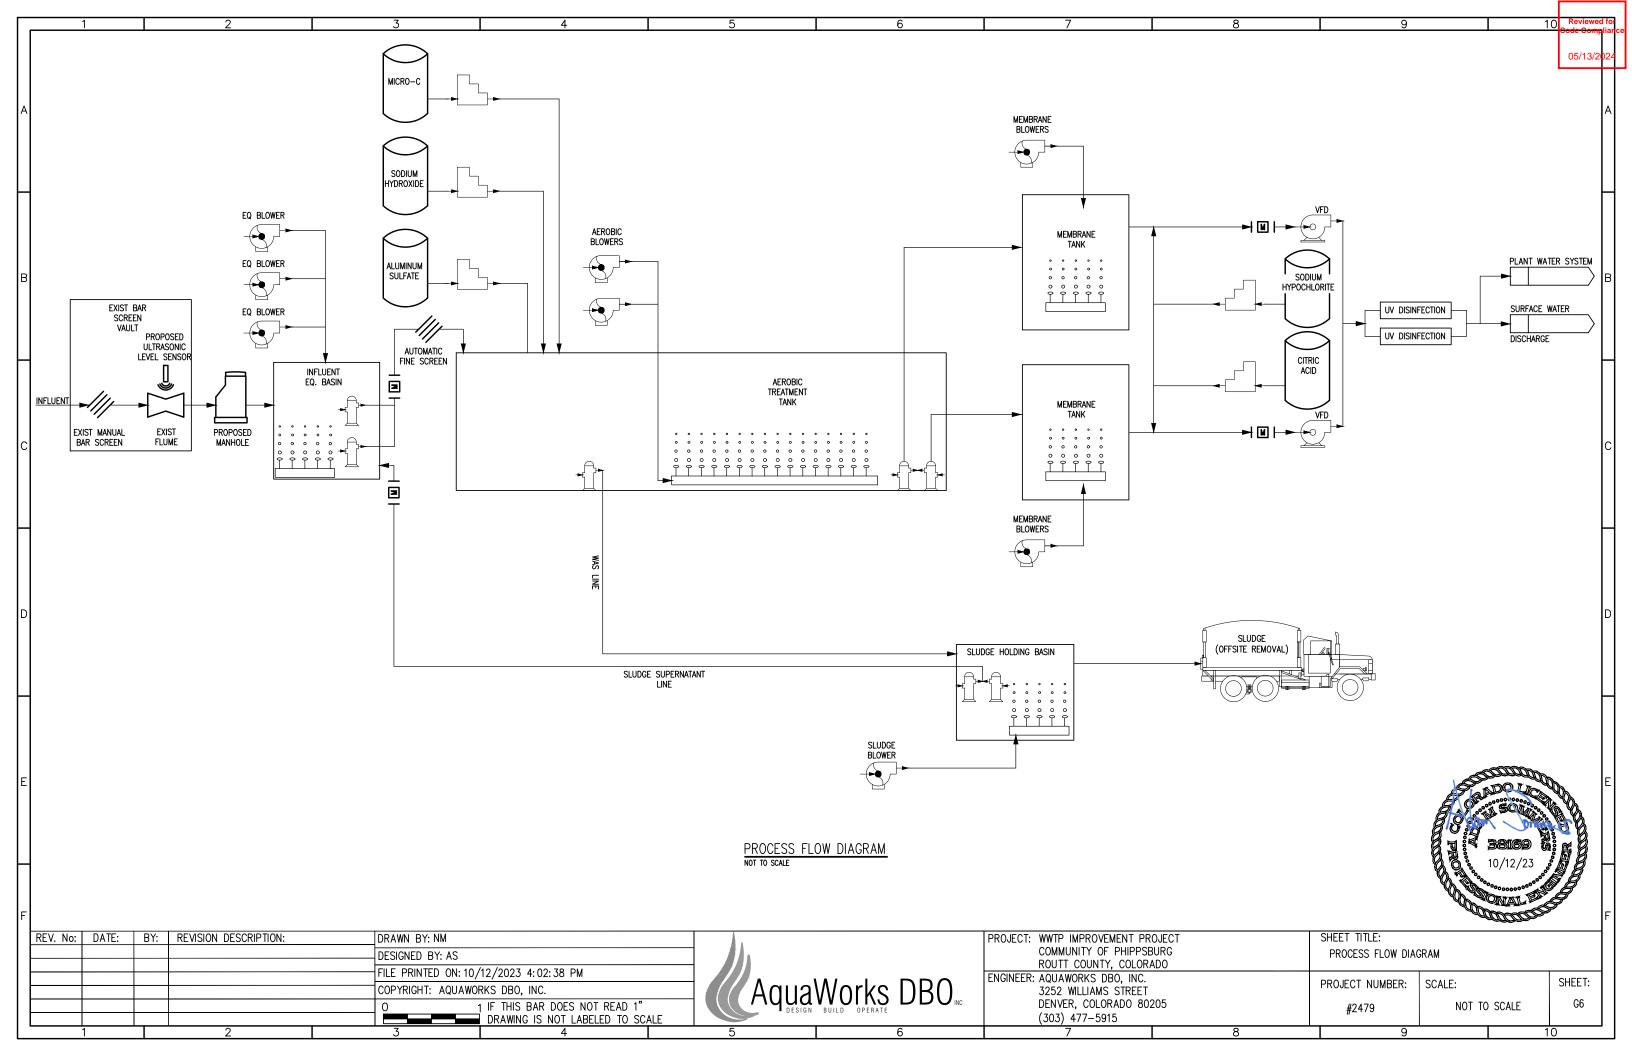


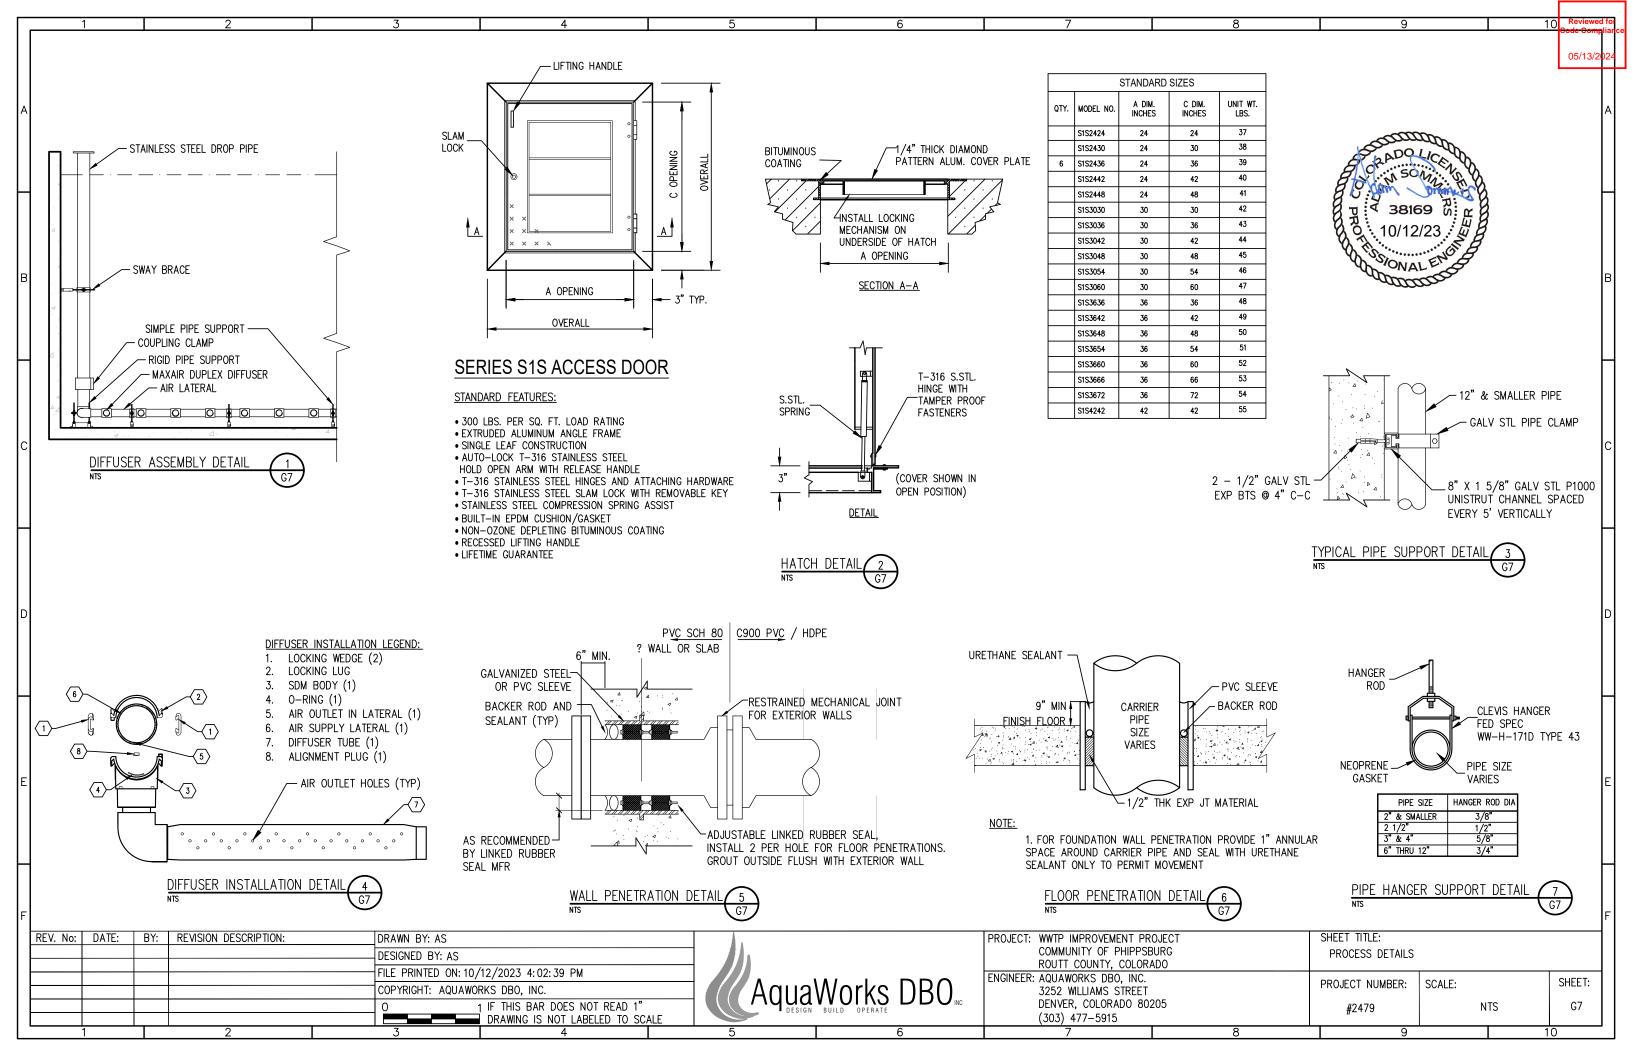


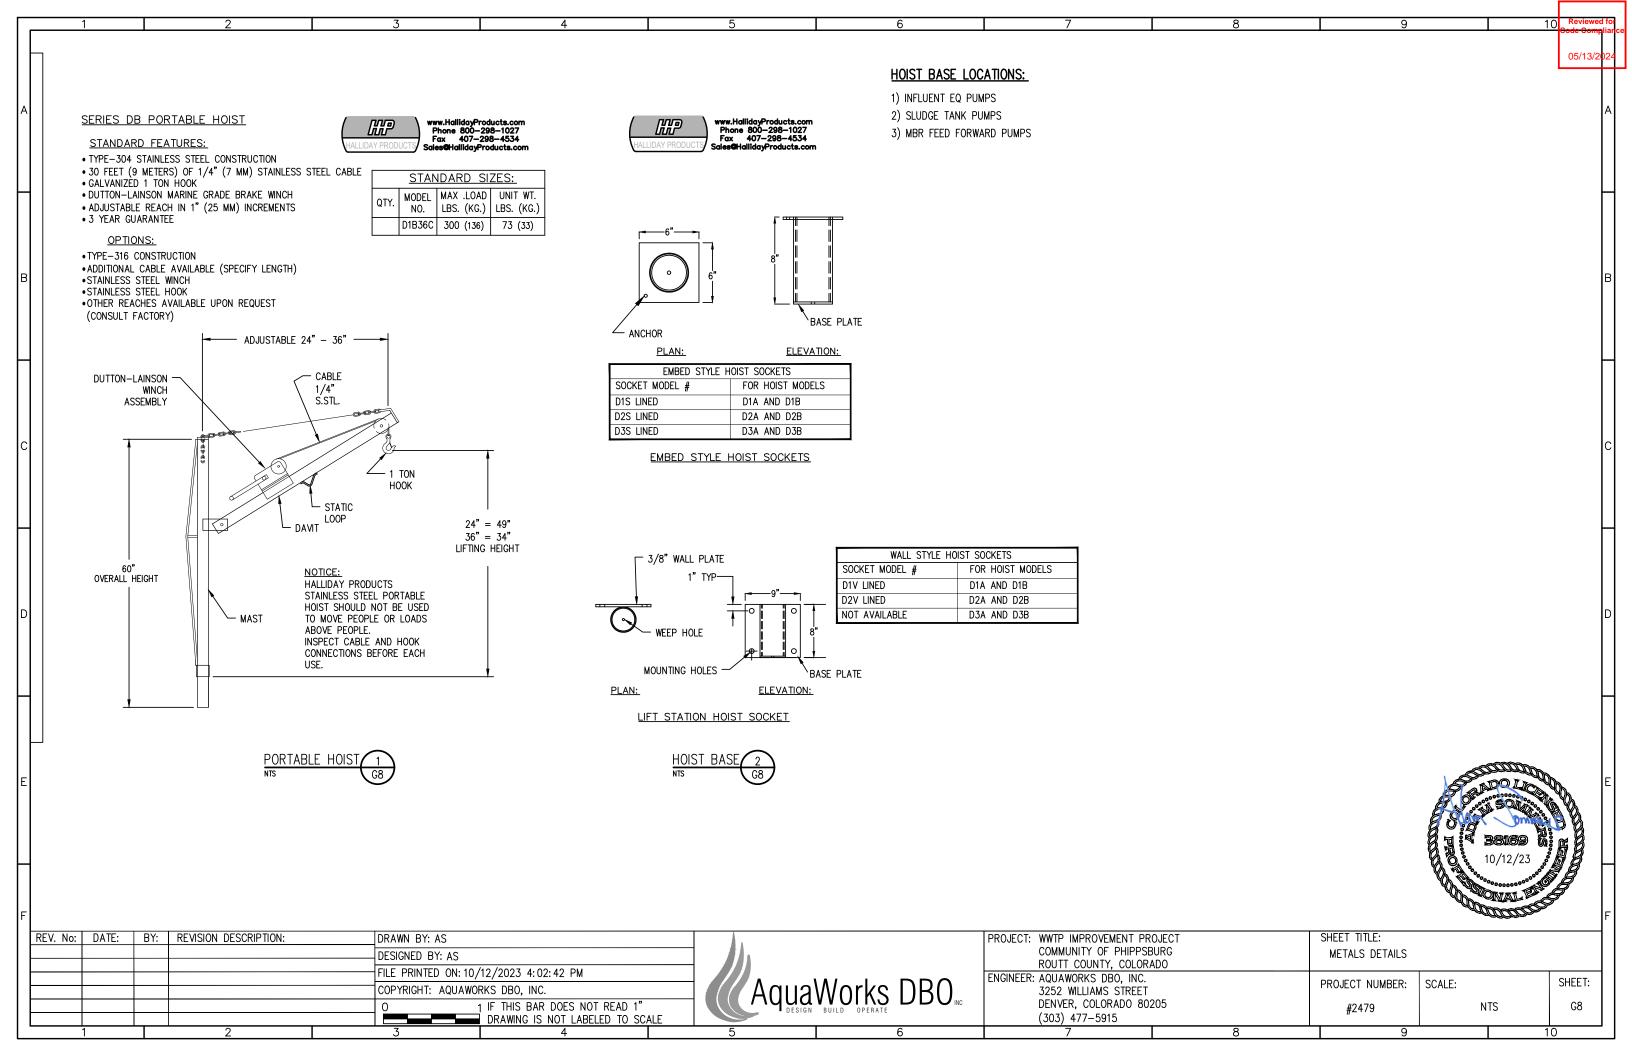





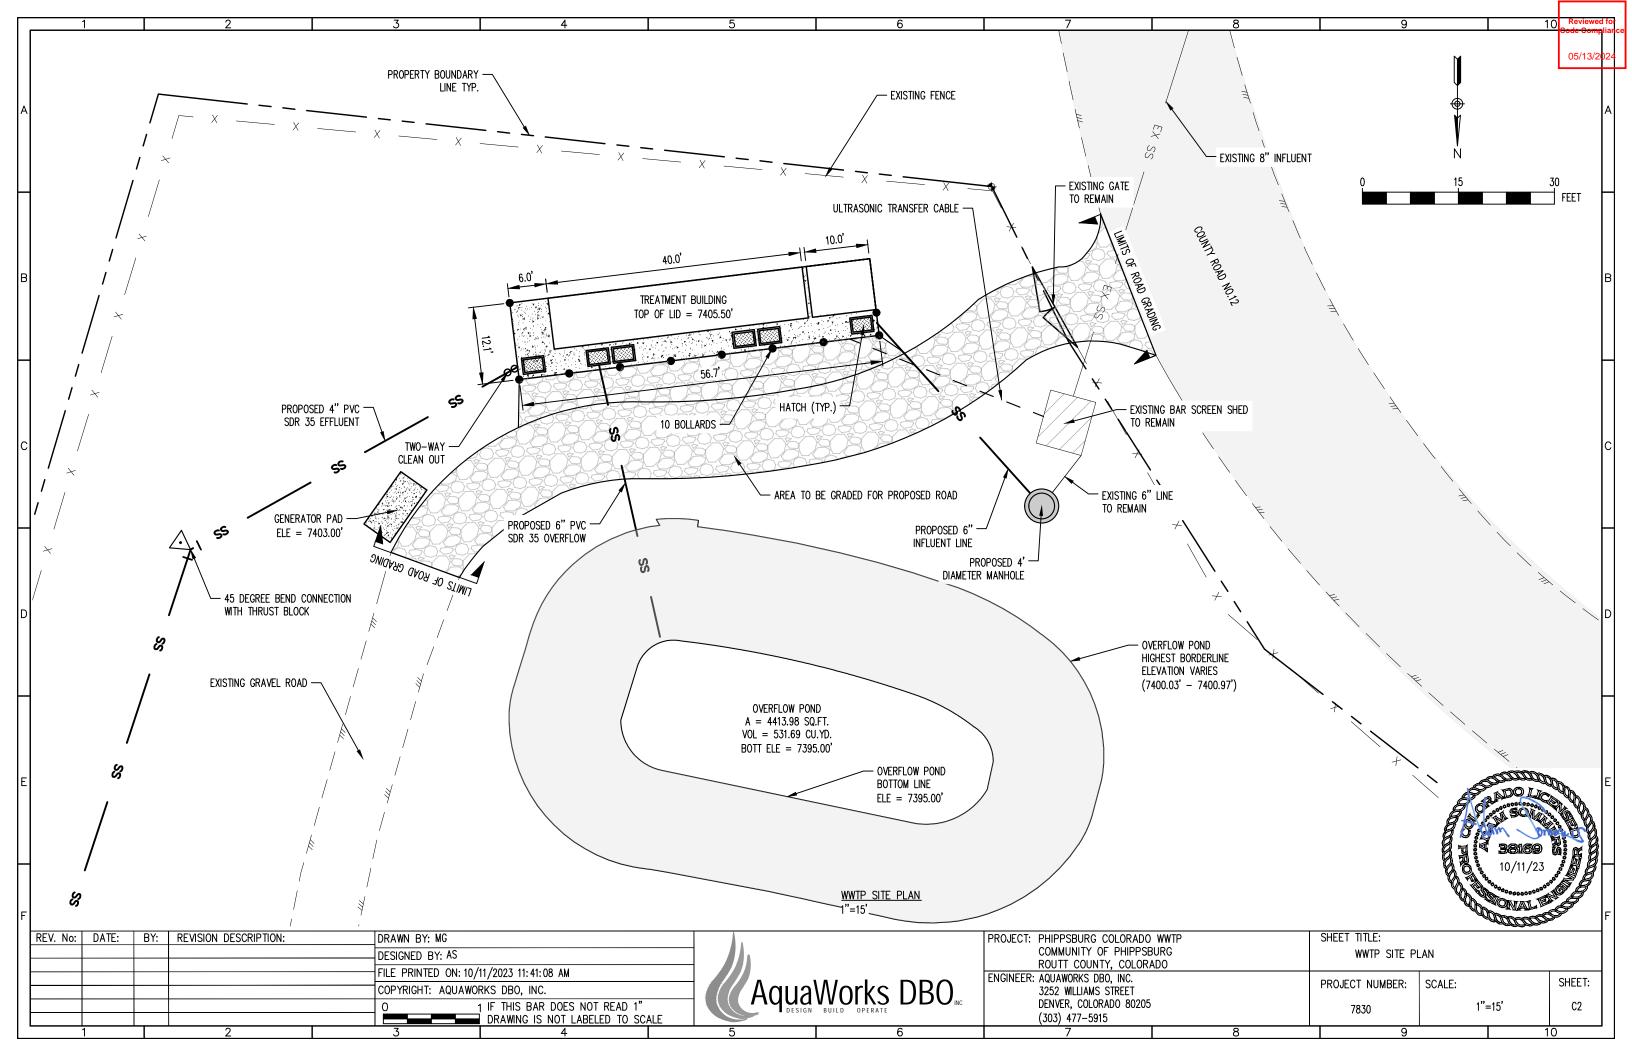


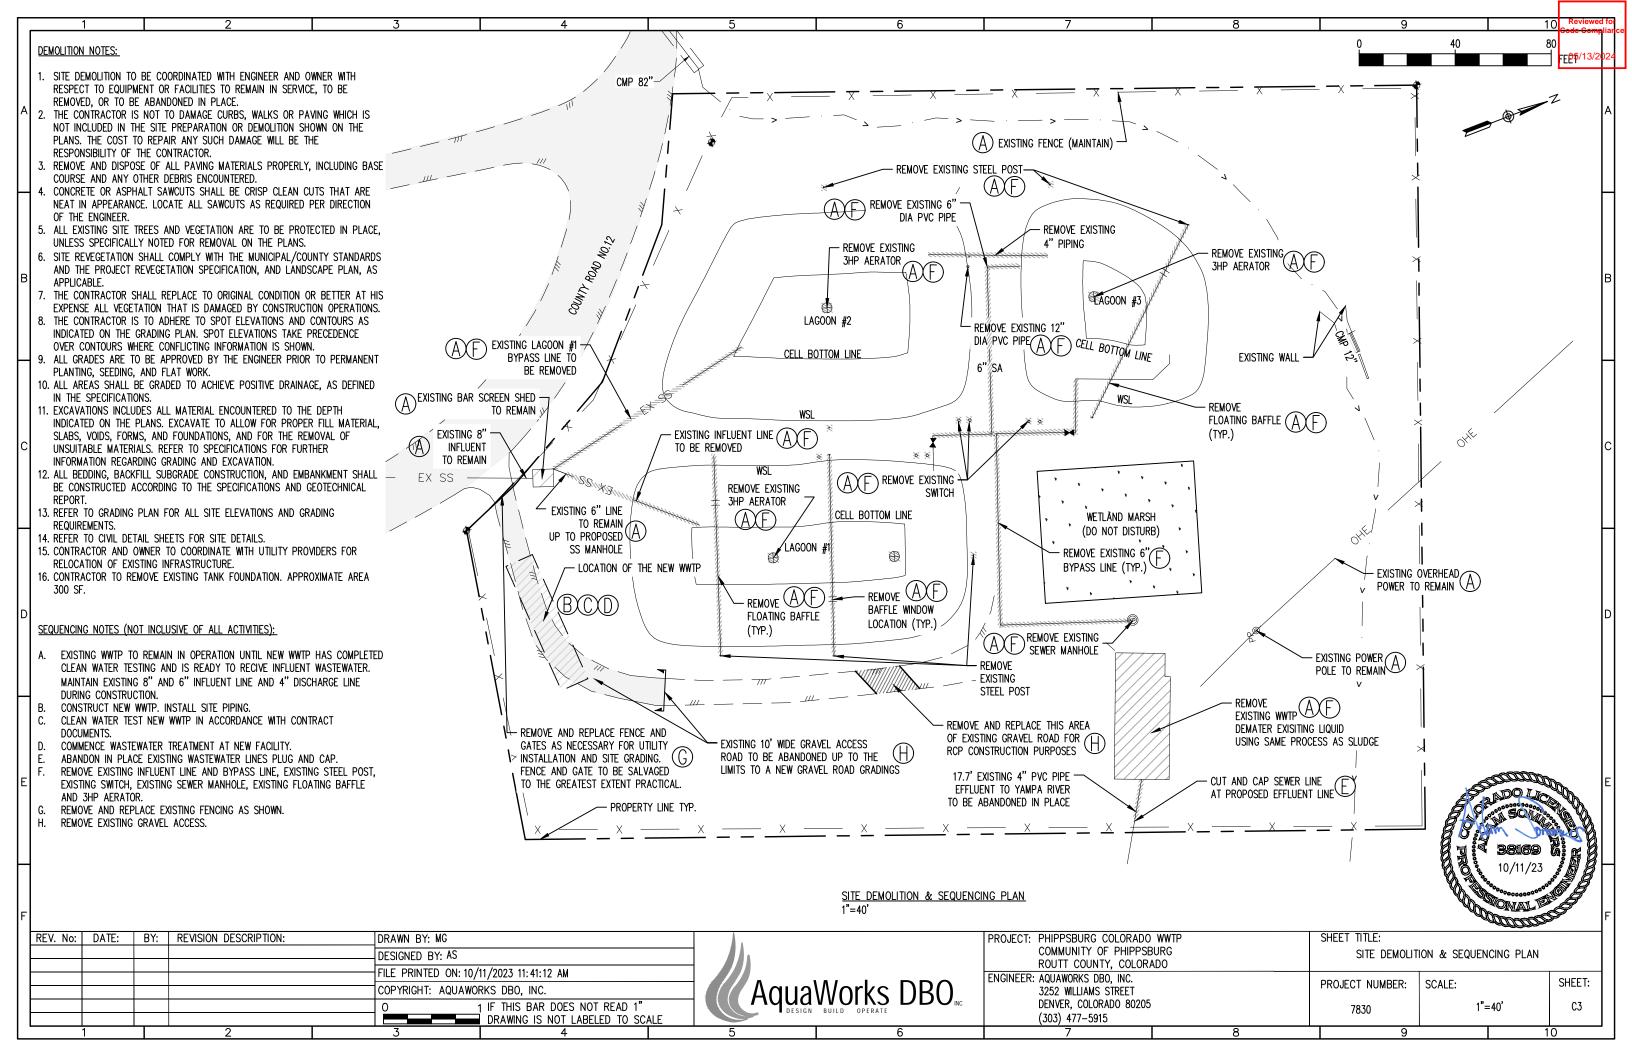


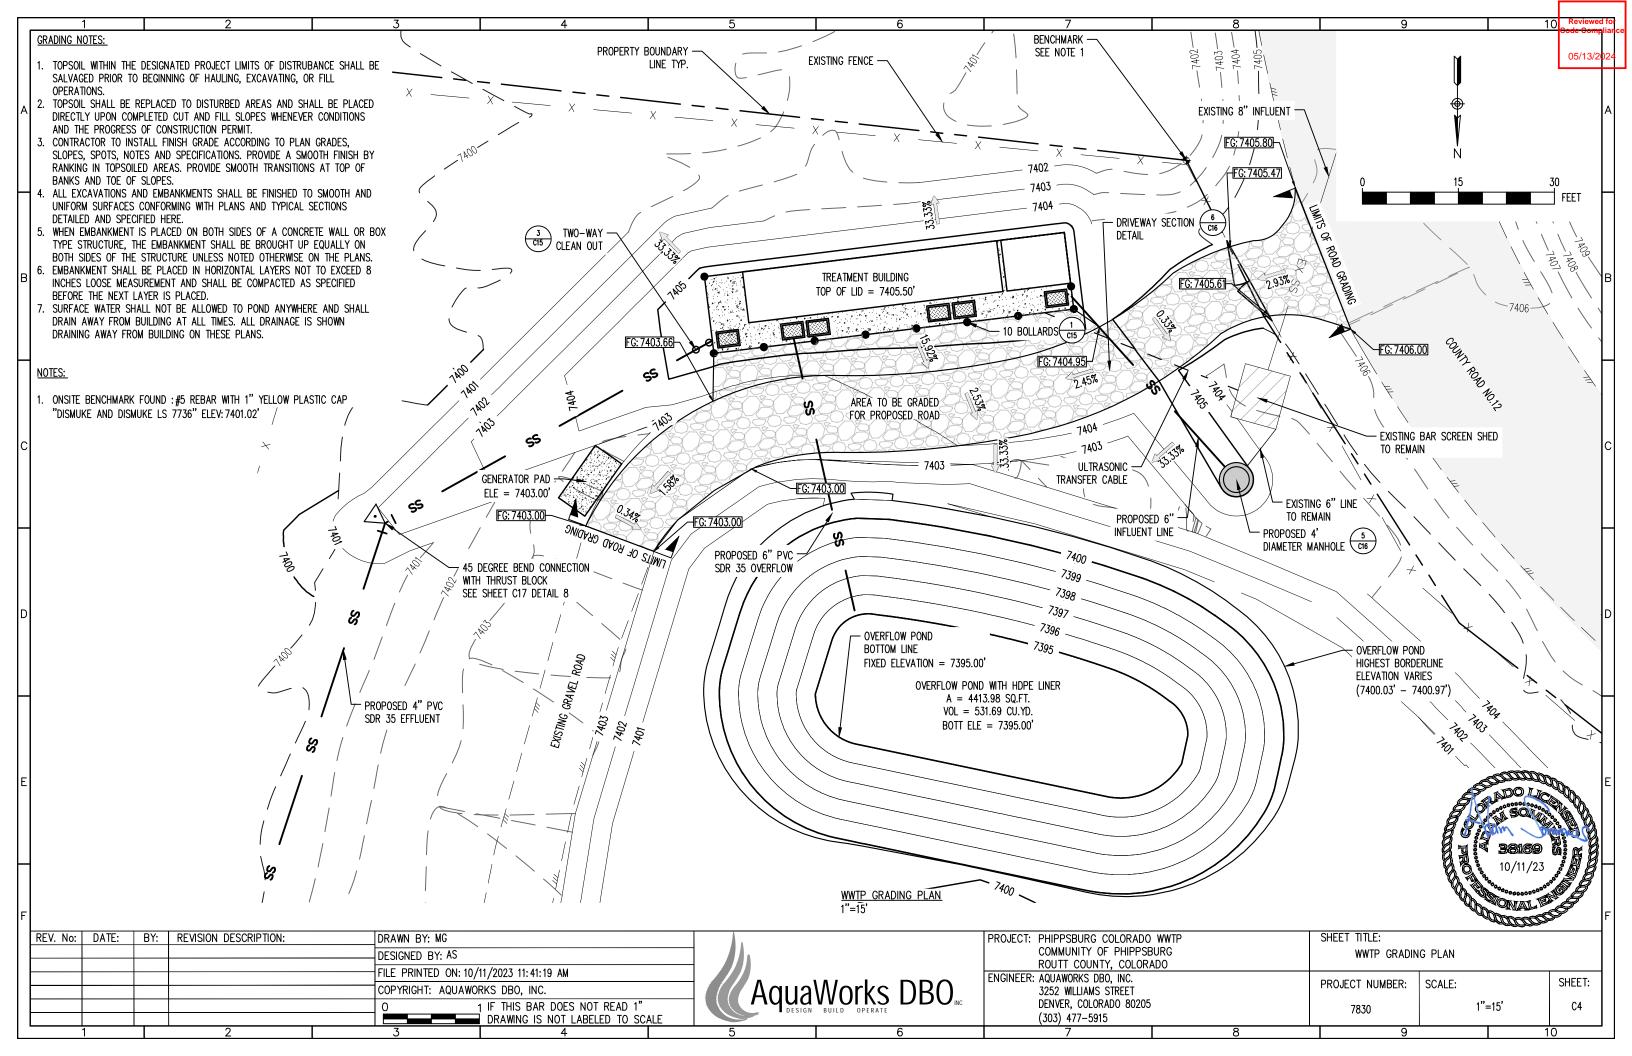


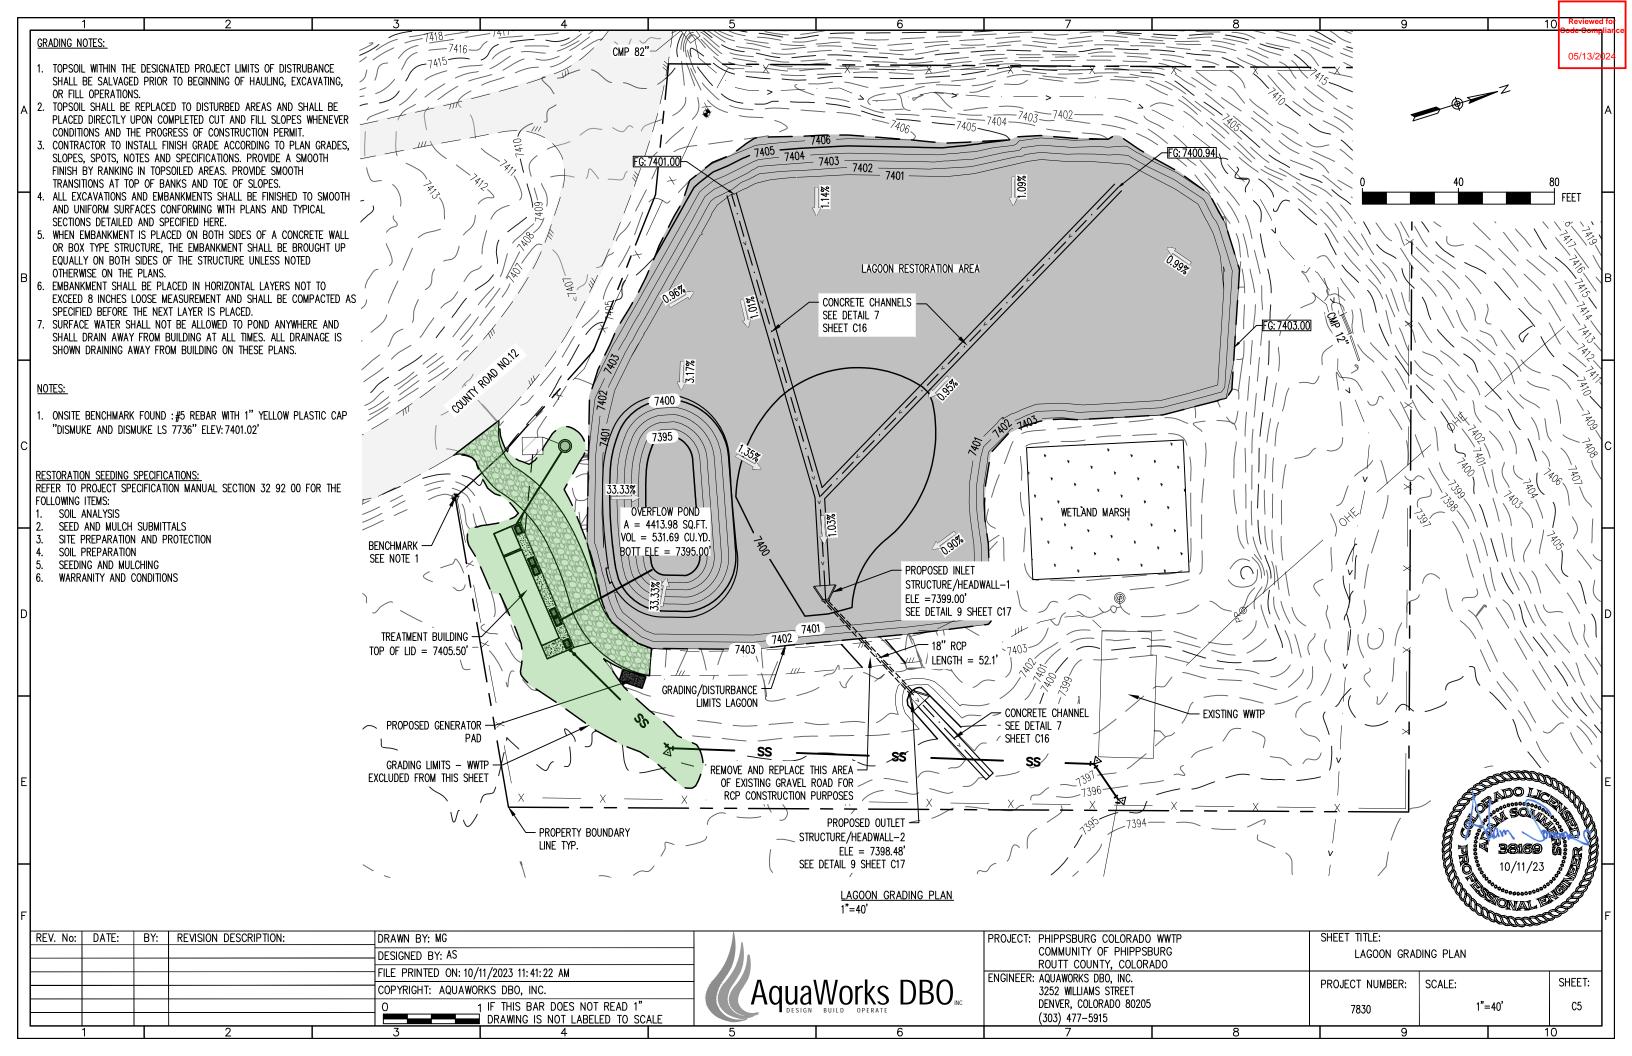


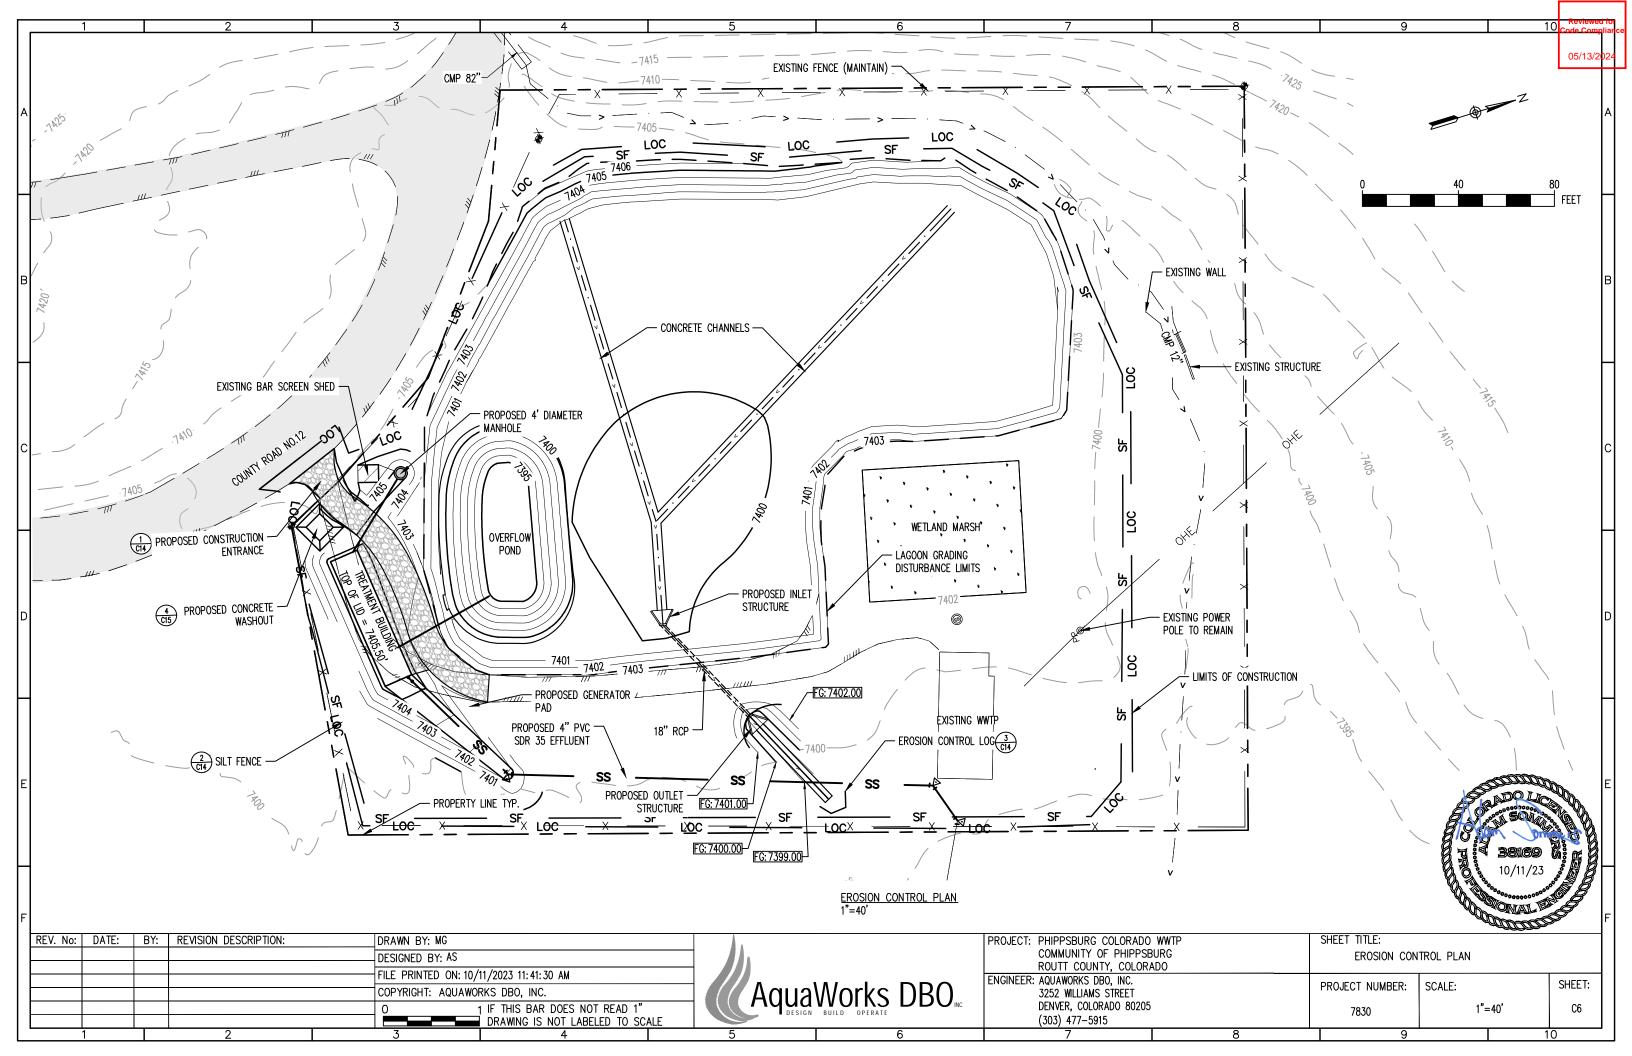


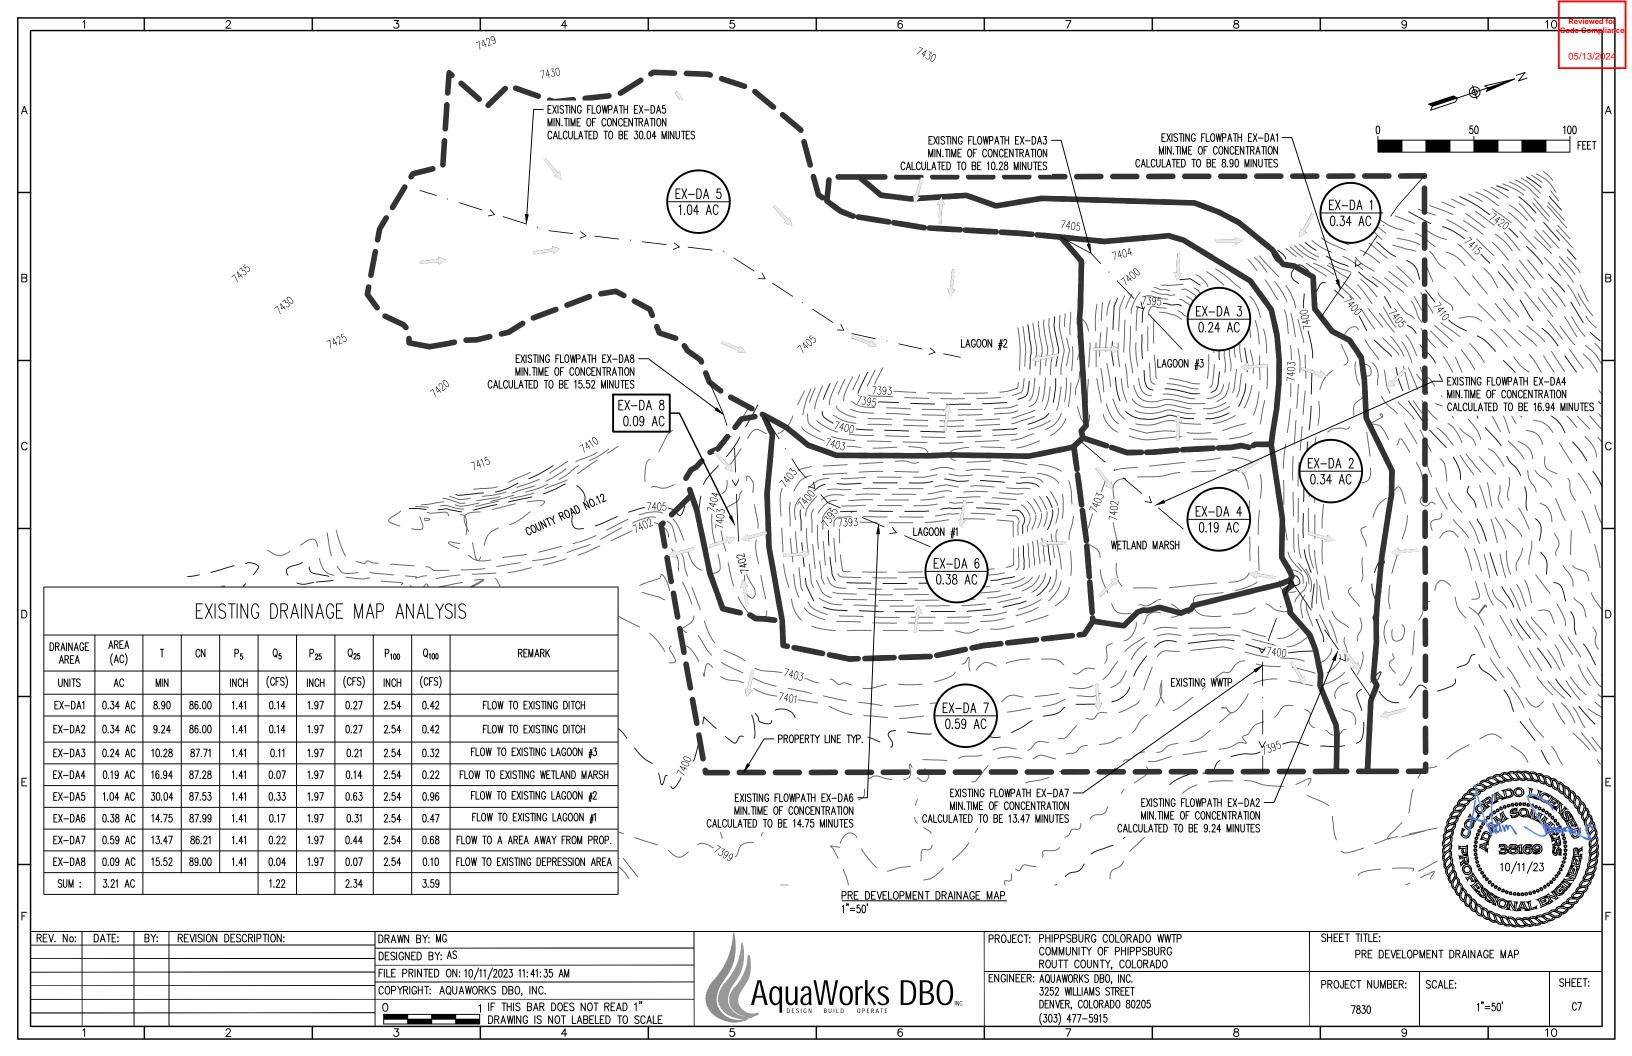


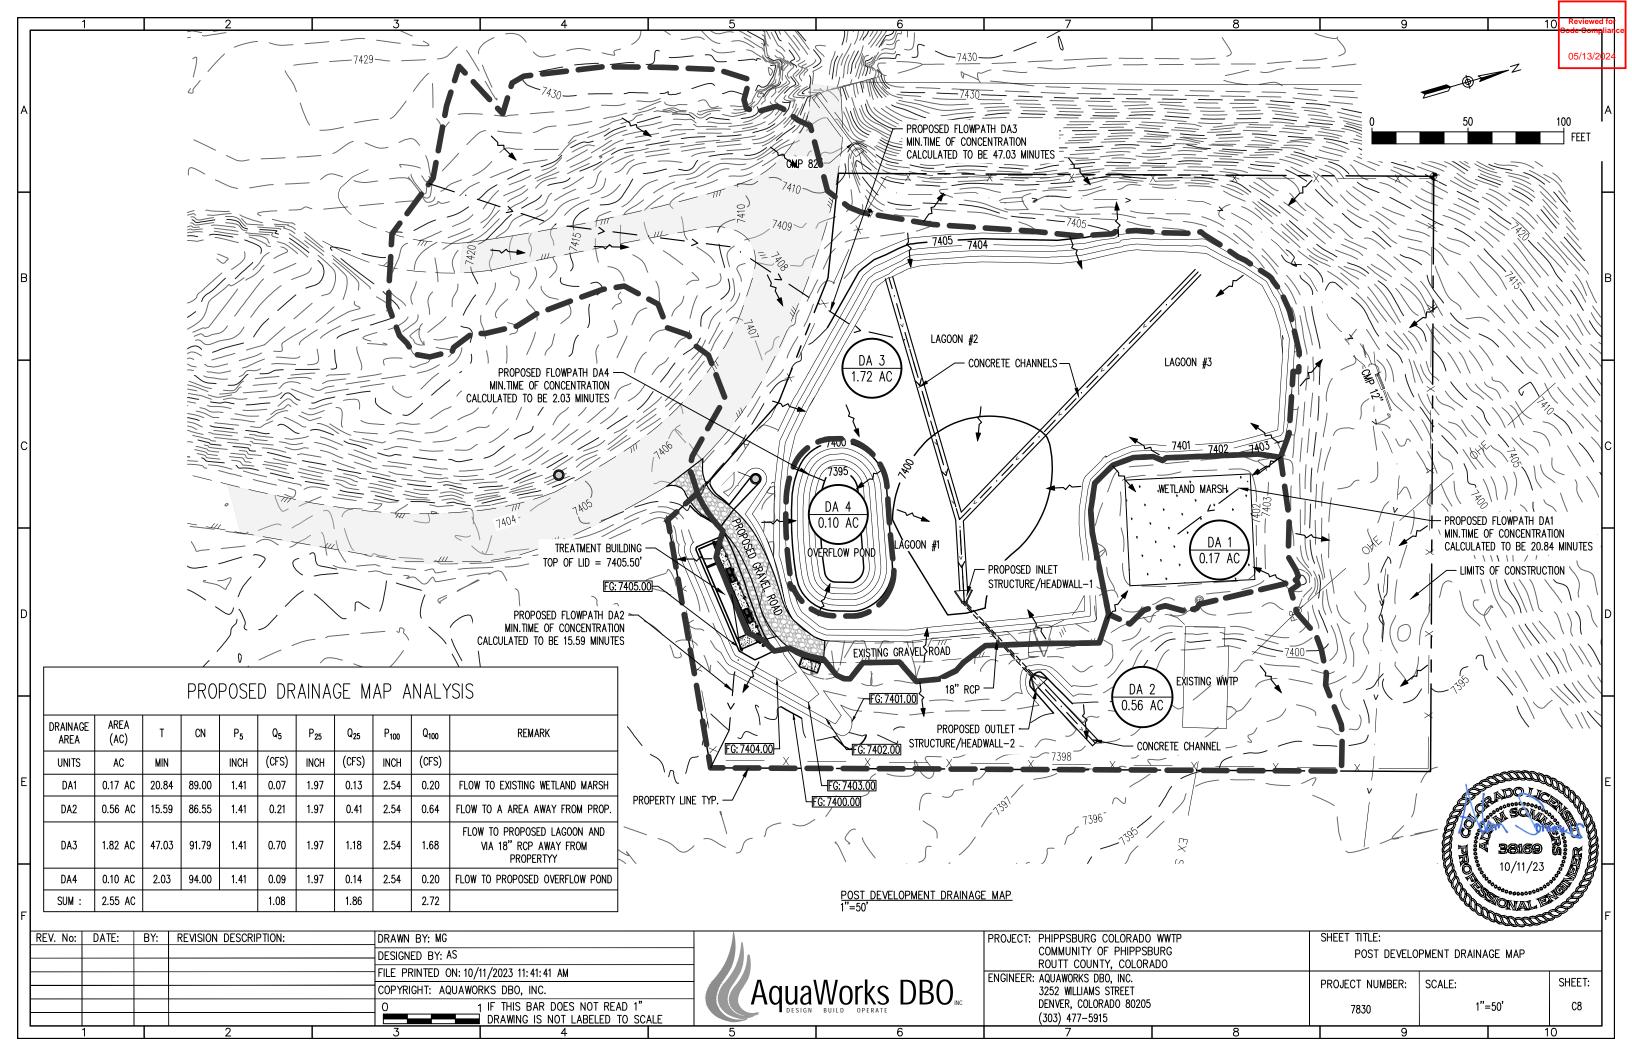


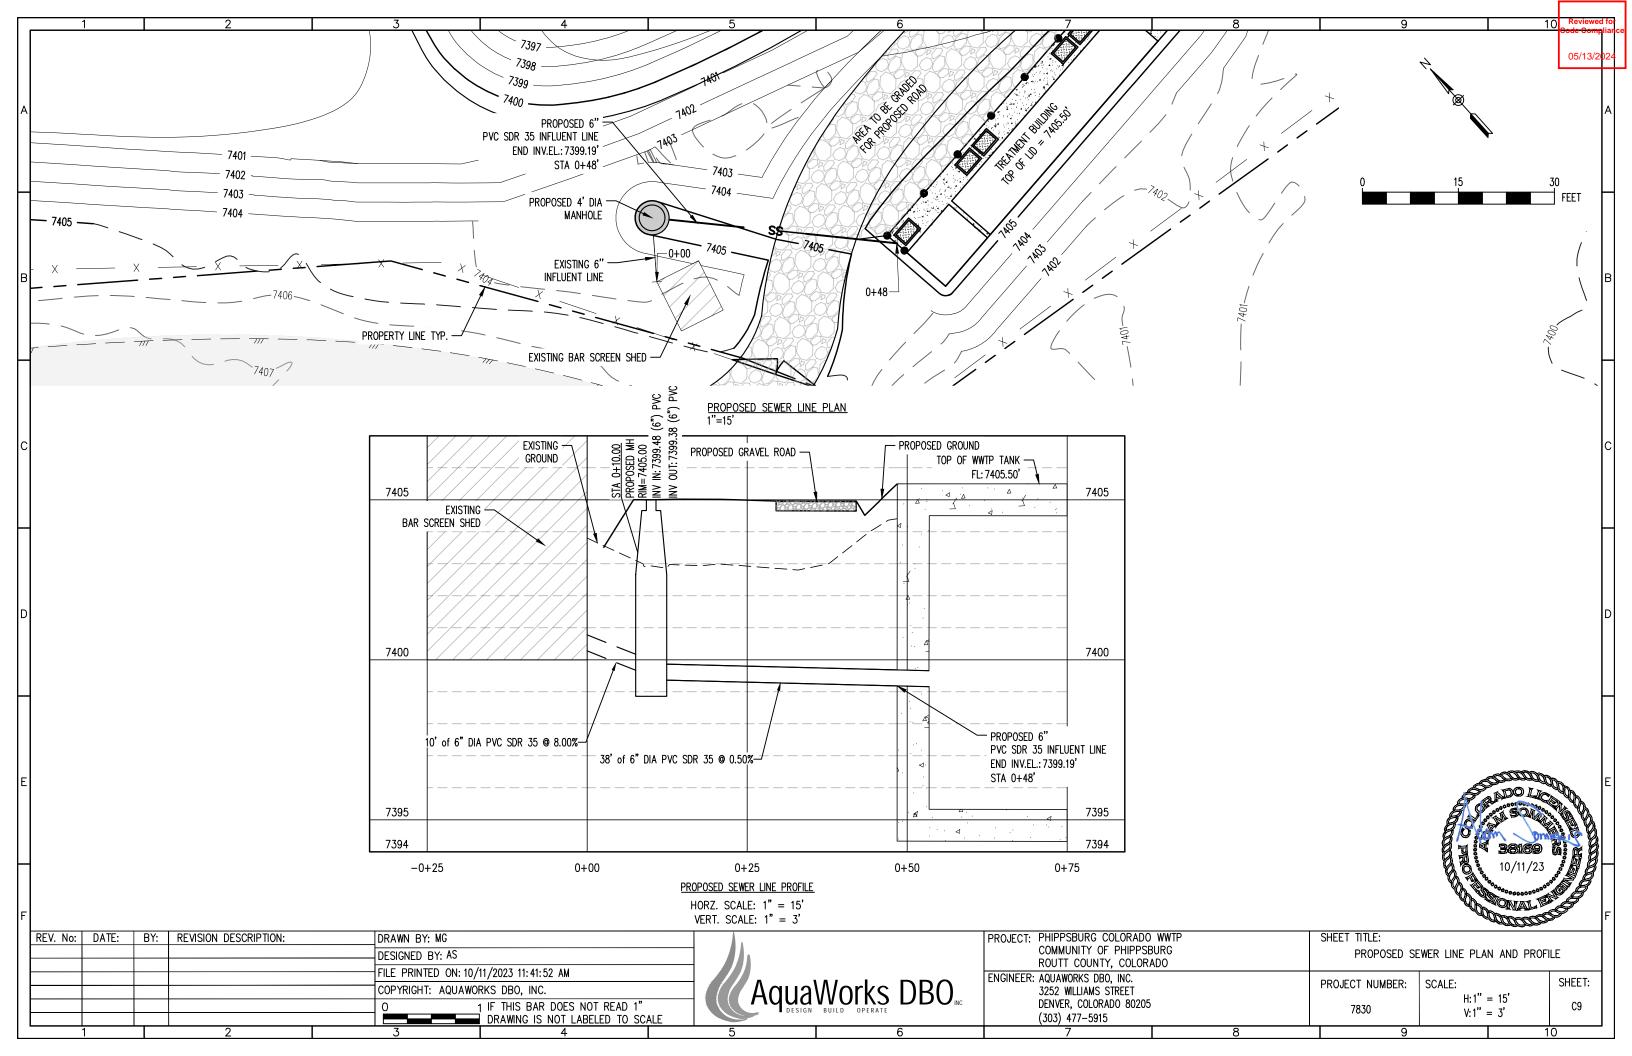


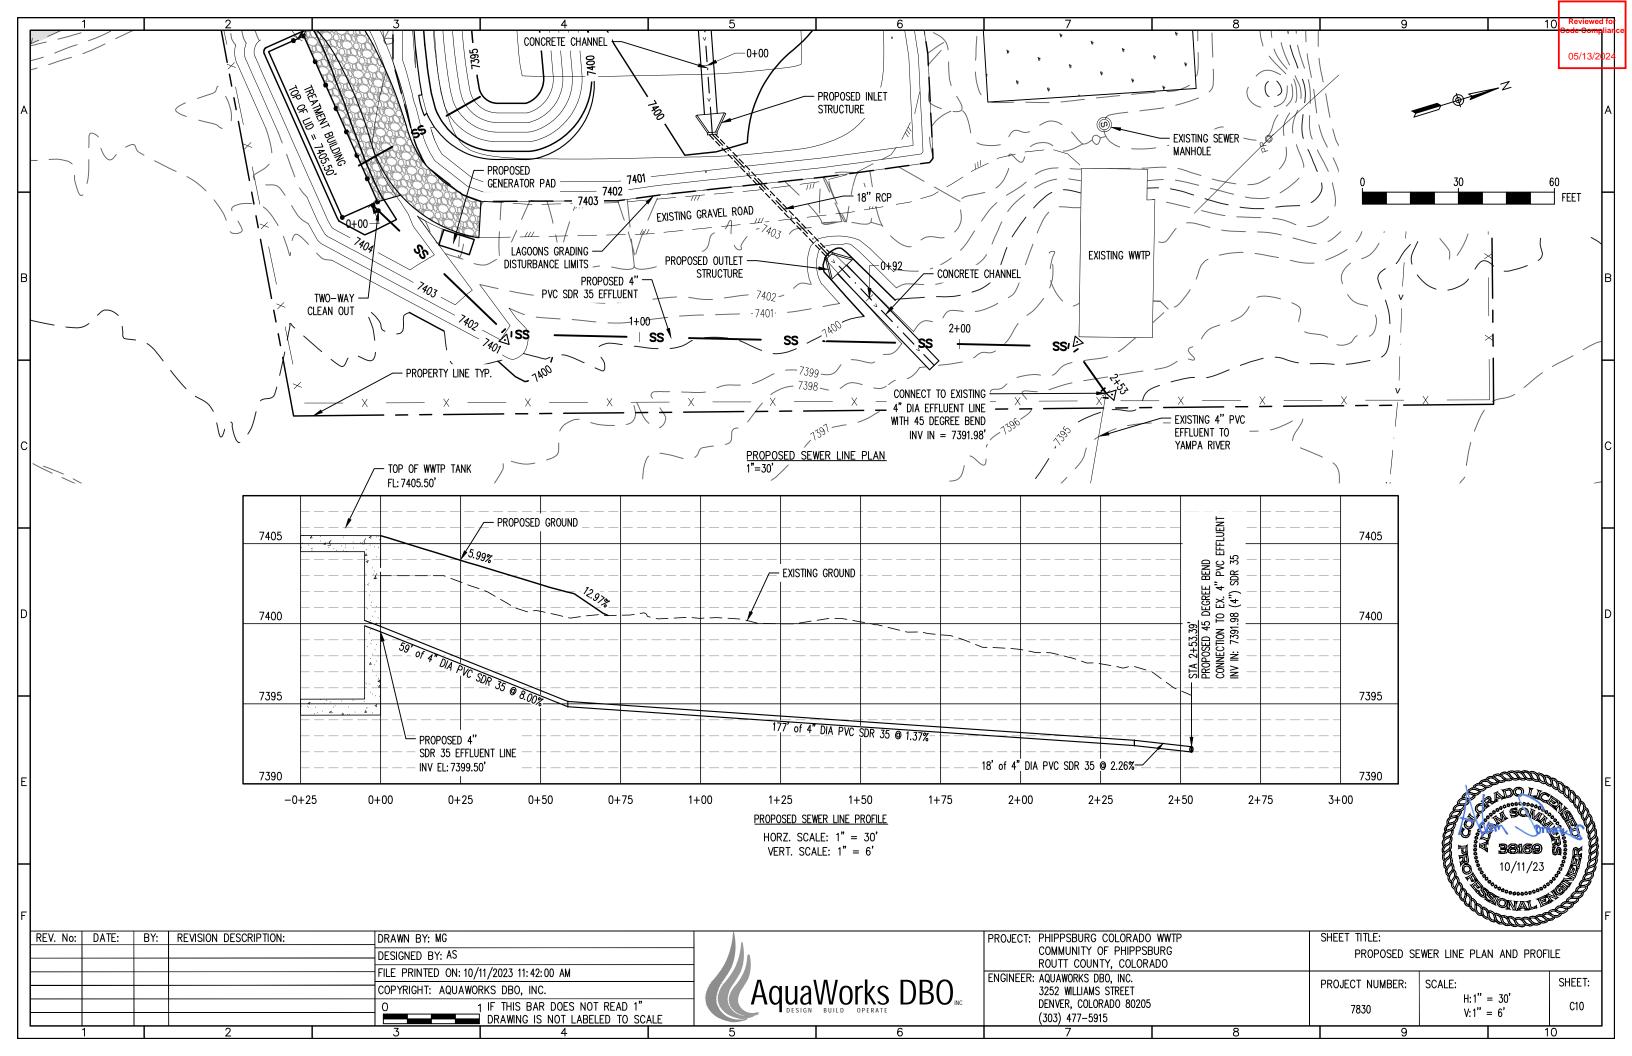


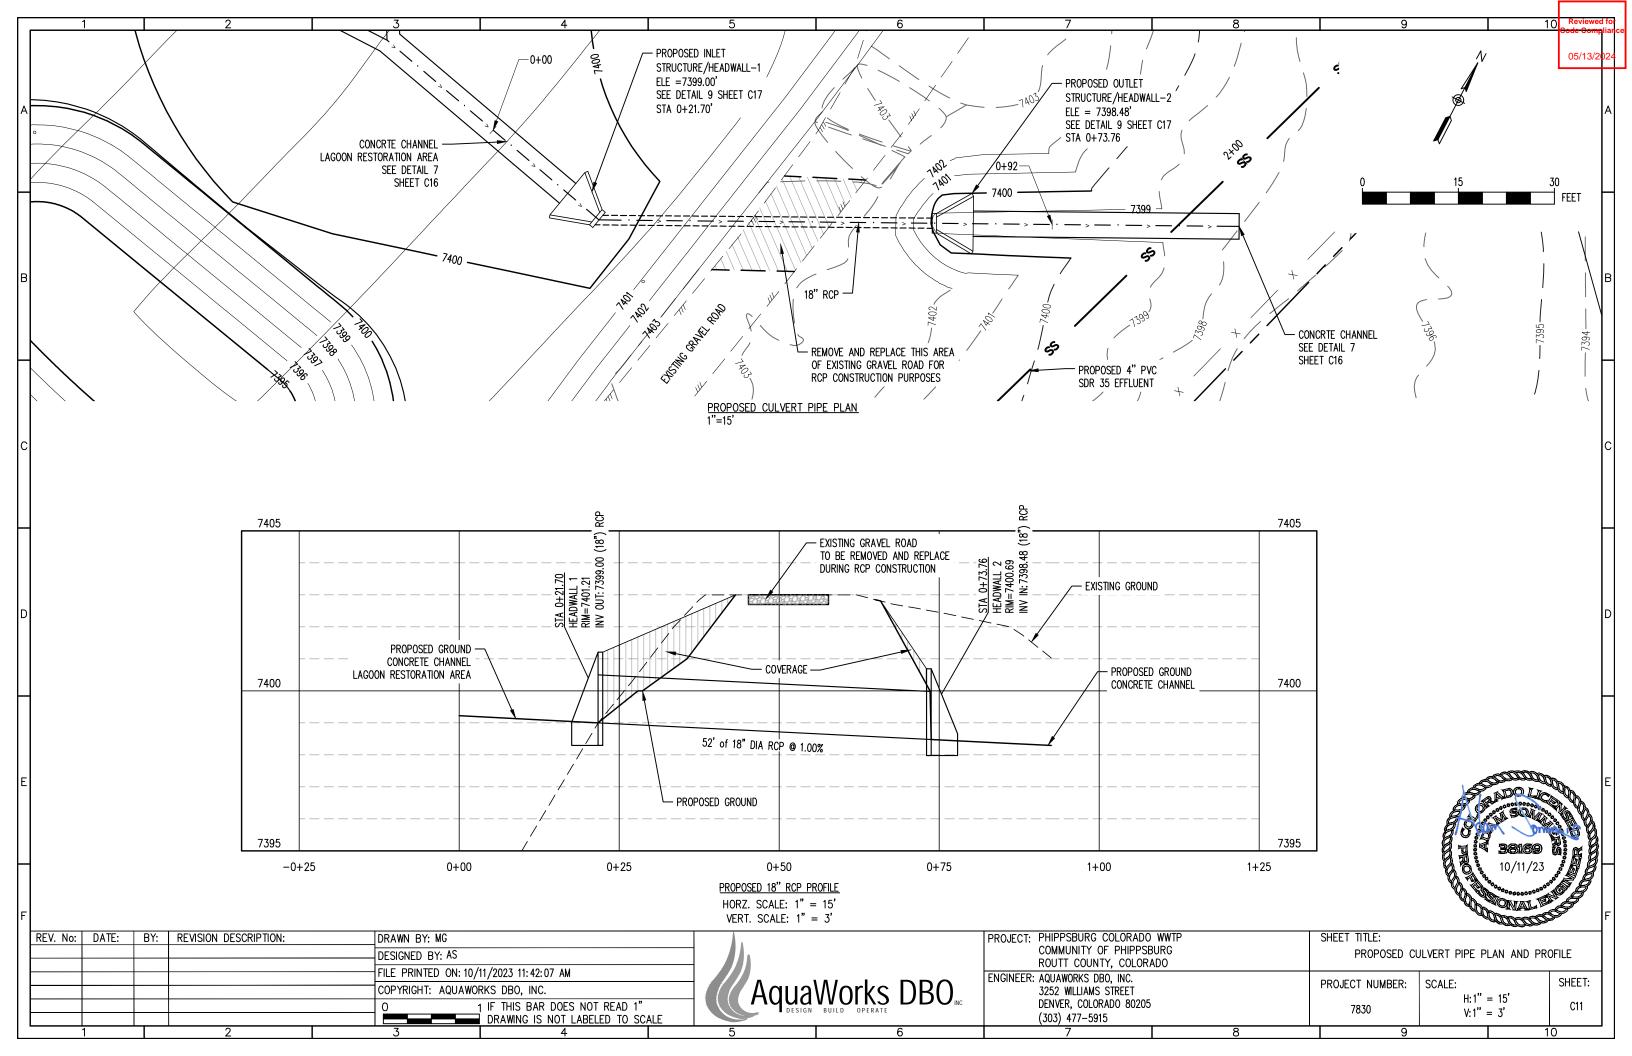


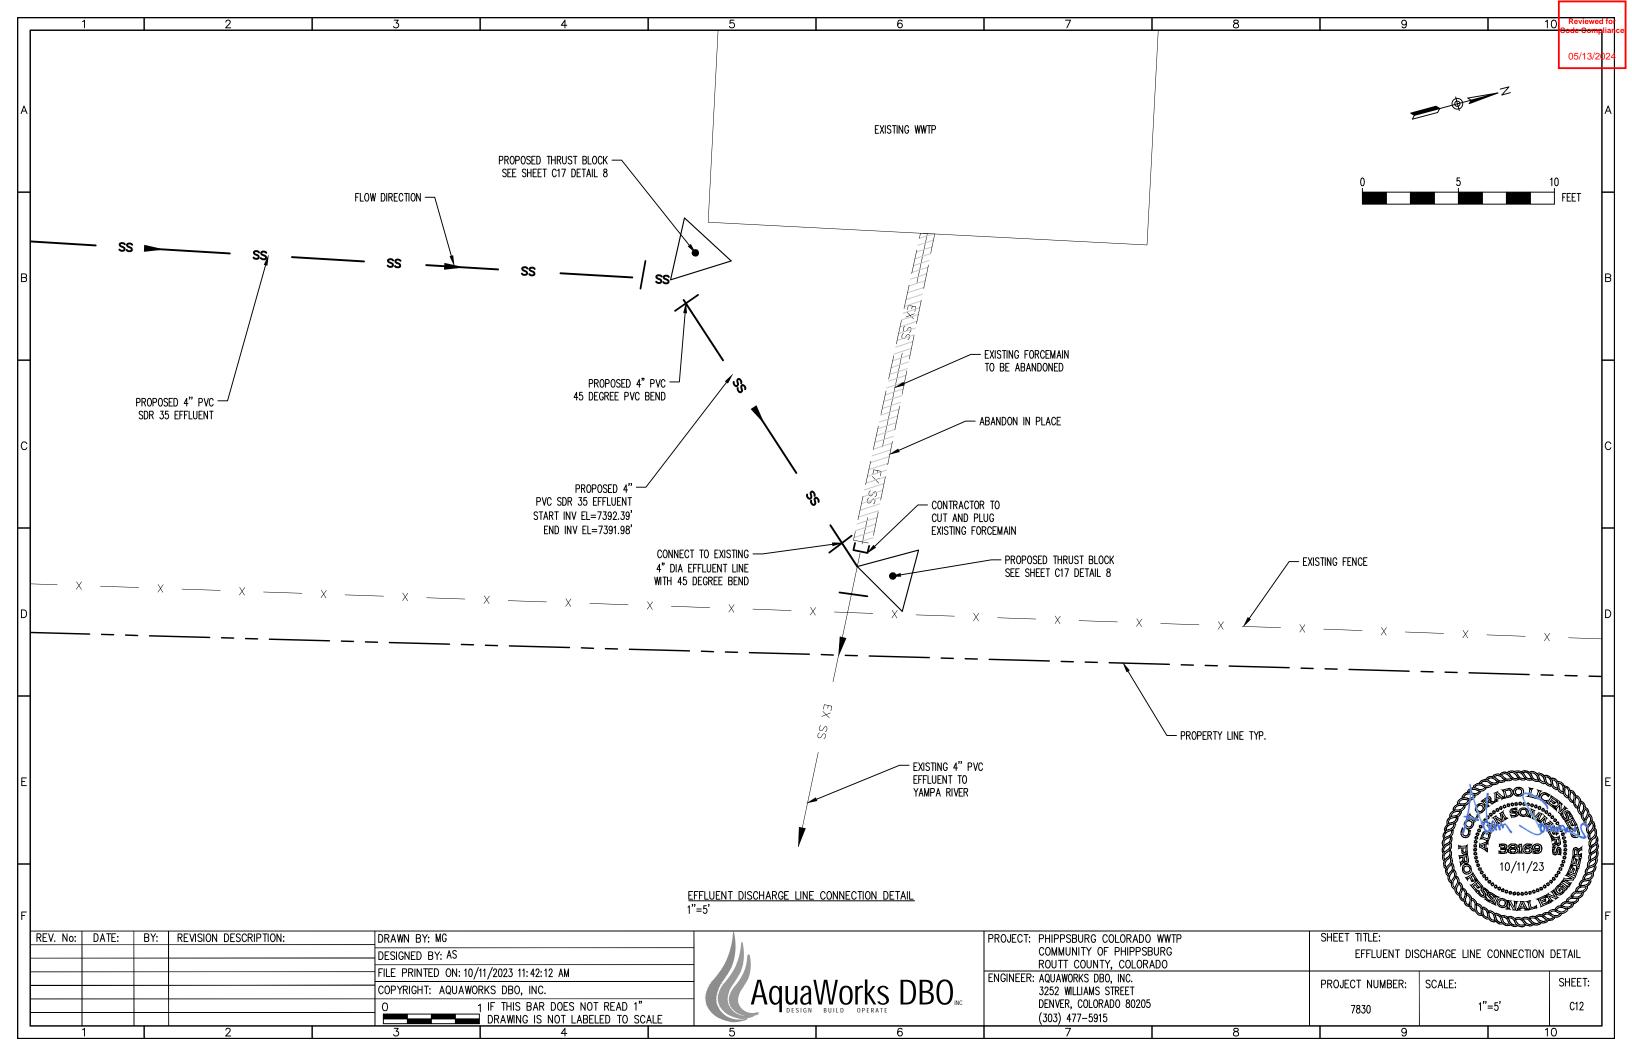

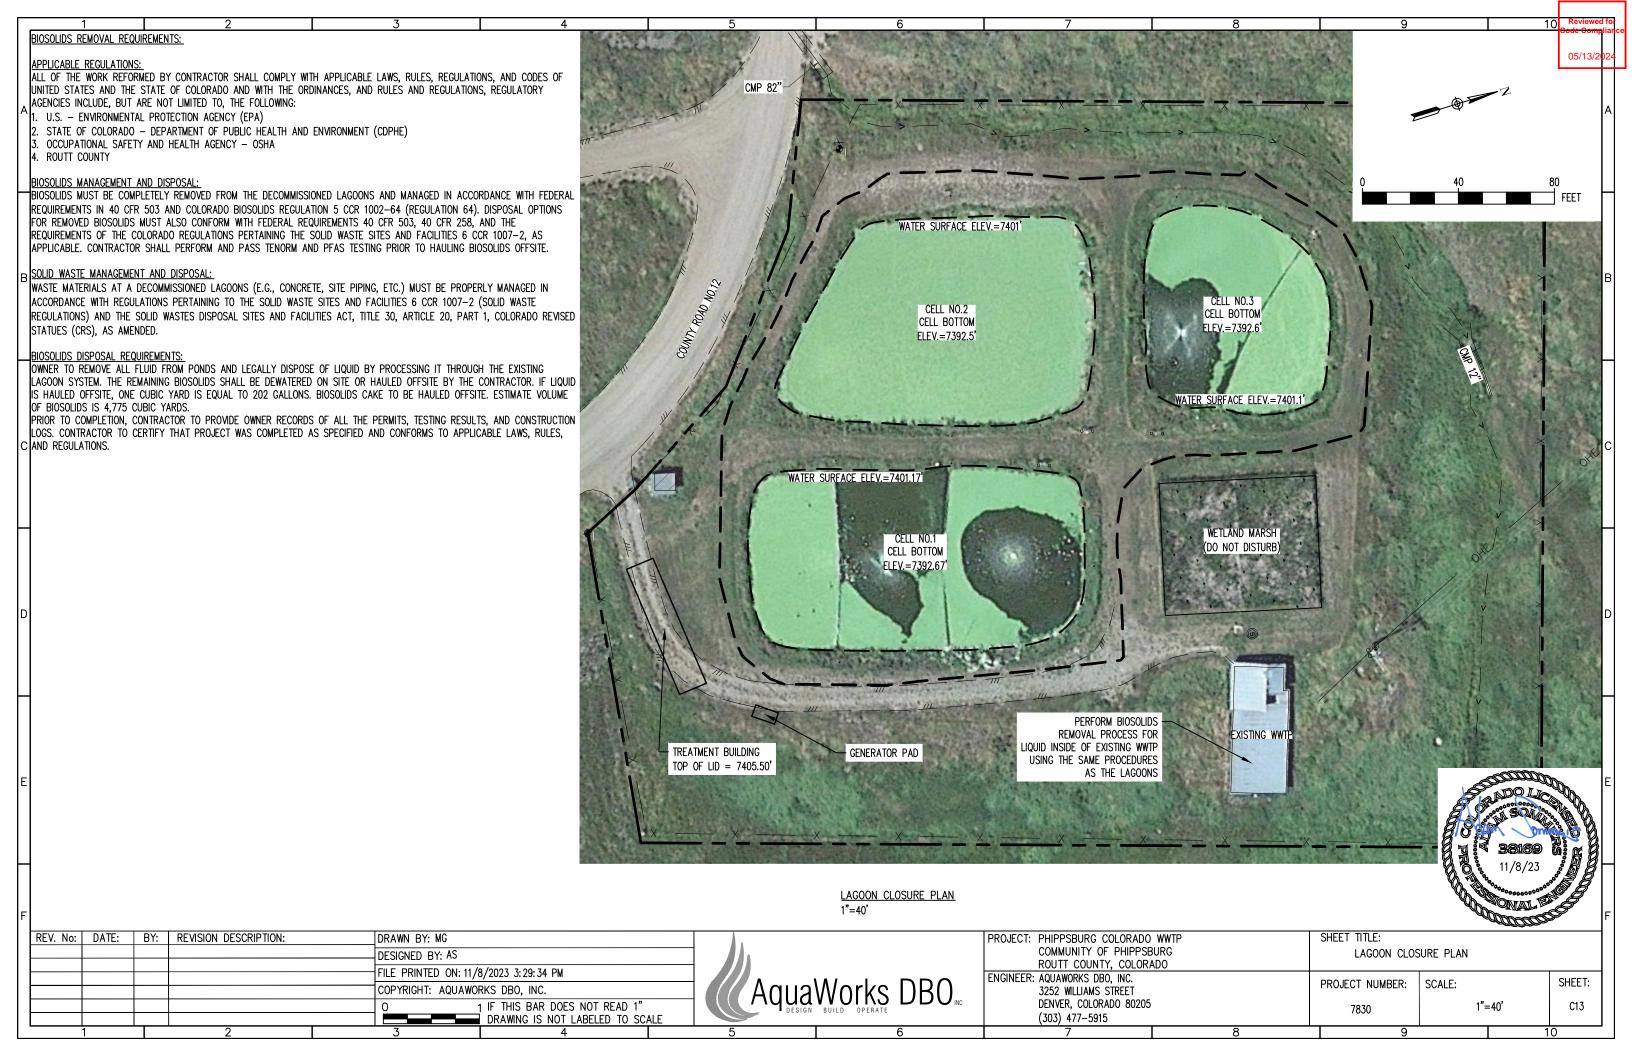


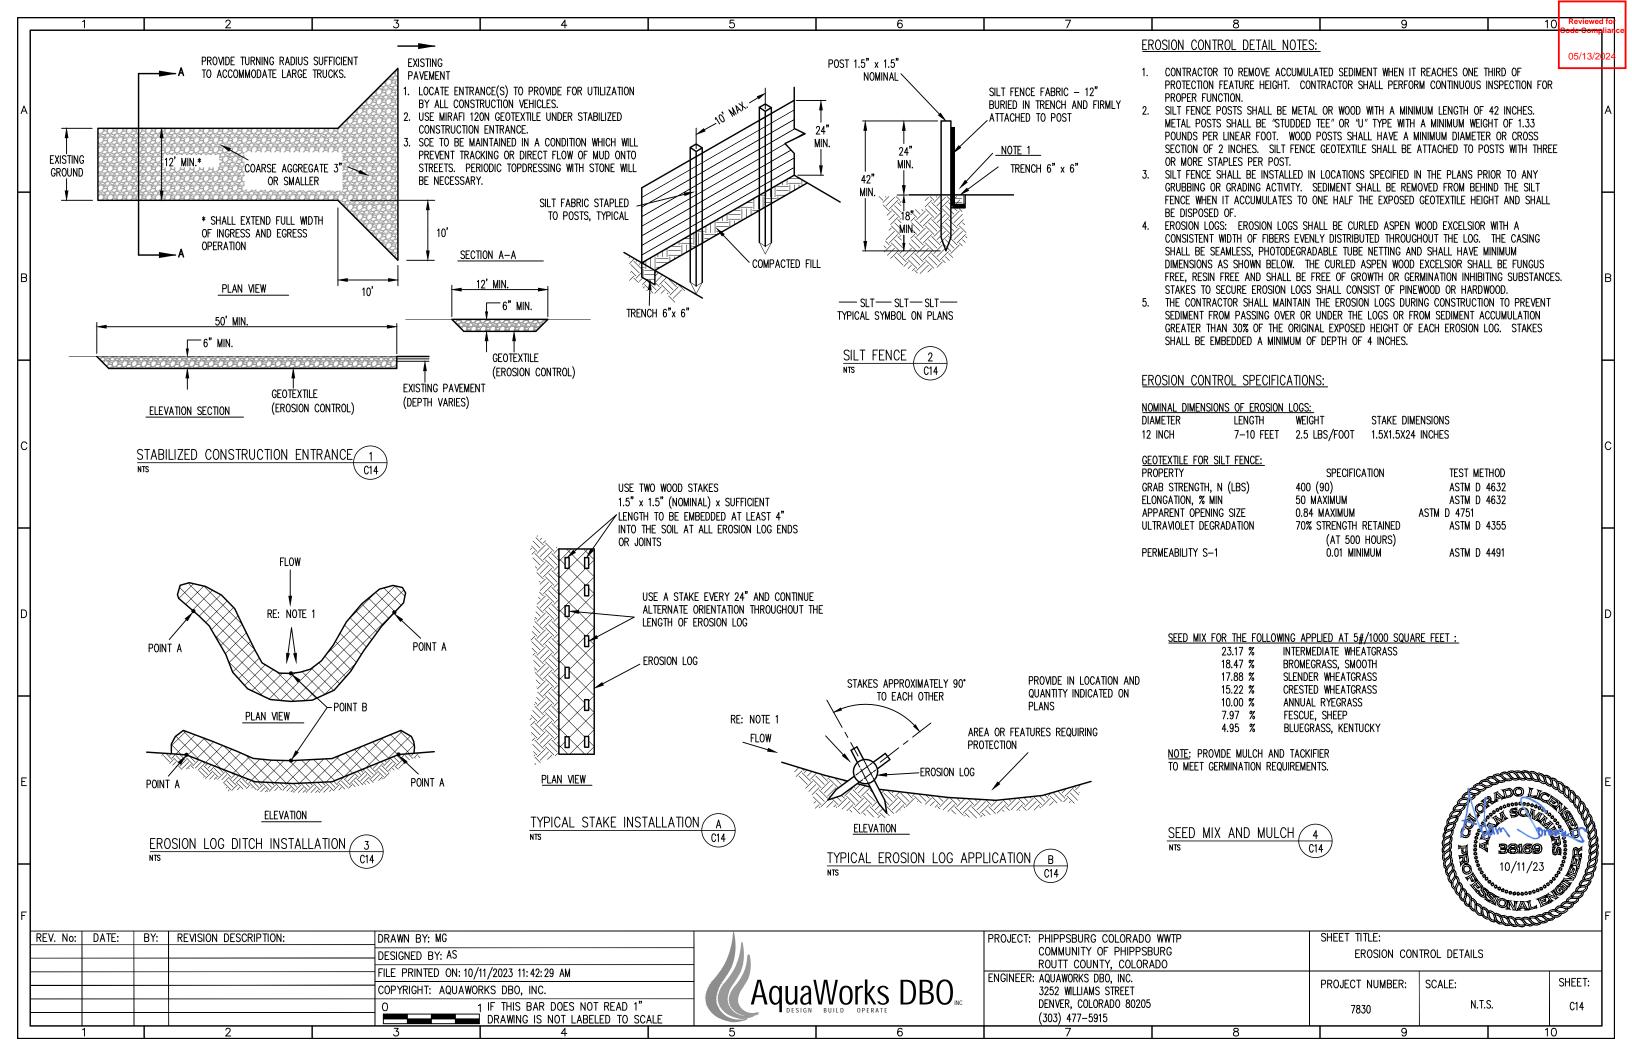

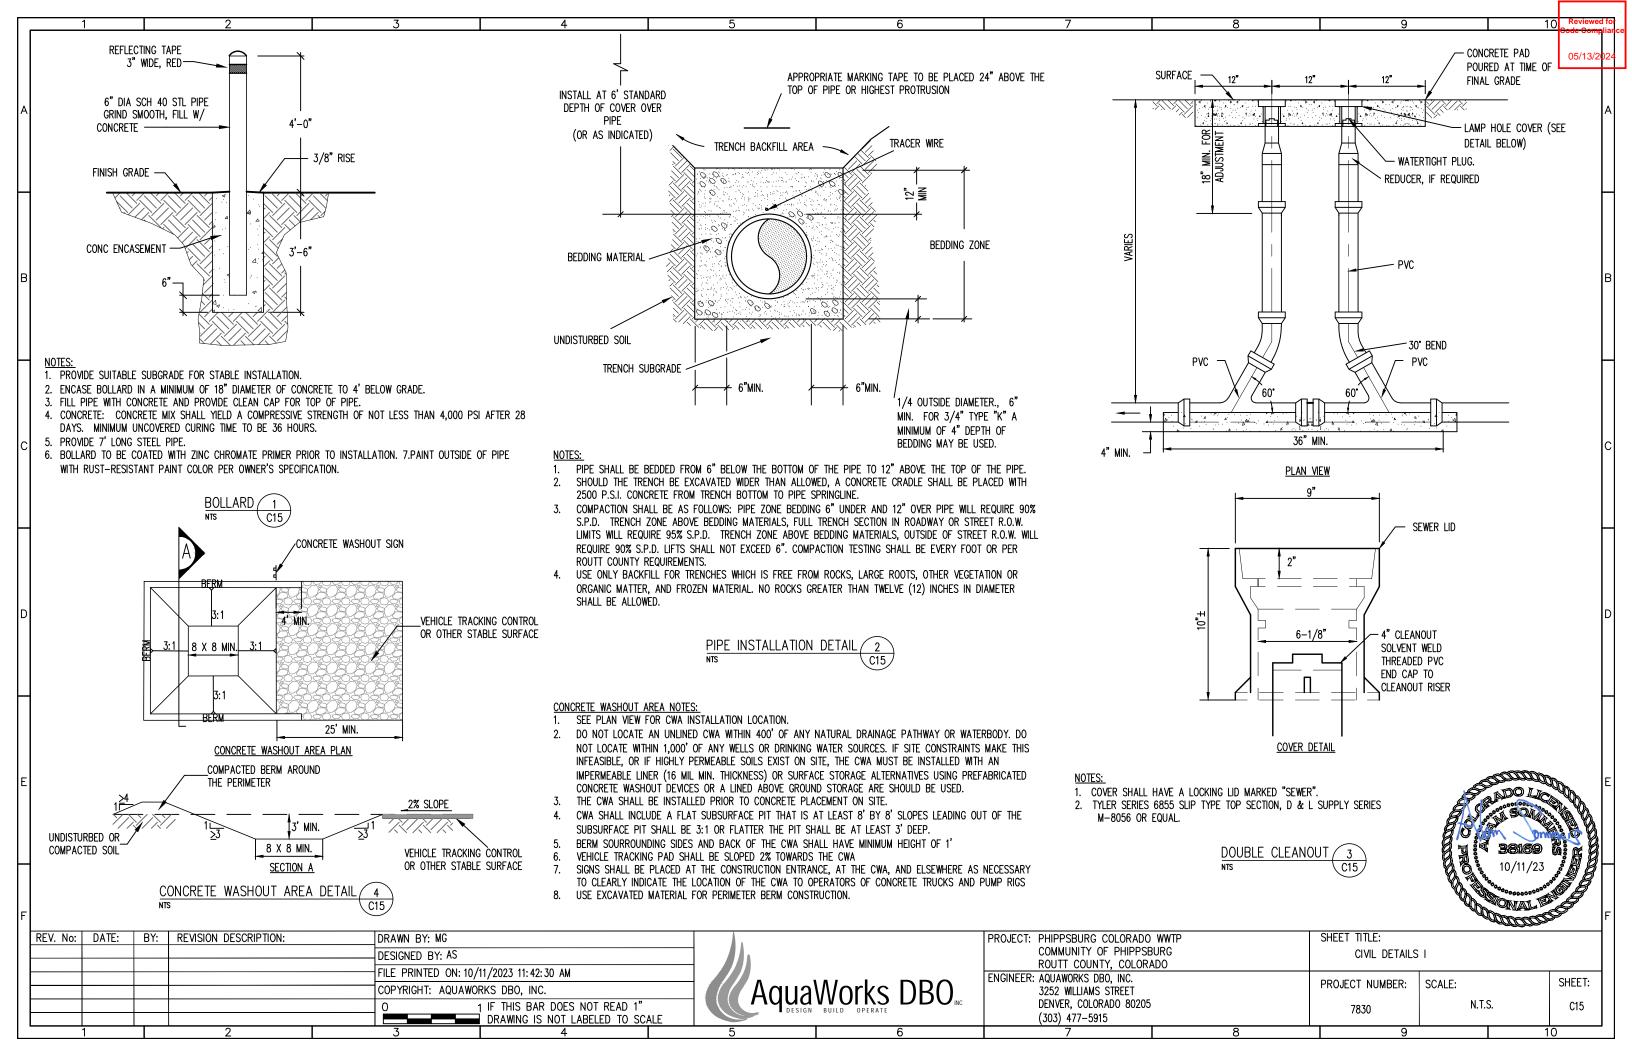

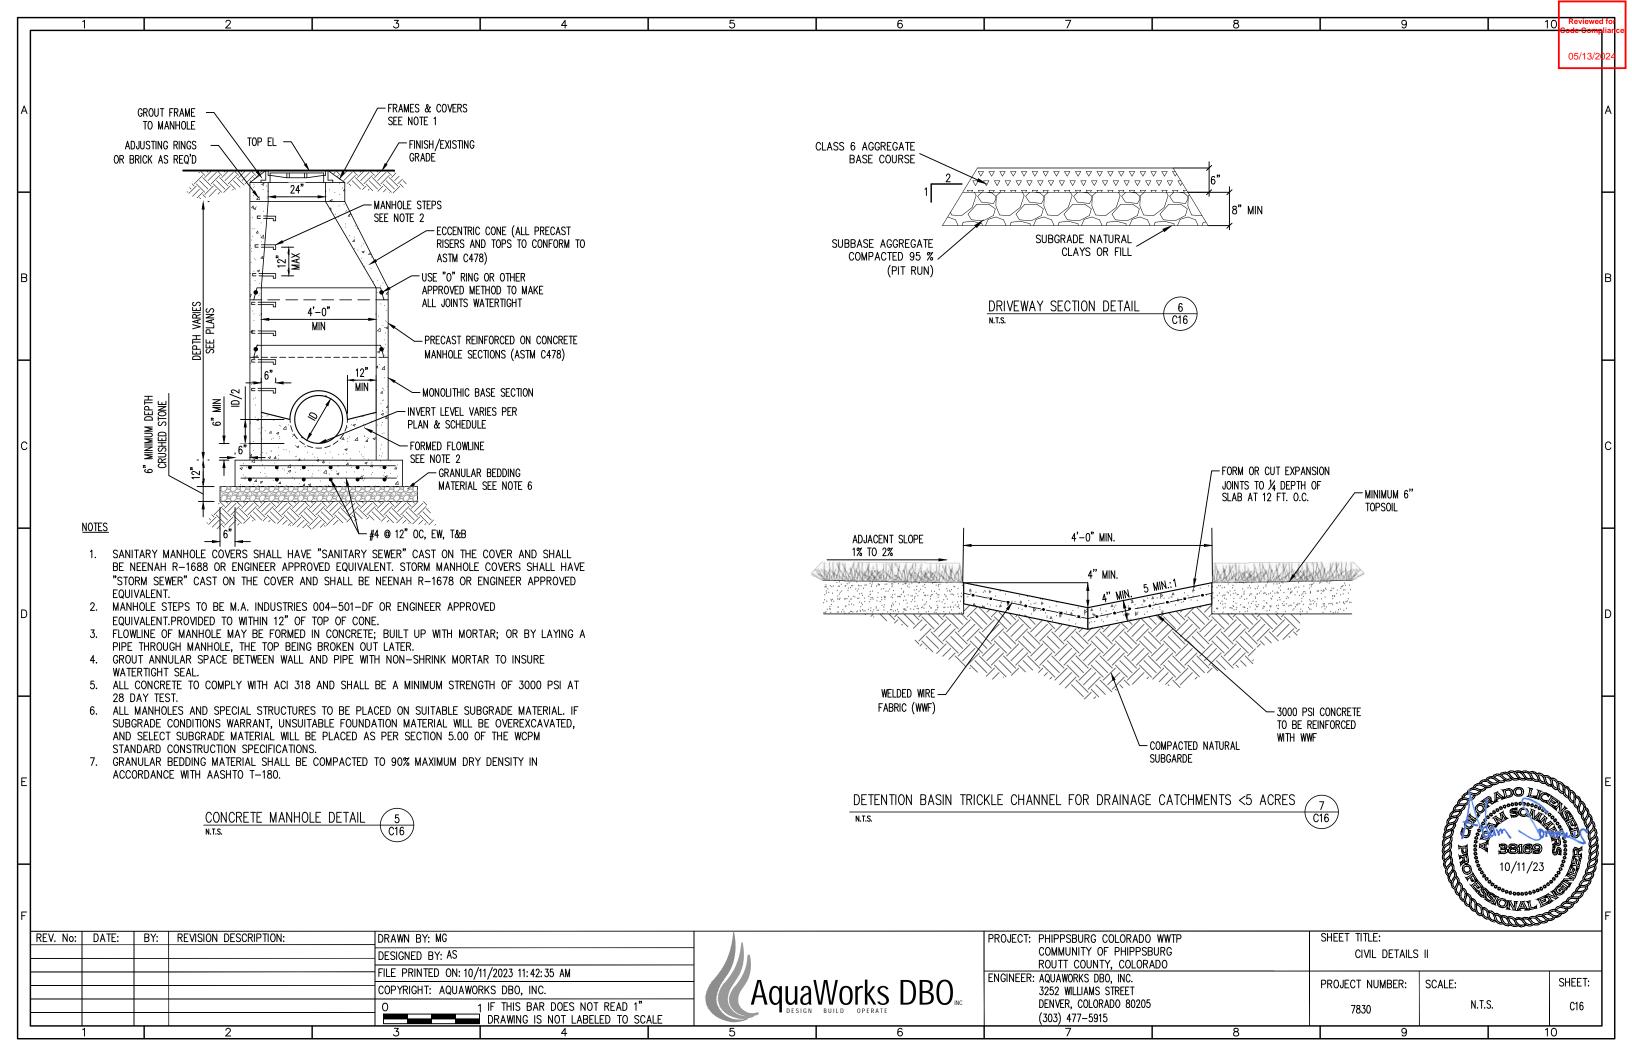



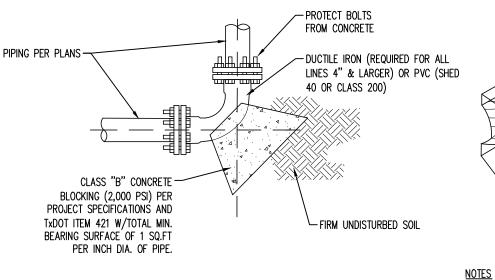


A


DIMENSIONS FOR CONCRETE THRUST BLOCKS


DIMENS	DIMENSIONS FOR CONCRETE THRUST BLOCKS						
PIPE DIA. SIZE (INCHES)	MINIMUM SOIL BEARING AREA REQUIRED (SQUARE FEET)	TYPICAL DIMENSIONS OF BEARING AREA IN INCHES (A X B)	TYPICAL VOLUME OF CONC. REQUIRED (CUBIC FEET)*				
2	2.0	12" X 24"	3.0				
2 ½	2.5	15" X 24"	4.0				
3	3.0	16" X 27"	4.5				
4	4.0	18" X 32"	6.0				
6	6.0	24" X 36"	9.0				
8	8.0	29" X 40"	12.0				
10	10.0	30" X 48"	15.0				
12	12.0	36" X 48"	18.0				
14	14.0	36" X 56"	21.0				
16	16.0	39" X 59"	24.0				
18	18.0	42" X 62"	27.0				

BLOCKING REQUIRED ON ALL FITTINGS 2" & LARGER.
ALL REQUIRED BENDS & FITTINGS MAY NOT BE LABELLED ON THE PLANS.
PIPE MAY BE CURVED UP TO 75% OF MANUFACTURERS RECOMENED
MAXIMUM CURVATURE WITHOUT A BEND AS APPROVED BY OWNER &
ENGINEER.

ENGINEER.
PVC FITTINGS TO BE PROTECTED FROM CONCRETE WITH A WRAPPING OF 30" ROOFING FELT.

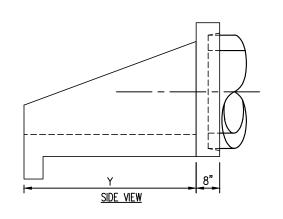

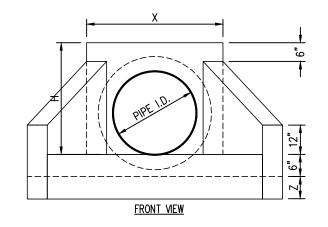

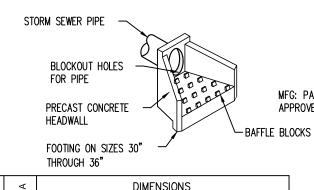

PARKUSA OR — H	-
VED EQUAL	
5" O W	•
7	
TOP VIFW	

	Ġ		DIMENSIONS				
MODEL	PIPE	Н	w	Х	Y	Z	WEIGHT (LBS)
HW-12	12"	2'-6"	4'-3"	3'-0"	2'-0"	N/A	2,700
HW-15	15"	2'-6"	4'-3"	3'-0"	2'-0"	N/A	2,700
HW-18	18"	2'-6"	4'-3"	3'-0"	2'-0"	N/A	2,600
HW-21	21"	3'-0"	5'-10"	3'-2"	3'-0"	N/A	4,300
HW-24	24"	3'-0"	5'-10"	3'-2"	3'-0"	N/A	4,200
HW-30	30"	3'-6'	7'-6"	4'-1"	4'-0"	9"	6,200
HW-36	36"	4'-1"	9'-3"	4'-8"	5'-0"	9"	8,100
HW-42	42"	4'-11"	12'-6"	5'-10"	6'-0"	12"	11,000
HW-48	48"	4'-11"	12'-6"	5'-10"	6'-0"	12"	11,000

SPECIFICATIONS

CONCRETE:

CLASS II CONCRETE WITH OF DESIGN STRENGTH OF 4500 PSI AT 28 DAYS. UNIT IS OF MONOLITHIC CONSTRUCTION INCLUDING WALLS AND FLOOR.

REINFORCEMENT:

GRADE 60 REINFORCED. NO. 4 STEEL REBAR TO CONFORM TO ASTM A615 ON REQUIRED CENTERS OR EQUAL. BAR BENDING AND PLACEMENT SHALL WITH THE LATEST ACI STANDARDS.

CONCRETE HEADWALL



*	<u>VARIES</u>	CONSIDERABLY	W/DISTANCE	<u>: Between Pipe</u>	AND	<u>Bearing</u>	<u>POINT</u>

TYPICAL BLOCKING DETAILS


N.T.S.

(8) (C17)


REV. No:	DATE:	BY:	REVISION DESCRIPTION:	DRAWN BY: MG
				DESIGNED BY: AS
				FILE PRINTED ON: 10/11/2023 11: 42: 40 AM
				COPYRIGHT: AQUAWORKS DBO, INC.
				O 1 IF THIS BAR DOES NOT READ 1"
				DRAWING IS NOT LABELED TO SCALE




		`	allitain	•
PROJECT: PHIPPSBURG COLORADO WWTP	SHEET TITLE:		•	
COMMUNITY OF PHIPPSBURG	CIVIL DETAILS	III		
ROUTT COUNTY, COLORADO				
ENGINEER: AQUAWORKS DBO, INC.	PROJECT NUMBER:	SCALE:		SHEET:
3252 WILLIAMS STREET	TROOLOT NOMBLES	OUTILE.		
DENVER, COLORADO 80205	7830	N.T.S	S.	C17
(303) 477–5915	7000			

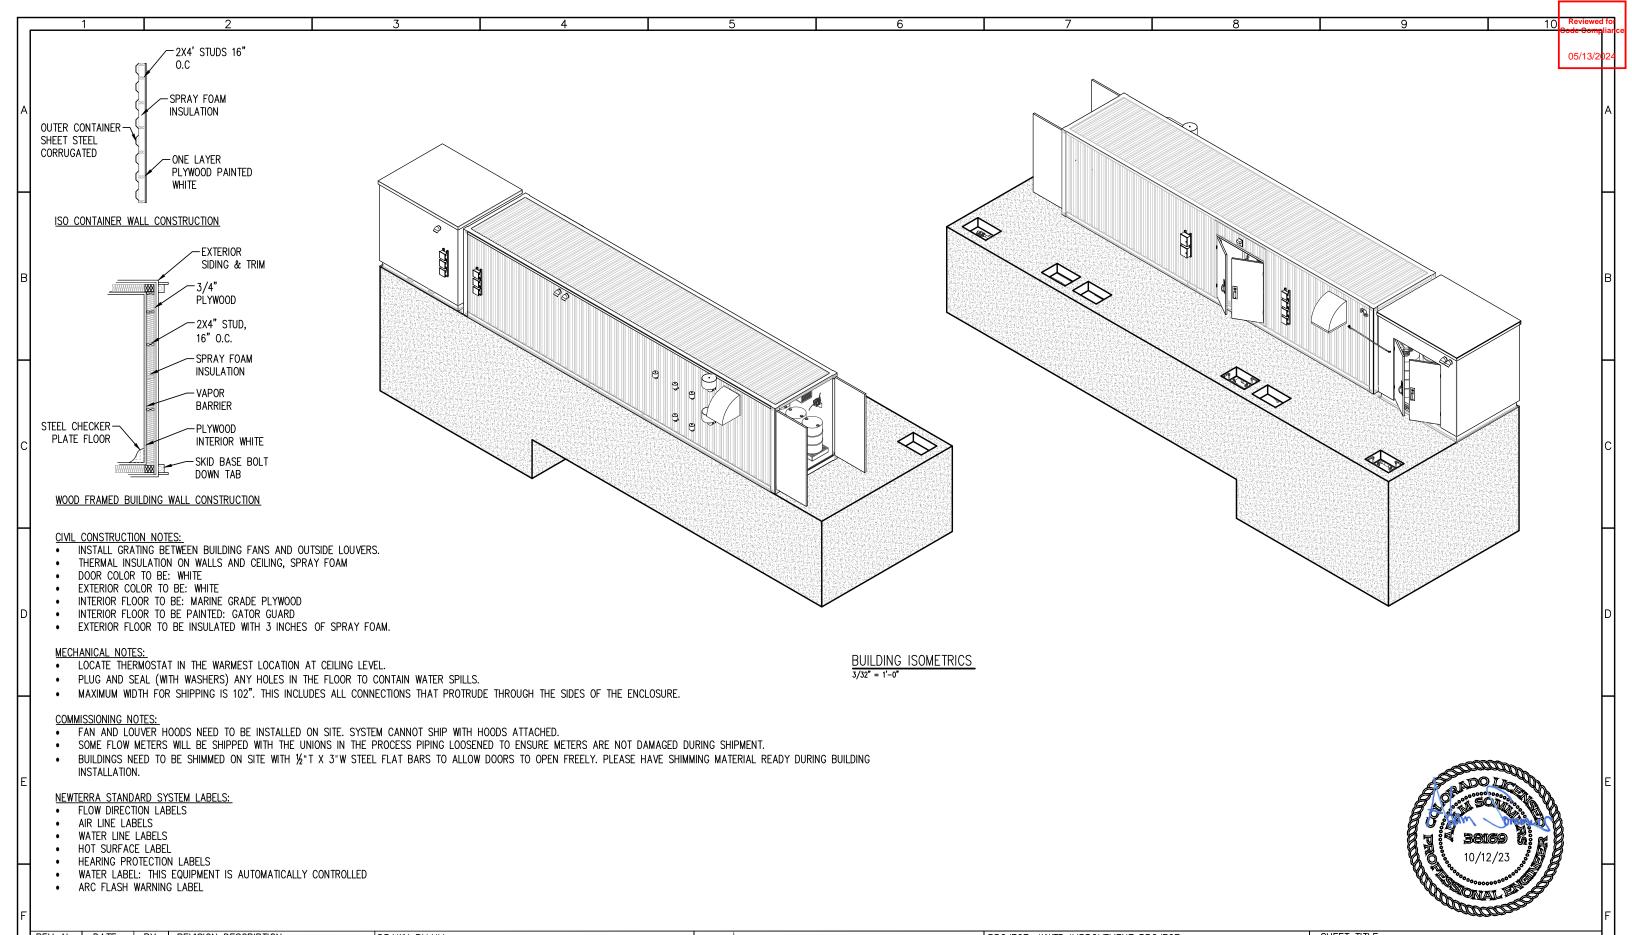

REV. No:	DATE:	BY:	REVISION DESCRIPTION:	DRAWN BY:NM		A .		PROJECT: WWTP IMPROVEMENT PR		SHEET ITTLE:		
				DESIGNED BY: AS		- 11.		COMMUNITY OF PHIPPSE		BUILDING ISOMETRICS	S & INSTALLATIO	ON NOTES
					/10 /0007 4:00:49 DM			ROUTT COUNTY, COLOR				
					/12/2023 4:02:48 PM			ENGINEER: AQUAWORKS DBO, INC.		PROJECT NUMBER:	SCALE.	SHEET:
				COPYRIGHT: AQUAWO	DRKS DBO, INC.	LIDA // Aniia	Works DBO _™	3252 WILLIAMS STREET		TROOLET NOWIDER.	JUALL.	0,1211
				0	1 IF THIS BAR DOES NOT READ 1"		BUILD OPERATE	DENVER, COLORADO 80	205	#2479	3/32" = 1	1'-0" P1
					DRAWING IS NOT LABELED TO SCA			(303) 477–5915		"	,	
,	1		2	3	4	5	6	7	8	9		10

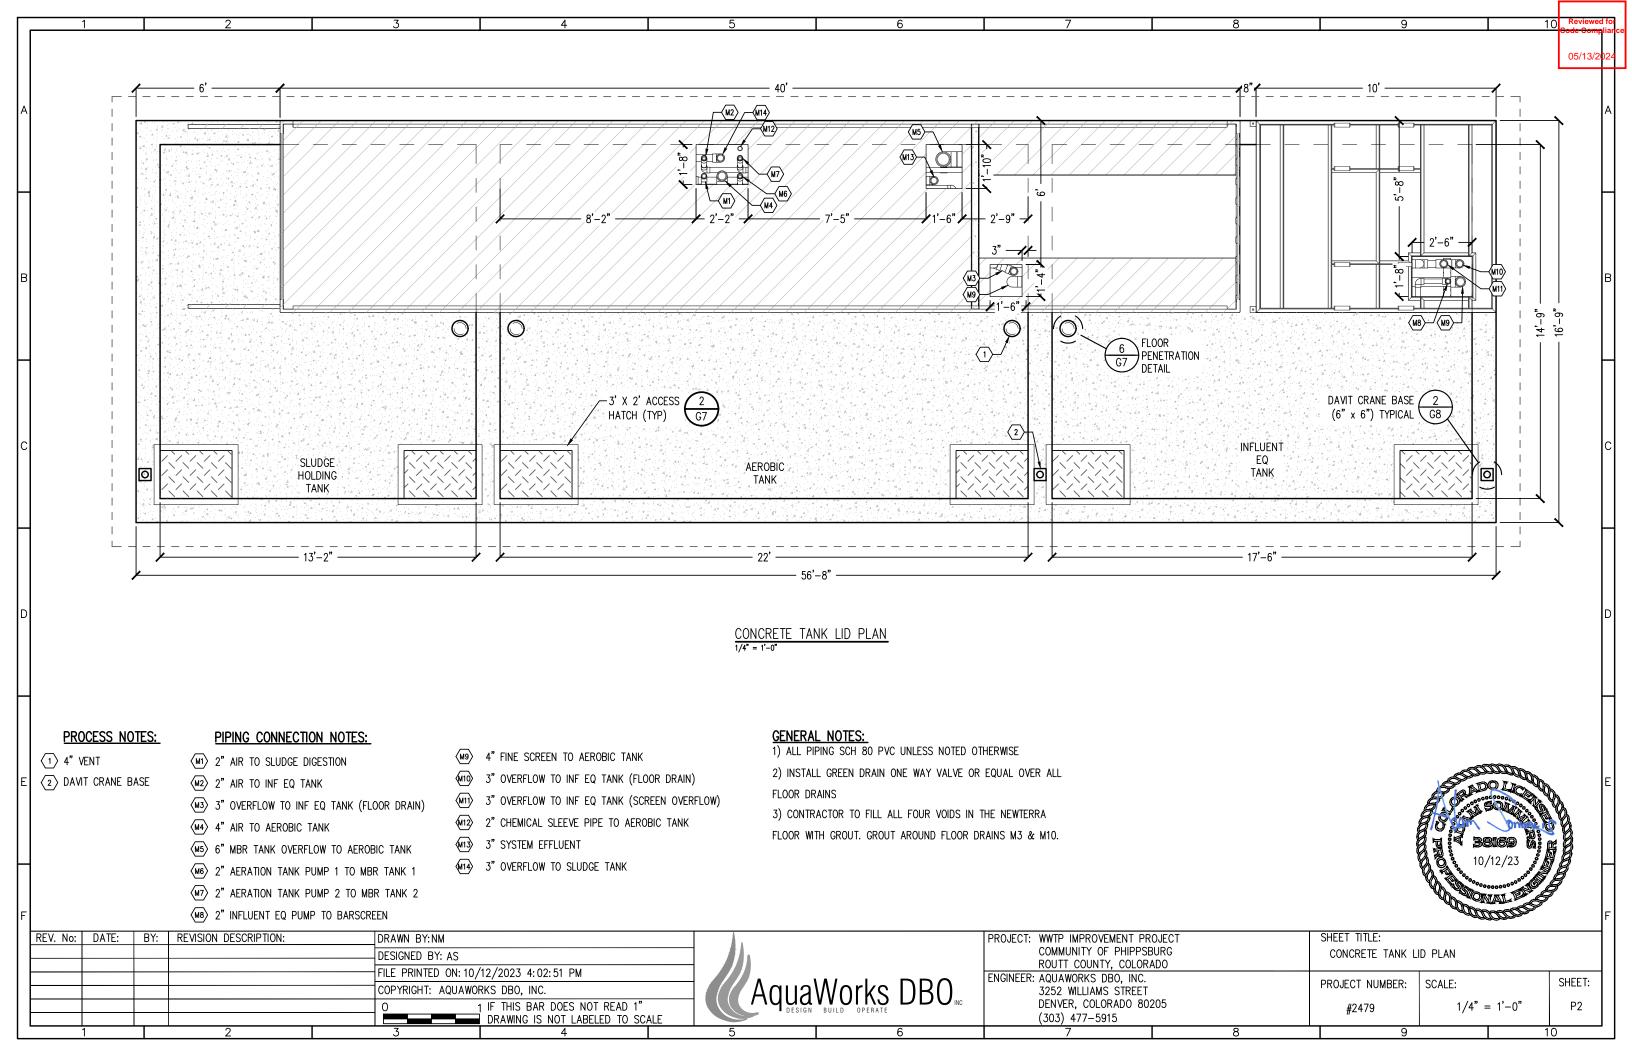

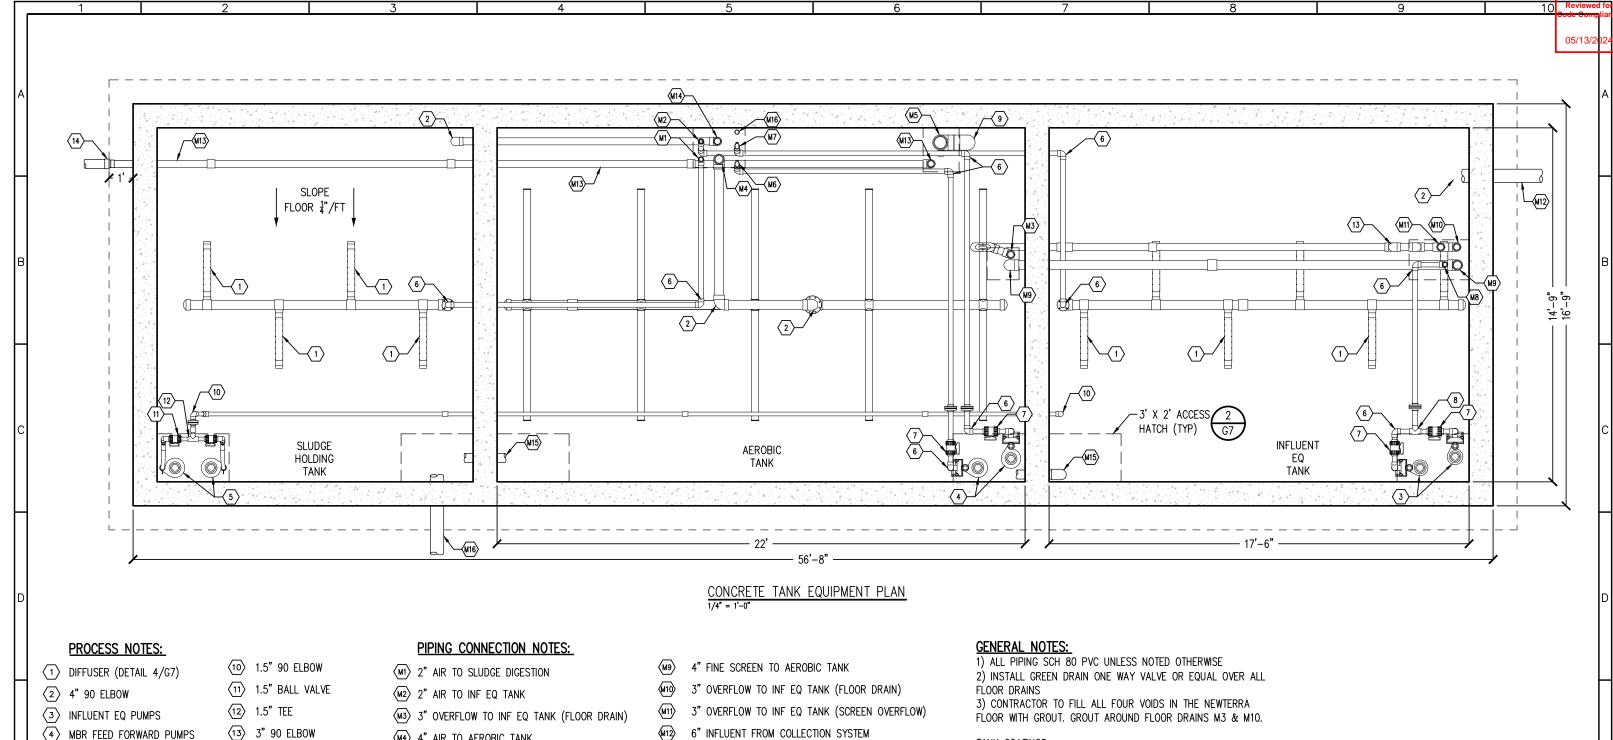

- 4 MBR FEED FORWARD PUMPS
- 5 SLUDGE SUPERNATANT PUMPS
- 6 2" 90 ELBOW
- 7 2" BALL VALVE
- 8 2" TEE
- 9 6" 90 ELBOW

M4 4" AIR TO AEROBIC TANK

4"X3" GASKETED REDUCER

- M5 6" MBR TANK OVERFLOW TO AEROBIC TANK
- M6 2" AERATION TANK PUMP 1 TO MBR TANK 1
- M7 2" AERATION TANK PUMP 2 TO MBR TANK 2
- (MB) 2" INFLUENT EQ PUMP TO BARSCREEN
- 6" INFLUENT FROM COLLECTION SYSTEM
- 3" SYSTEM EFFLUENT
- 3" OVERFLOW TO SLUDGE TANK
- 4" BASIN OVERFLOW
- 6" OVERFLOW TO OVERFLOW POND

TANK COATINGS

COAT INFLUENT EQUALIZATION TANK INTERIOR WALLS AND UNDERSIDE OF LID. SYSTEM TYPE: EPOXY, SHERWIN WILLIAMS OR

- 1. SURFACE PREPARATION: SSPC-SP 13/NACE 6 WITH A SURFACE PROFILE OF ICRI CSP 2 OR 3.
- FILLER: FILL BUG HOLES, AIR POCKETS AND OTHER VOIDS WITH STEEL-SEAM FT910.
- FINISH: DURA-PLATE 6000 REINFORCED EPOXY. DFT 60.0 TO 80.0 MILS.



REV. No: DATE: BY: REVISION DESCRIPTION:	DRAWN BY:NM		PROJECT: WWTP IMPROVEMENT PROJECT	SHEET TITLE:
	DESIGNED BY: AS		COMMUNITY OF PHIPPSBURG	CONCRETE TANK EQUIPMENT
	FILE PRINTED ON: 10/12/2023 4: 02: 53 PM		ROUTT COUNTY, COLORADO ENGINEER: AQUAWORKS DBO, INC.	CUEET
	COPYRIGHT: AQUAWORKS DBO, INC.	□	3252 WILLIAMS STREET	PROJECT NUMBER: SCALE: SHEET:
	O 1 IF THIS BAR DOES NOT READ 1"	TYGUAYVOINS DD	D2111211, 0020111120 00200	#2479 1/4" = 1'-0" P3
	DRAWING IS NOT LABELED TO SCALE		(303) 477-5915	

