1. THIS BUILDING IS TO BE ATTACHED TO A PERMANENT FOUNDATION, AND ONCE SO ATTACHED, IS NOT TO BE REMOVED. 2.THIS BUILDING MAY BE MIRRORED OR REVERSED. 3. THIS BUILDING MUST BE LOCATED ABOVE THE FLOOD PLAN.

4.THIS BUILDING IS TO BE LOCATED NO LESS THAN 5' FROM LINES OR

ADJACENT STRUCTURES.

5. THIS BUILDING IS TO BE CONNECTED TO A PUBLIC WATER SUPPLY AND SEWER, WHEN AVAILABLE.



203 INDUSTRIAL DRIVE REDWOOD FALLS, MN PH: (507)644-6600 FX.: (507)644-6601

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A8.1	TRUSS LAYOUT

SITE ADDRESS:

GOLDEN VIEW TRAIL CLARK, CO 80428

ATTENTION LOCAL INSPECTIONS DEPARTMENT:

THE FOLLOWING ITEMS HAVE NOT BEEN COMPLETED BY THE BUILDING MANUFACTURER AND HAVE NOT BEEN INSPECTED BY THE THIRD PARTY INSPECTION AGENCY:

- 1. RAMP, STAIRS AND GENERAL ACCESS TO THE BUILDING.
- 2. THE COMPLETED FOUNDATION SUPPORT SYSTEM AND THE TIE DOWN AND/OR ANCHORING SYSTEM.
- 3. SITE INSTALLED FASTENING AT THE FLOOR AND ROOF RIDGE AT MARRIAGE LINES OF MULTI-UNIT BUILDINGS.
- 4. COMPLETION OF THERMAL ENVELOPE: INSTALLATION OF INSULATION AT FLOORS, CEILINGS AND END WALLS AT MARRIAGE LINES TO MINIMIZE AIR INFILTRATION. (ON SITE BY OTHERS)
- 5. INSTALLATION OF R-8 INSULATION ON ALL PIPING INSTALLED IN UN-CONDITIONED SPACES.
- 7. ELECTRICAL CROSS-OVER CONNECTIONS BELOW FLOOR OR IN ATTIC WHERE MARRIAGE LINES OCCUR.
- 8. ELECTRICAL SERVICE, MAIN ELECTRICAL PANEL, AND FEEDERS TO SUB-PANELS LOCATED IN THE MODULAR BUILDING.
- 9. BUILDING DRAINS, CLEANOUTS AND HOOKUPS TO PLUMBING SYSTEM AND FINAL PLUMBING.
- 10. CRAWL SPACE LIGHT AND SWITCH.
- 11. HVAC SYSTEM: HVAC COMPANY IS RESPONSIBLE FOR ANY DAMAGE AND REPAIRS TO MODULAR COMPONENTS (ie. TRUSSES, ELECTRICAL CONDUCTORS, PLUMBING AND ATTIC INSULATION.)
- 12. ROOF COVERING (INSTALLED ON SITE BY OTHERS)
- 13. HVAC R-8 DUCT INSULATION.
- 14. METAL ROOFING AND INSTALLATION (ON SITE BY OTHERS).

COLORADO BUILDING CODES: 2018 IRC

2023 NEC 2021 IECC

8 CCR 1302-14 ADMINISTRATIVE RULES (FACTORY BUILT HOUSING) STATE OF COLORADO DIVISION OF HOUSING

TYPE OF FIRE SUPPRESSION SYSTEM: None required

ROOF LIVE LOAD (TCLL): 112.4 PSF GROUND SNOW: 146 PSF FLOOR LIVE LOAD: 40 PSF CONSTRUCTION TYPE: WOOD FRAME VB OCCUPANCY GROUP/LOAD: SINGLE FAMILY R3 / 7 WIND SPEED: 115 MPH-Vult (3 SEC.) WIND EXPOSURE:

AS LISTED ON ATTACHED SEALED SEISMIC CATEGORY: ENGINEERED CALCULATIONS

CONDITIONED MODULAR SPACE: 1408 SQ. FT

DOOR SCHEDULE-EXTERIOR*

SIZE

	WINDOW SCHEDULE											
ID	TYPE	RO WIDTH	RO HEIGHT	TEMPERED	QTY	EGRESS	REMARKS	U-VALUE				
P1-36"X36"	CASEMENT	3'-0 1/4"	3'-0 1/4"	YES	1	NO	-	0.27				
CA1-36"X36"	CASEMENT	3'-0 1/4"	3'-0 1/4"	YES	1	NO		0.27				
CA1-36"X36"	CASEMENT	3'-0 1/4"	3'-0 1/4"	NO	1	NO	-	0.27				
T1-72"X12"	TRANSOM	6'-0 1/4"	1'-0 1/4"	NO	4	NO	-	0.27				
G1-72"X60"E	GLIDING	6'-0 1/4"	5'-0 1/4"	NO	1	YES	-	0.29				
G1-72"X60"E	GLIDING	6'-0 1/4"	5'-0 1/4"	NO	2	YES	-	0.27				
G1-72"X60"E	GLIDING	6'-0 1/4"	5'-0 1/4"	YES	1	YES	-	0.27				
G1-72"X60"E	GLIDING	6'-0 1/4"	5'-0 1/4"	NO	1	YES	WOCD	0.27				
G1-72"X60"E	GLIDING	6'-0 1/4"	5'-0 1/4"	YES	1	YES	WOCD	0.27				

0.27		6068	SLIDER	VINYL	6'-0 1/4" x 6'-8 1/4"	W/ TRANSOM	0.30	Ĺ
0.27]	*- 111	FYTERIO	D DOODS I	HAT CONTAIN GLAZING S	HALL BE TEMP	EDED: LINIE	
0.27					NGING OR SLIDING DOOR			
0.27								
0.29			<u>TES:</u> MARY FG	RESS DOOR	ON LOWER LEVEL SUPP	LIFD AND		
0.27				N SITE BY				
0.27	I							

XTERIOR DOORS THAT CONTAIN GLAZING SHALL BE TEMPERED; UNLESS THE OPERABLE NEL OF OF A SWINGING OR SLIDING DOOR MEETS THE EXCEPTIONS OF R308.4.1

REMARKS U-VALUE QTY

ID TYPE MATERIAL

WINDOW ASSEMBLY

-VINYL - DOUBLE PANE-LOW E

-TEMPERED WINDOWS WILL BE LABELED ON PLANS WHERE NECESSARY AND LISTED IN THE TEMPERED SECTION OF THE WINDOW SCHEDULE.


-WINDOW OPENING CONTROL DEVICES (WOCD'S)AS REQUIRED PER R312.2 WILL BE LABELED AT INDIVIDUAL WINDOWS ON PLANS AS WELL AS LISTED IN THE REMARKS SECTION OF THE WINDOW

NORTHSTAR

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COVER SHEET

DEALER: ROCKY MOUNTAIN HOMES NS5254 PAGE: DRAWN BY: ML DATE: 8/26/24 REV: X BY: X DATE: X SCALE: N.T.S.



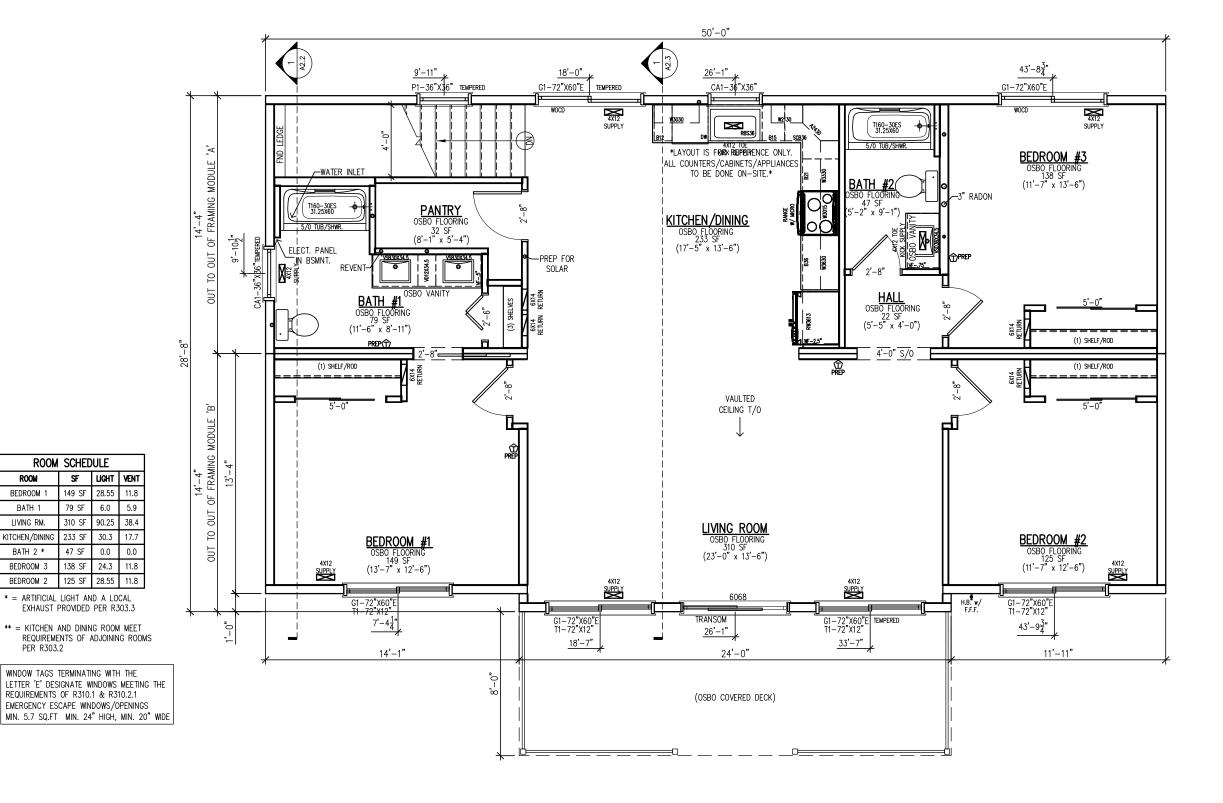

ROOM SCHEDULE


ROOM BEDROOM 1

BATH 1

LIVING RM.

203 Industrial Drive Redwood Falls, MN Ph: (507) 644-6600 Fx: (507) 644-6601 MAIN LEVEL FLOOR PLAN

ER: ROCKY MOUNTAIN HOMES PAGE: OMFR: FINCH DRAWN BY: MW DATE: 8/26/24 SCALE: 3/16"=1'-0" DATE: 5/16/24 REV: C BY: ML

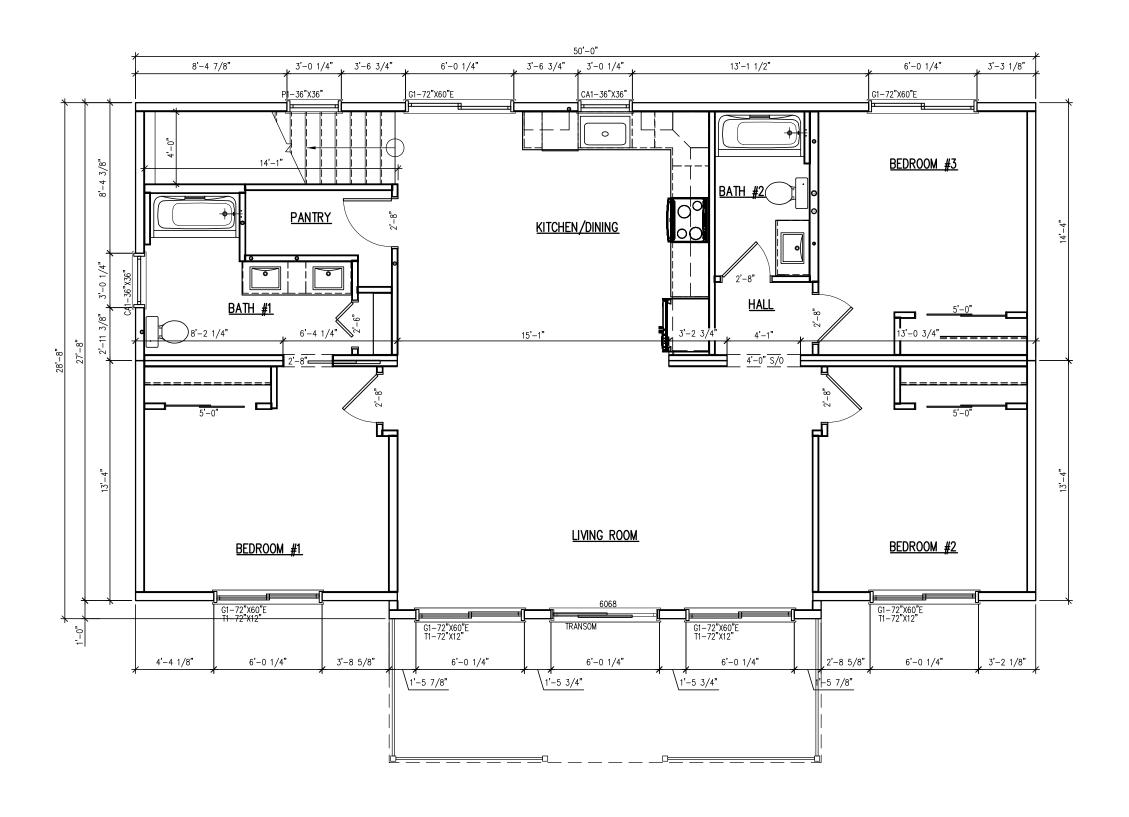





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MAIN LEVEL BRACING PLAN

NS5254 DEALER: ROCKY MOUNTAIN HOMES PORAWN BY: ML CUSTOMER: FINCH

DATE: 8/26/24 REV: X BY: X DATE: X SCALE: 3/16"=1'-0"



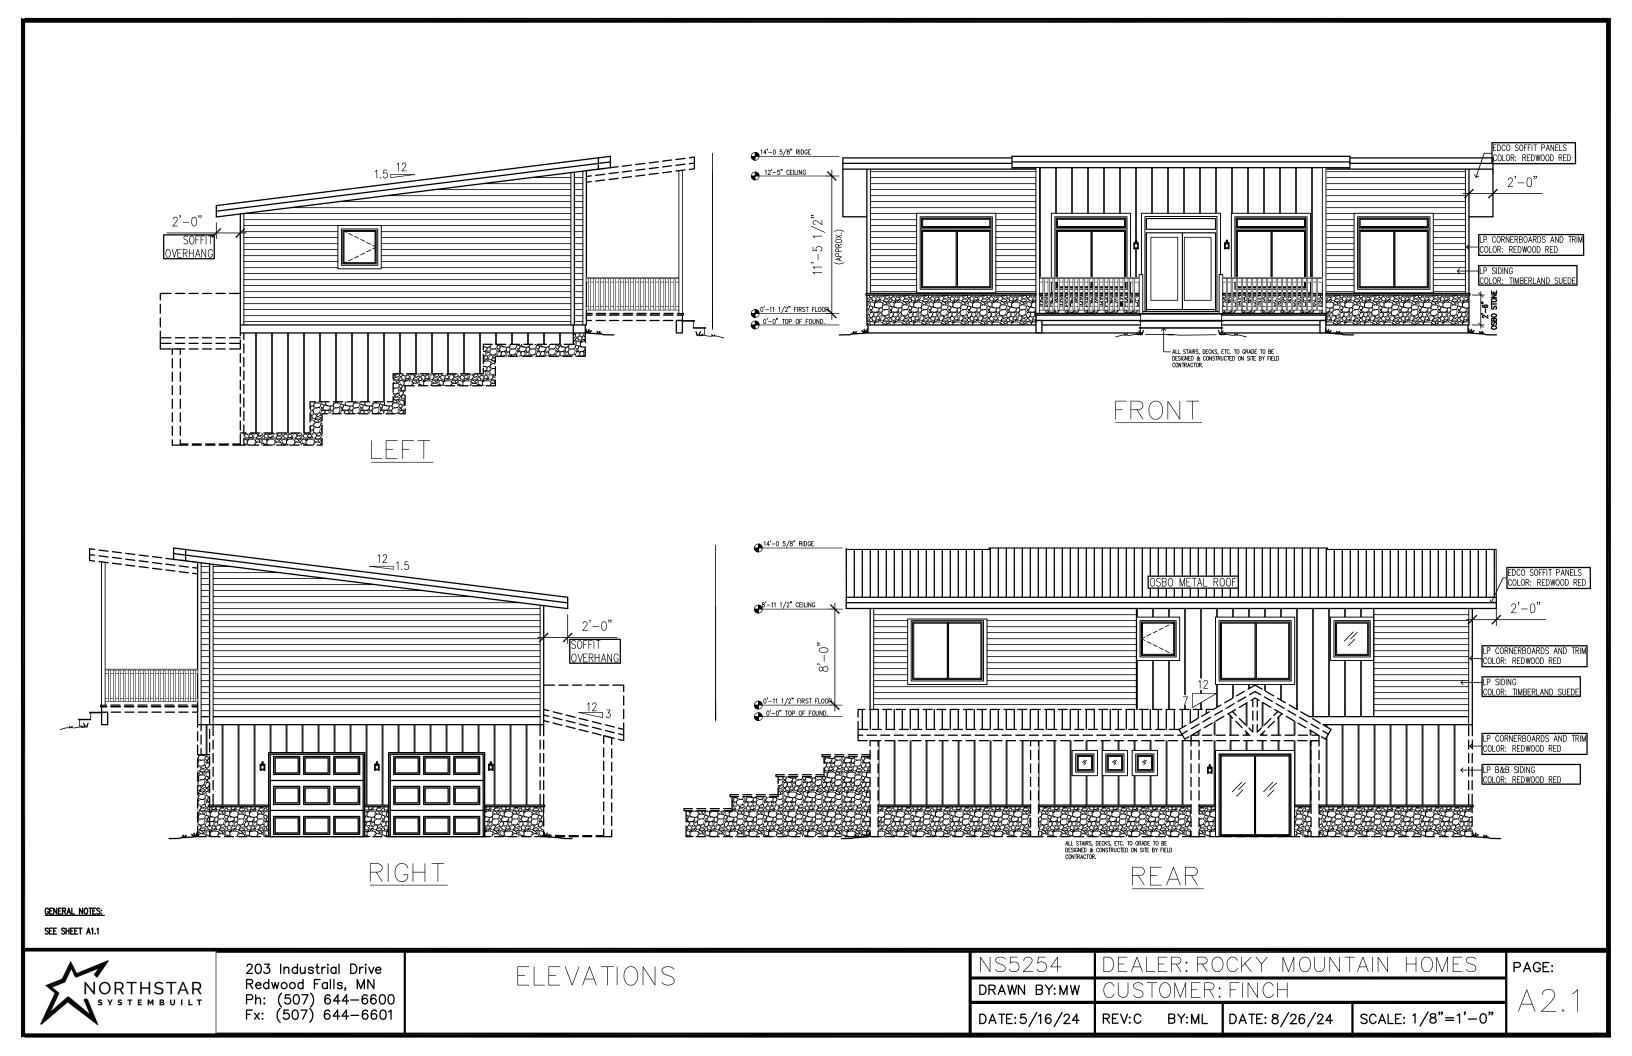

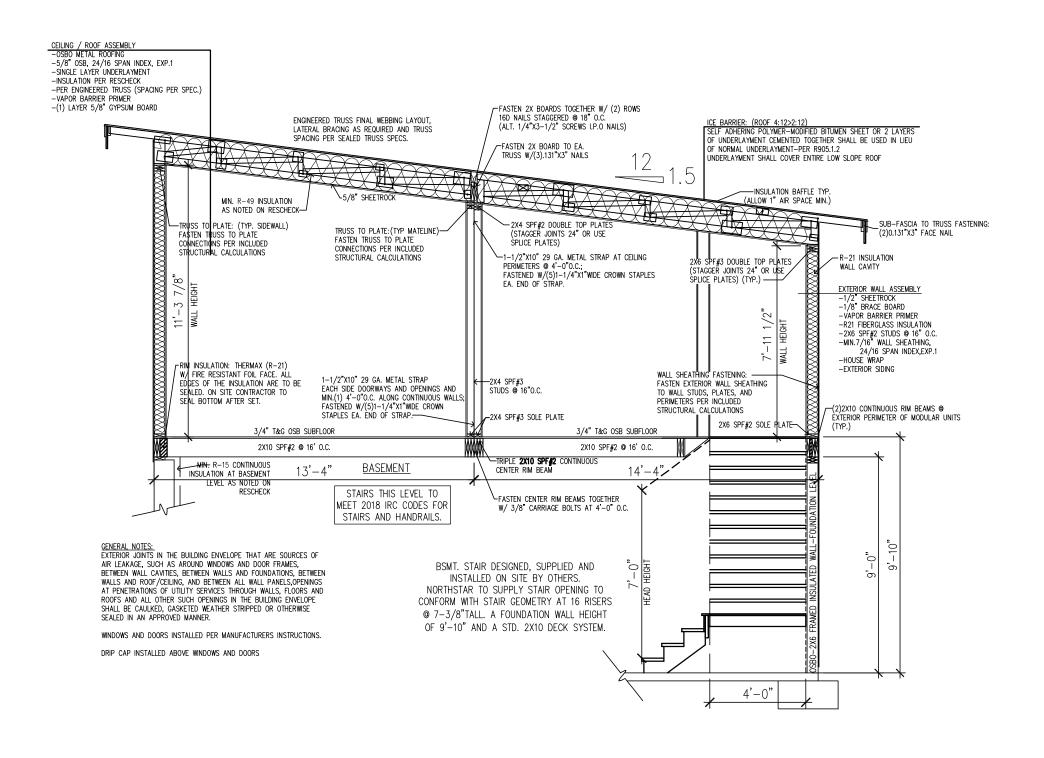SEE SHEET A1.1




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MAIN HOUSE SECTION AT STAIR

NS5254	DEAL	ER: RC	CKY MOUNT	TAIN HOMES	PΑ
DRAWN BY:ML	CUST	OMER:	FINCH] ^
DATE:8/26/24	REV:X	BY:X	DATE: X	SCALE: 1/4"=1'-0"	

PAGE:

| AZ.Z

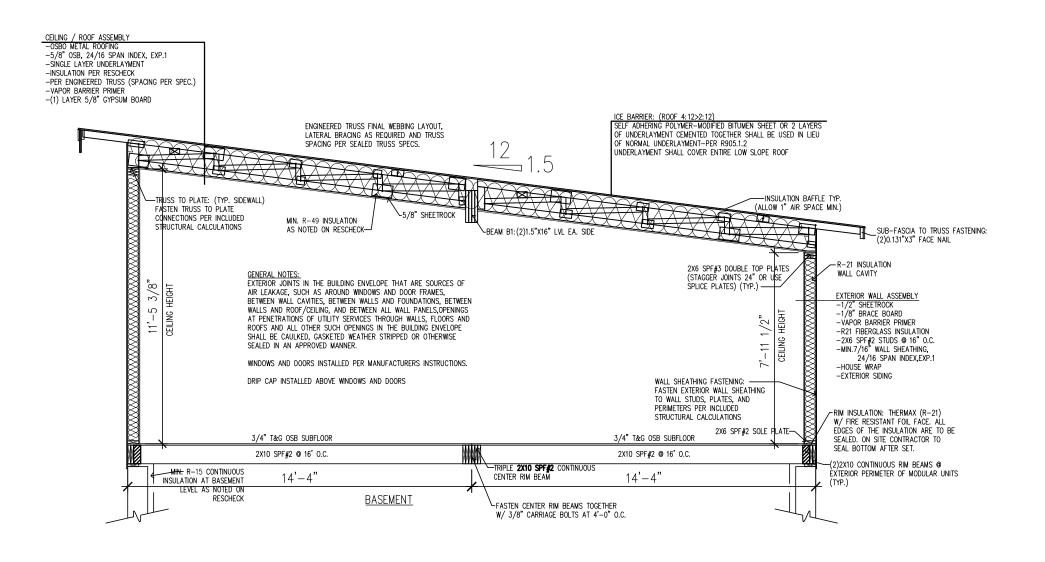

SEE SHEET A1.1




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MAIN HOUSE SECTION AT VAULT

NS5254	DEAL	ER: RC	CKY MOUNT	TAIN HOMES	Р
DRAWN BY:ML	CUST	OMER:	FINCH		
DATE:8/26/24	REV:X	BY:X	DATE: X	SCALE: 1/4"=1'-0"	/

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GENERAL NOTES: SEE SHEET A1.1

NORTHSTAR

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FOUNDATION PLAN

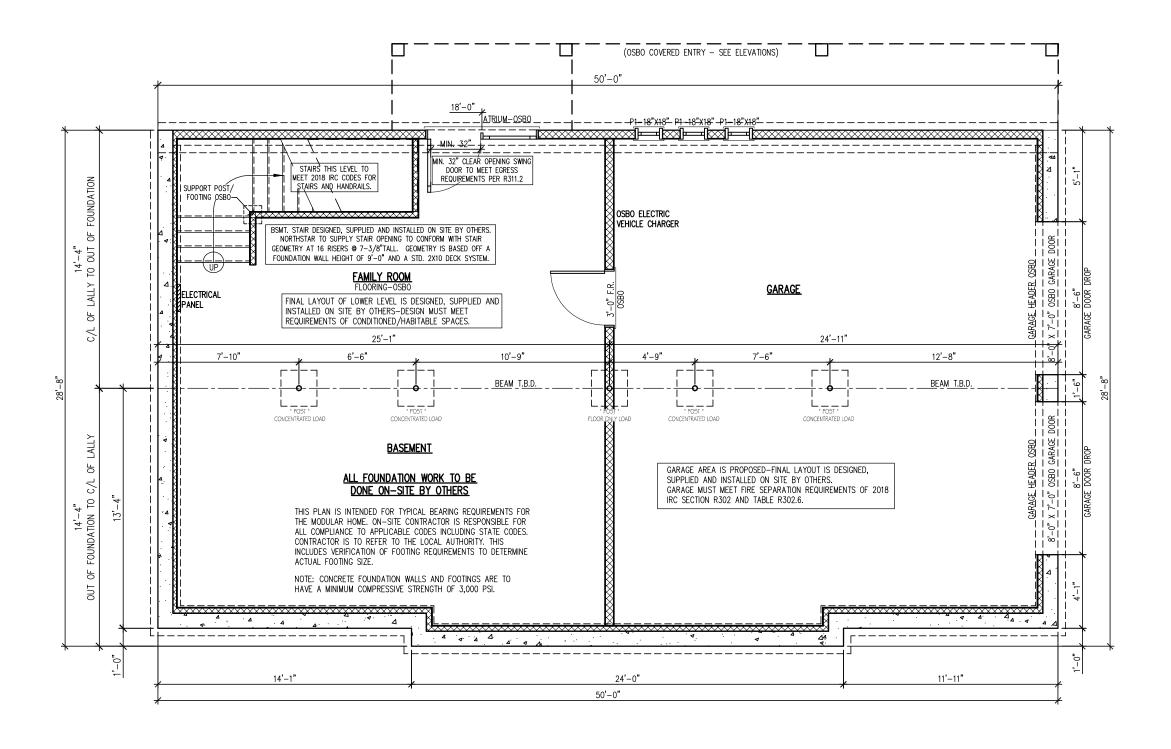NS5254 DEALER: ROCKY MOUNTAIN HOMES PAGE:
DRAWN BY:MW CUSTOMER: FINCH
DATE: 5/16/24 REV: C BY:ML DATE: 8/26/24 SCALE: 3/16"=1"-0"

ELECTRICAL CROSS OVER DETAIL


EXTEND THE COILED WIRE CAPBLE TO THE LIBOX IN THE OTHER MODULE. CONNECT THE CABLE TO THE J BOX WITH A LISTED WIRE CONNECTOR, CONNECT EACH CONDUTOR TO THE CORRESPONDING CONDUCTOR BASED BASED ON EACH CONDUCTORS INSULATION COLOR (CONNECT BLACK TO BLACK, ETC) AND CONNECT THE GROUNDING WIRE TO BOTH THE GROUNDING WIRE(S) IN THE OTHER MODULE AND THE J BOX GROUNDING SCREW. IF MORE THAN ONE CIRCUIT IS TO BE CONNECTED IN THE SAME JUNCTION BOX, VERIFY THAT THE CORRECT CIRCUITS ARE BEING SPLICED. TOGETHER BEFORE CONNECTING ANY WIRES TOGETHER.

THE DETAIL BELOW IS SHOWN FOR ELECTRICAL CROSS-OVER CONNECTIONS INSTALLED BELOW THE FLOOR SYSTEM. THESE SAME PROCEDURES SHOULD BE USED FOR ELECTRICAL CROSS OVER CONNECTIONS LOCATED IN THE ATTIC. INSPECT THE ATTIC NEAR THE MATE LINE FOR ALL SUCH REQUIRED ELECTRICAL CROSSOVER CONNECTIONS.

> WIRE CONDUTORS REQUIRED TO BE CONNECTED TO THE J BOX IN OTHER MODULE TO COMPLETE THE ELECTRICAL CROSSOVER CONNECTION (EXTRA WIRE TO BE COILED AND INSTALLED IN FRAMING CAVITY AT FACTORY TO ENABLE ON SITE CROSSOVER CONNECTION)

USE "UL LISTED" WIRE TO TWIST CONNECTORS (I.E. WIRE NUTS) TO CONNECT THE CURRENT CARRYING CONDUCTORS TOGETHER IN ACCORDANCE WITH THE MANUFACTURER'S INSTRUCTIONS, USE AN APPROVED CRIMP TYPE CONNECTOR (NON-REMOVABLE CONNETOR) TO CONNECT THE GROUNDING WIRES TOGETHER. SUPPORT ALL CIRCUITS AND/OR INSTALL LISTED CABLE STAPLES OR FASTENINGS WITHIN 6" OF THE J BOX.


> RE-INSTALL THE JUNCTION BOX COVER PLATE AND TEST EACH CIRCUIT AS REQUIRED BY THE LOCAL BUILDING OFFICIAL (HAVE ALL WORK INSPECTED AND APPROVED BY THE LOCAL BUILDING OFFICIAL BEFORE INSTALLING THE J BOX COVER OR TURNING ON THE POWER TO THE BUILDING OR CIRCUIT.)

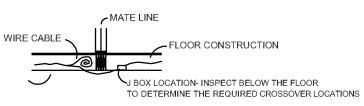


NOTE: ALTERNATE LOCATION FOR CROSSOVERS IN ATTIC NEAR ATTIC ACCESS

			Designa	ition							
NORTHSTAR SYSTEMBUILT				NS5254-AB-CO							
CIRCUIT	Breaker	Wire Size	GFCI Recept	Circu	ıit No.	GFCI Recept	Wire Size	Breaker	CIRCUIT		
Surge				1	2		12-2	20A	#1 Lights		
								AFCI			
Surge				3	4		12-2	20A	#2 Lights		
				Ů	L.			AFCI			
Kitchen #5	20A	12-2	X	5	6	x	12-2	20A	Kitchen #6		
	AFCI				Ľ			AFCI			
				7	8		12-2	20A	Dishwasher		
Range	40A	8-3			Ľ			Dual			
	GFCI	_ ` `		9	10		12-2	20A	Refrigerator		
					L.			Dual			
Microwave	20A	12-2		11	12		12-2	20A	Dining Room		
	Dual				<u> </u>			AFCI			
Bed #1	20A	12-2		13	14		12-2	20A	Living Room		
	AFCI							AFCI			
Bed #2	20A	12-2		15	16	x	12-2	20A	Bath #1		
	AFCI							AFCI			
Bed #3	20A	12-2		17	18	x	12-2	20A	Bath #2		
	AFCI							AFCI			
Exterior GFCI	20A	12-2	×	19	20						
	AFCI										
Hall	20A	12-2		21	22						
	AFCI										
				23	24						
				25	26						
				27	28						
				29	30						
				31	32						
					-						
				33	34						
				25	20						
			1	35	36						
				37	38						
				31	30						
				39	40						
					70						

200 AMP PANEL REQUIRED SEE ATTACHED SERVICE LOAD CALCULATION SHEET

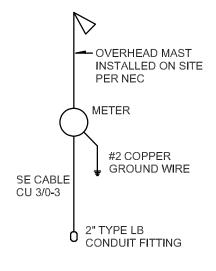

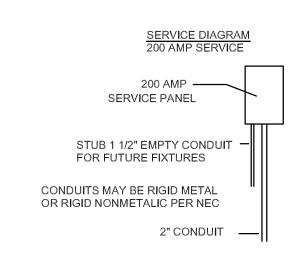

ELECTRICAL NOTES:

WITH THE APPROPRIATE ARTICLES OF THE NEC.

ACCESSIBLE CRICUIT BREAKER.

BY LOCAL ELECTRICAL CONSULTANT.

LOCATED IN THE FLOOR OR IN THE ATTIC.

CIRCUITS TO BE COPPER SE CABLE (75°C)

BE THE PHOTOELECTRIC TYPE.

REMOVED.

OR NEAR THE VICINITY OF THE ACCESS PANEL

AND TERMINATE AT AN APPROVED VENT CAP.

1. ALL CIRCUITS AND EQUIPMENT SHALL BE GROUNDED IN ACCORDANCE

HEATERS SERVED. THE BRANCH CIRCUIT SWITCH OR CIRCUIT BREAKERS

WATER HEATER OR IS CAPABLE OF BEING LOCKED IN THE OPEN POSITION.

2. WHEN WATER HEATERS ARE INSTALLED THEY SHALL BE PROVIDED

WITH READILY ACCESIBLE DISCONNECTS ADJACENT TO THE WATER

SHALL BE PERMITTED TO SERVE AS DISCONNECTING MEANS ONLY

WHERE THE SWITCH OR CIRCUIT BREAKER IS WITHIN SIGHT FROM THE

DISCONNECTS ADJACENT TO THE EQUIPMENT SERVED. A UNIT SWITCH

EQUIPMENT AND DISCONNECTS ALL UNGROUNDED CONCUCTORS SHALL

4. PRIOR TO ENERGIZING THE ELECTRICAL SYSTEM, THE INTERRUPTING

5. THE MAIN ELECTRICAL PANEL, SERVICE DISCONNECT (MAIN CIRCUIT

BREAKERS) AND FEEDERS ARE SITE INSTALLED, DESIGNED BY OTHERS

3. HVAC EQUIPMENT SHALL BE PROVIDED WITH READILY ACCESIBLE

WITH A MARKED "OFF" POSITION THAT IS A PART OF THE HVAC

BE PERMITTED AS THE DISCONNECTING MEANS WHERE OTHER

RATING OF THE MAIN BREAKER MUST BE DESIGNED AND VERIFIED BY AS BEING IN COMPLIANCE WITH SECTION 110-9 OF THE NEC,

AND SUBJECT TO LOCAL JURISDICTION REVIEW AND APPROVAL 6. ALL CIRCUITS CROSSING OVER MODULAR MATING LINE(S) SHALL BE SITE CONNECTED WITH APPROVED ACCESSIBLE JUNCTION BOXES,

7. ALL CIRCUITS TO BE COPPER NM EXCEPT HVAC AND RANGE

TO ANY OF THE INSTALLED GENERAL LIGHTING CIRCUITS) 9. RECEPTACLES INSTALLED IN WET LOCATIONS MUST BE IN A WEATHERPROOF ENCLOSURE WITH INTEGRITY OF WHICH IS NOT AFFECTED WHEN THE ATTACHMENT PLUG CAP IS INSERTED OR

8. ATTIC ACCESS SHALL HAVE SWITCHED LIGHT AND OUTLET AT

10. SMOKE DETECTORS MUST BE WIRED TO ACTIVATE ALL ALARMS SIMULTANEOUSLY IF ANY DETECTOR IS ACTIVATED. ALL SMOKE

11. ALL FANS MUST BE DUCTED TO THE EXTERIOR OF THE BUILDING

DETECTORS LOCATED WITHIN 20 FEET OF A COOKING APPLIANCE SHALL

12. PROVIDE TYPE "B" LIGHT FIXTURE & DUPLEX RECEPT IN CRAWL SPACE.

PAGE:

DISCONNECTING MEANS ARE ALSO PROVIDED BY A READILY




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ELECTRICAL NOTES AND SCHEDULES

ROCKY MOUNTAIN HOMES DRAWN BY: ML DATE: 8/26/24 REV: X BY: X DATE: X SCALE: N.T.S.

ELECTRIC	AL LEGEND
SYMBOL	DESCRIPTION
\$	SWITCH
\$	3-WAY SWITCH
#	120V DUPLEX RECEPTACLE
+	120V DUPLEX SPLIT RECEPTACLE
	120V WEATHER PROOF GFCI DUPLEX RECEPTACLE
=	240V RECEPTACLE
<u>o</u>	VANITY WALL MOUNT LIGHT
M	EXHAUST FAN/LIGHT
•	PENDANT LIGHT
0	LED LIGHT
0	DIRECTIONAL RECESSED LIGHT
ф	STANDARD LIGHT
\$	CHANDELIER LIGHT
2	WALL SCONCE
99	SMOKE DETECTOR
8 ®	CO/SMOKE DETECTOR
	UNDER CAB. LIGHT
	EXTERIOR WALL LIGHT
0	JUNCTION BOX
Ω	WALL MOUNTED LIGHT
	CEILING FAN OR FAN/LIGHT-SEE PLAN FOR INFO
8-7-1 1-1-1-1-1-1-1-1-1-1-1-1-1-1-1-1-1-1	DOOR CHIMES
Ĥ	HUMIDISTAT
仓	THERMOSTAT
\Rightarrow	TV
®	PHONE
•	FISHWIRE LOCATION

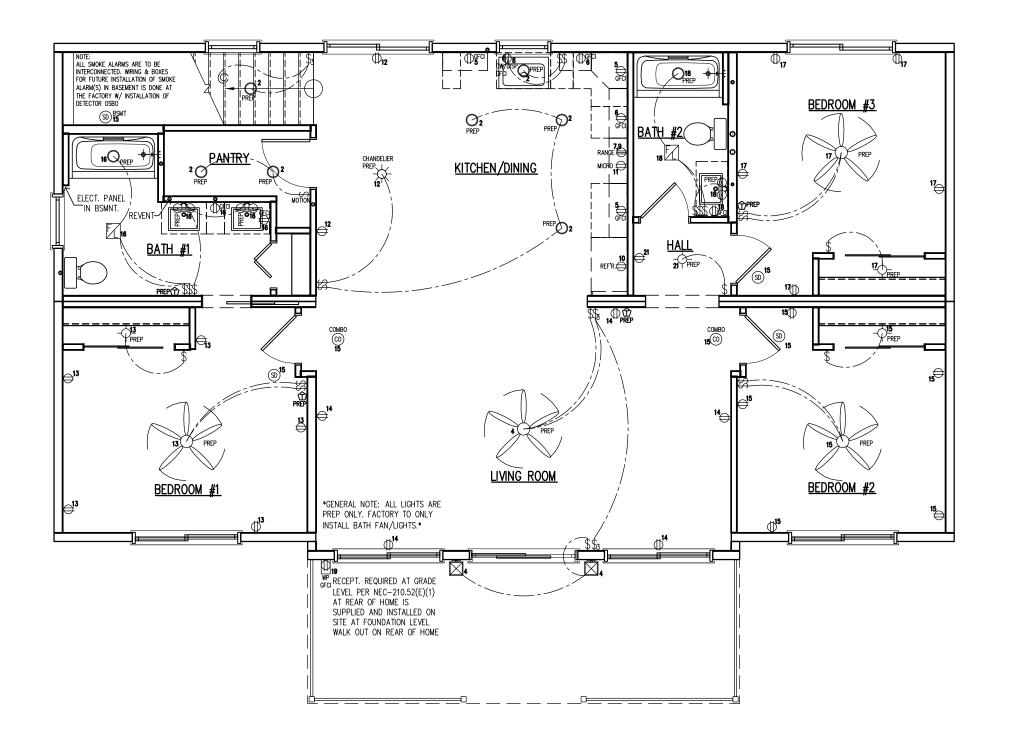

SEE SHEET A1.1




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MAIN LEVEL ELECTRICAL PLAN

ER: ROCKY MOUNTAIN HOMES DRAWN BY: MW SCALE: 3/16"=1'-0" DATE: 5/16/24 DATE: 8/26/24 REV: C BY: ML

PAGE:

A4.1

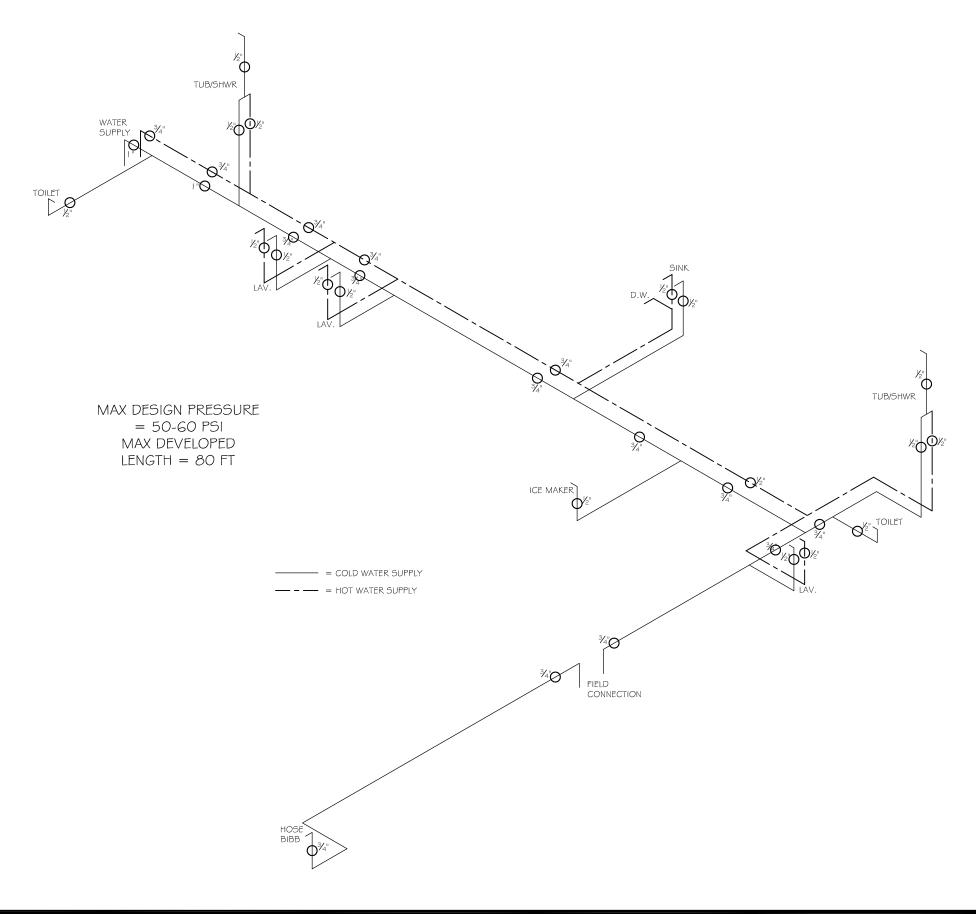

GENERAL NOTES: SEE SHEET A1.1



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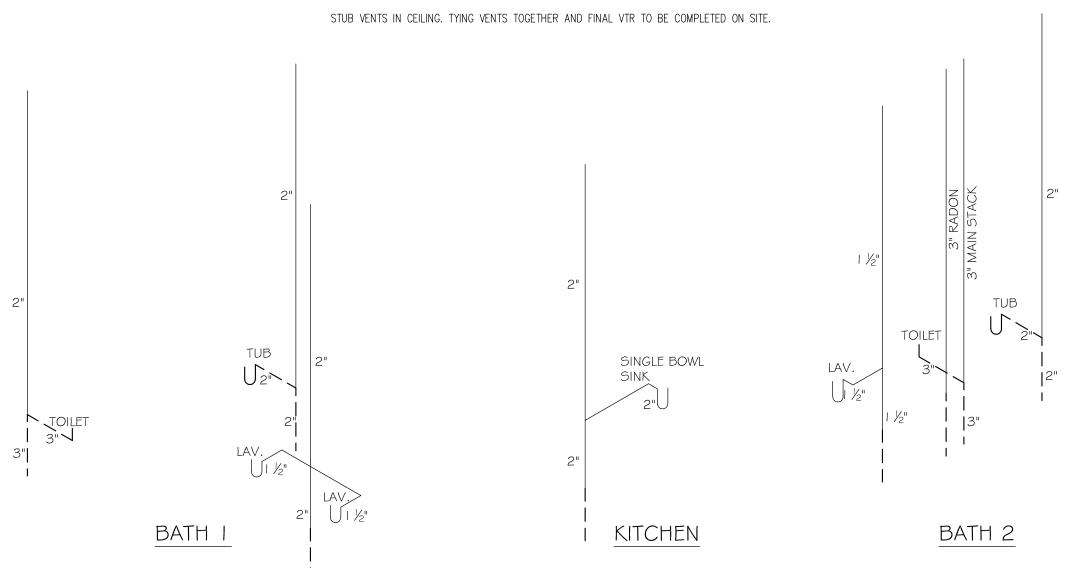
SUPPLY LINES

PAGE: DRAWN BY: ML OMER: FINCH REV: X BY: X DATE: 8/26/24 DATE: X SCALE: N.T.S.

SLOPE OF HORIZON	ITAL DRAINAGE PIPE
SIZE	MINIMUM SLOPE
(INCHES)	(INCH PER FOOT)
2 1/2" OR LESS	1/4
3" TO 6"	1/8
8" OR LARGER	1/16
	SIZE (INCHES) 2 1/2" OR LESS 3" TO 6"

PIPE SUPPORT

PVC: HORIZONTAL=4', VERTICAL=10'



ALL PLUMBING VENTS ARE STUBBED OFF IN ATTIC, AND THE PLUMBING VENT SYSTEM IS COMPLETED ON SITE BY OTHERS. SUBJECT TO LOCAL APPROVAL.

CHANGE ALL VTR'S TO 3"; VTR PIPING FOR FREEZE PROTECTION EXTEND MIN. 12" ABOVE THE ROOF.

*WASHER STANDPIPE SHALL EXTEND NOT LESS THAN 18" BUT NOT GREATER THAN 42" ABOVE TRAP WEIR.


GENERAL NOTES: SEE SHEET A1.1

M
▼ NORTHSTAR
SYSTEMBUILT

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DWV LINES

NS5254	DEAL	ER: RC	CKY MOUNT	TAIN HOMES	PAG
DRAWN BY:ML	CUST	OMER:	FINCH		\triangle
DATE: 8/26/24	REV: X	BY: X	DATE: X	SCALE: N.T.S.	/

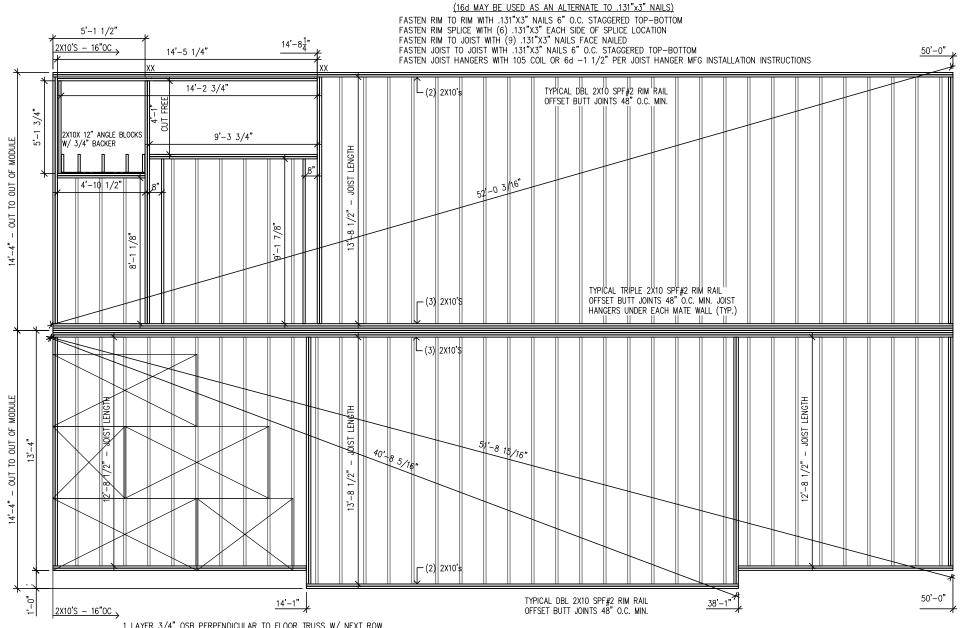


1 LAYER 3/4" OSB PERPENDICULAR TO FLOOR TRUSS W/ NEXT ROW STAGGERED @ 4' O.C. (STURDI-FLOOR, EXP 1, 20" O.C.) T&G EDGES *FASTENED W/ 100% GLUE AND .131"X2 3/8" 4" O.C. EDGES AND 8" O.C. FIELD.



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MAIN LEVEL FLOOR FRAMING

ROCKY MOUNTAIN HOMES PAGE: DRAWN BY: ML SCALE: 3/16"=1'-0" REV: X BY: X DATE: 8/26/24 DATE: X



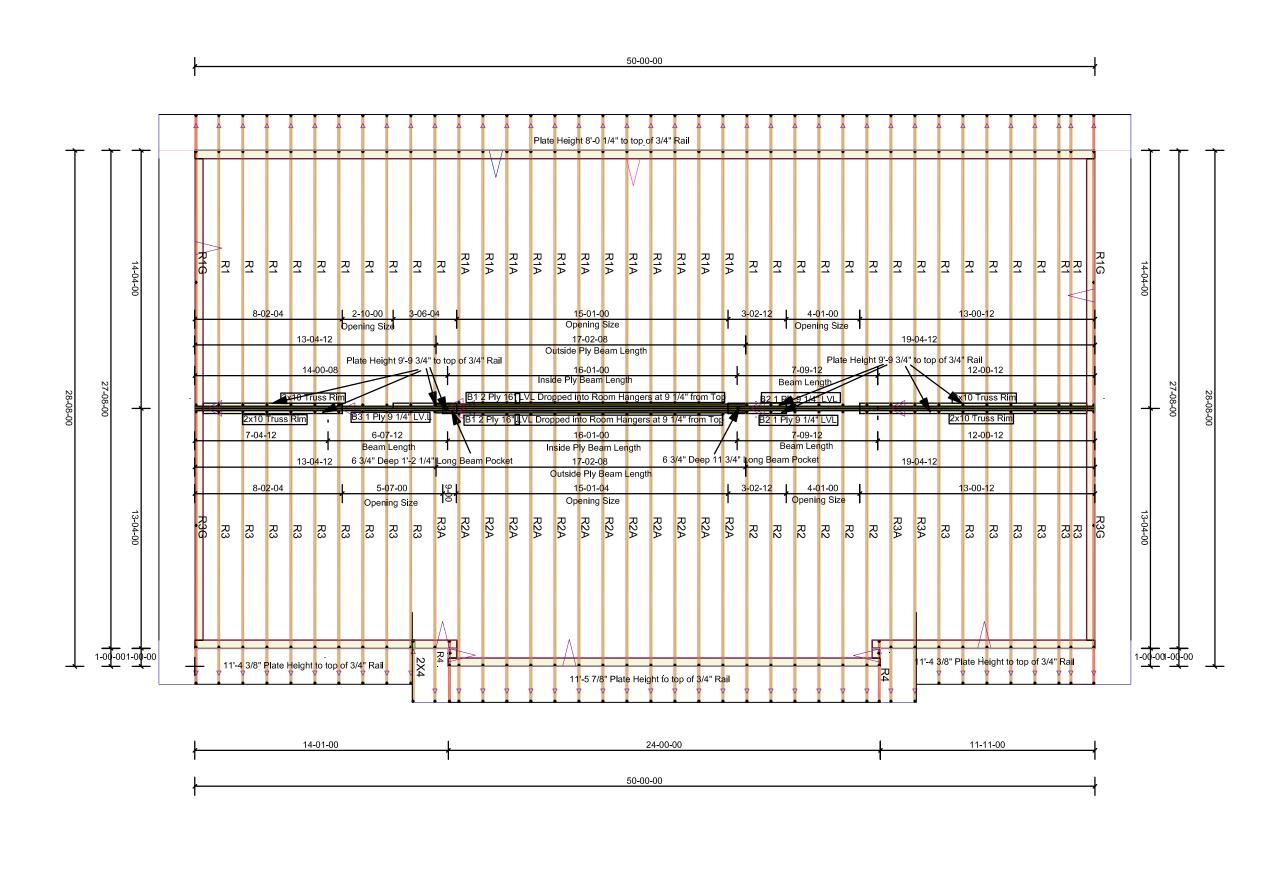

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TRUSS LAYOUT

ROCKY MOUNTAIN HOMES PAGE: DRAWN BY: RS REV: X BY: X SCALE: 3/16"=1'-0" DATE: 8/2/24 DATE: X

A8.1

			CALCUL				
		(220.	82 - NEC 2	2023)		NORT	
						13 131	EMBUII
Duilding Type: 21	Box-Custom Home	NCE2E4					1
Building Type: 2 I	Box-Custom Home	- NS5254					
Air Conditioning (100%)	*	Area			Watts or '	Volt-Amps	
Central Electric Space I	Heating	0	x 0.65*		(0	
Less than 4 separately							
electric space heating u	inits	0	x 0.65			0	
Equip of page 25-5-5-1-1-1	r oontrolled						
Four or more separately		0	v 0.40			<u> </u>	
electric space heating u	IIIIIS	U	x 0.40			0	
* Use the larger of the a	ir-conditioning loa	d or					
the diversified demand							
Other loads:	Area		Watts		Circuit		Wire si
General lighting (1st flo	or) 1408	x 3	4224		20A		12-2 W/
General lighting (2nd flo		x 3	0		20A		12-2 W/
General lighting (Bsmt)	0	x 3	0		20A		12-2 W/
Small appliances	5	x 1500	7500		20A		12-2 W/
Range (at nameplate rat	-	X 1000	10400		40A		8-3 W/0
Dishwasher	9/		1200		20A		12-2 W/
Garbage disposal			700		20A		12-2 W/
Fan/Light (2@150)			300		20A		12-2 W/
			0				
	SUB-TOTA	AL	24324				
First 10 KW of other loa			4			10000	
Remainder of other load	ds @ .40%		14324	x .40		5729.6	
Heat (Above)						0	
		TOTA	L CALCU	JLATED	LOAD	15730	
De muine d'Octubre		0.40	05.54				
Required Service si	ze 15730	240 =	65.54	amps			
Installed Panel s	ize	200	Amp P	anel			
	125	200		ariei			