ARCHITECT SPROUT AEC, LLC SCOTT BEANS SCOTT@SPROUTAEC.COM 970.759.3745 CIVIL ENGINEER FOUR POINTS SURVEYING AND ENGINEERING	STRUCTURAL ENGINEER SPROUT AEC, LLC SCOTT BEANS SCOTT@SPROUTAEC.COM 970.759.3745 GENERAL CONTRACTOR ALPINE MASTER BUILDERS	SITE INFORMATION: ADDRESS: PARCEL #: LOT SIZE: OCCUPANCY CLASSIFICATION: APPLICABLE BUILDING CODES:	2021 IRC/IBC 2021 IECC
WALTER MAGILL WALTERM@FOURPOINTSSE.COM 970.819.1161 GEOTECHNICAL ENGINEER WESTERN SLOPE GEOTECH HAL SCHLICHT HAL@WSGEOTECH.COM	CODY KUROWSKI CKUROWSKI@ALPINEMB.COM 970.819.6729	SQ FOOTAGE:	2021 IWUIC 2023 NEC 2023 STATE OF COLORADO MODEL ELECTRIC AND SOLAR READY CODE AS WELL AS ANY ADDITIONAL APPLICABLE CODES AS REQUIRED BY THE ROUTT COUNTY REGIONAL BUILDING DEPARTMENT FINISHED INTERIOR 6,663 SQ FT GARAGE 1,363 SQ FT MECHANICAL/STORAGE 630 SQ FT EXTERIOR DECKS AND PATIOS 2,339 SQ FT
970.875.4075			
	PROJECT DIRECTORY NO SCALE 7		PROJECT INFORMATION NO SCALE
REQUIRED PROPOSED CLIMATE ZONE N/A 7 ROOF/CEILING R-60 R-60 WOOD FRAME WALL R-20+5 R-29 (A) BASEMENT WALL R-15/19 R-15/19 (B) FLOOR R-38 R-38 SLAB-ON-GRADE R-10, 4 FT R-10 (C) WINDOW U-0.30 U-0.30 DOOR U-0.30 U-0.30 DOOR U-0.30 U-0.30 A. 2" CLOSED CELL SPRAY FOAM (R-14) + 3.5" FIBERGLASS BAT B. FOUNDATION EXTERIOR FACE (CONTINUOUS) MINIMUM INSTIBULATION: R-19. C. 2" RIDGID INSULATION; VERTICAL FACE OF INSULATION TO (A+B = 4 FEET). D. PROVIDE CLASS II VAPOR RETARDER AT WARM SIDE OF EXT E. ALL PIPING AND WATER DRAINS NEAR EXTERIOR WALLS SHFOAM INSULATION. F. INSULATE WITH MIN. R-8 BATT AROUND ALL DUCTING TO F G. ALL MECHANICAL SYSTEM PIPING SHALL BE WRAPPED WITH H. ALL CIRCULATING HOT WATER SYSTEM PIPING SHALL BE WINSULATION. I. NOT USED. J. PROVIDE R-38 FIBERGLASS BATT INSULATION IN ALL INTER ALL INTERIOR WALLS.	TT (R-15). ULATION: R-15; FOUNDATION INTERIOR FACE (CAVITY) MINIMUM EXTEND MINIMUM 2 FEET BELOW GRADE AT FACE OF SLAB; TERIOR WALLS AS INDICATED IN WALL ASSEMBLIES. ALL BE WRAPPED WITH MIN. R-8 PRE-FORMED POLYETHYLENE EXTERIOR, INCLUDING EXHAUST FAN. I MIN R-3 PRE-FORMED POLYETHYLENE FOAM INSULATION. IRAPPED WITH MIN. R-8 PRE-FORMED POLYETHYLENE FOAM IOR FLOORS; PROVIDE R-15 FIBERGLASS BATT INSULATION AT	PRO (LOT US H	MEADOW CREEK DRIVE DRIVE DIECT SITE T 41)
	INSULATION REQUIREMENTS NO SCALE 8		VICINITY MAP NO SCALE

	SHEET NUMBER	SHEET NAME		WENT
33170 MEADOW CREEK DRIVE STEAMBOAT SPRINGS, CO 80487 270400041	A000 A001	PROJECT COVER SHEET ABBREVIATIONS AND SYMBOLS		
5.03 ACRES	A010 A011	ARCHITECTURAL SITE PLAN DRIVEWAY ISOMETRIC VIEW		ENGINEERING + CONSTRUCTI 628 OAK STREET 5COTT@SPROUTAEC.COM 970.759.3745
R-3 2021 IRC/IBC	C1 C2	CIVIL COVER SHEET EXISTING CONDITIONS PLAN		OAK STREE SPRINGS, 3749.00
2021 IECC 2021 IWUIC	C3 C4	CIVIL OVERALL SITE PLAN DRIVEWAY SECTION AND PROFILE		628 - 628 -
2023 NEC 2023 STATE OF COLORADO MODEL ELECTRIC AND SOLAR READY CODE AS WELL AS ANY ADDITIONAL APPLICABLE CODES AS REQUIRED BY THE	C5 C6	GRADING AND DRAINAGE PLAN BUILDING GRADING AND DRAINAGE PLAN		
ROUTT COUNTY REGIONAL BUILDING DEPARTMENT	C7 C8	UTILITY PLAN CONSTRUCTION SITE MANAGEMENT PLAN		ARCHITE
FINISHED INTERIOR6,663 SQ FTGARAGE1,363 SQ FTMECHANICAL/STORAGE630 SQ FT	C9	PHASING PLAN		
EXTERIOR DECKS AND PATIOS 2,339 SQ FT	A100 A110 A111	OVERALL PLANS LOWER LEVEL FLOOR PLAN MAIN LEVEL FLOOR PLAN		
	A112 A113	WAIN LEVEL FLOOR FLAN UPPER LEVEL FLOOR PLAN ROOF PLAN		
	A120 A200	CRAWLSPACE PLAN EXTERIOR ELEVATIONS		
	A201 A210	EXTERIOR ELEVATIONS EXTERIOR 3-D VIEWS		
	A300 A301	BUILDING SECTIONS BUILDING SECTIONS DUILDING SECTIONS		
	A302 A500 A600	BUILDING SECTIONS DOOR & WINDOW SCHEDULES ARCHITECTURAL DETAILS		шь
	S000	STRUCTURAL TITLE SHEET		RESIDENCE CREEK DRIVE RINGS, CO 80487
	S001 S100	STRUCTURAL GENERAL NOTES FOUNDATION PLAN		SIDE 5, CO
	S101 S102	LOWER LEVEL FRAMING PLAN MAIN LEVEL FLOOR FRAMING AND GARAGE FOUNDATION PLAN		RES / CRE RINGS
PROJECT INFORMATION	S103 S104	UPPER LEVEL FLOOR AND LOW ROOF FRAMING PLAN HIGH ROOF FRAMING PLAN		ERS ADOW AT SP
NO SCALE 4	S200 S201	STRUCTURAL DETAILS - CONCRETE STRUCTURAL DETAILS - CONCRETE STRUCTURAL DETAILS - WOOD		WIEMERS RESII 33170 MEADOW CREEK STEAMBOAT SPRINGS, (
	S210 S211 S220	STRUCTURAL DETAILS - WOOD STRUCTURAL DETAILS - WOOD STRUCTURAL DETAILS - STEEL		331. STE.
	5220	STRUCTURAL DETAILS - STELL		
				PRADO LICEN
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MEADOW CREEK PANORAMA DRIVE DRIVE				
GOLDEN GOLDEN EAGLE				REVIEWED FOR
DJECT SITE DRIVE				CODE
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				01/08/2025
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VICINITY MAP NO SCALE 5		SHEET INDEX NO SCALE	2	SHEET
				/ER
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				PROJECT COVER
				РК
				DATE DESCRIPTION
				10.28.2024 PERMIT SET
		EXTERIOR PERSPECTIVE		A000
		NO SCALE	3	AUUU

- 1. THIS SET OF DRAWINGS CONSISTS OF A 'BUILDER'S SET' AND INCLUDES ONLY MINIMUM ARCHITECTURAL INFORMATION REQUIRED TO ACQUIRE A BUILDING PERMIT. INTERIOR FINISHES AND FIXTURES, APPLIANCES, DETAILING, SYSTEM ASSEMBLIES, FINAL SITE UTILITIES, ETC. THAT ARE NOT REQUIRED BY THESE DOCUMENTS BECOME THE OWNER'S AND CONTRACTOR'S RESPONSIBILITY TO DESIGN, VERIFY, NEGOTIATE, AND COMPLETE. THE CONTRACTOR SHALL PROVIDE ALL LABOR, MATERIALS, EQUIPMENT, SUPPLIES, SUBCONTRACTORS, TAXES, INSURANCE, TAP FEES, SITE UTILITIES, GRADING, SOIL RETENTION, ETC. TO PROVIDE A COMPLETE JOB FOR CERTIFICATE OF OCCUPANCY.
- RELEASE OF THESE DRAWINGS REQUIRES FURTHER COOPERATION AMONG THE OWNER, HIS CONTRACTOR, THE ARCHITECT, AND THEIR CONSULTANTS. DESIGN AND CONSTRUCTION ARE INHERENTLY COMPLEX, AND ALTHOUGH THE ARCHITECT AND THEIR CONSULTANTS HAVE PERFORMED THEIR SERVICES WITH DUE CARE AND DILIGENCE, THEY CANNOT GUARANTEE PERFECTION. COMMUNICATION IS IMPERFECT, AND EVERY CONTINGENCY CANNOT BE ANTICIPATED. ANY AMBIGUITY OR DISCREPANCY DISCOVERED BY THE USE OF THESE PLANS SHALL BE REPORTED IMMEDIATELY TO THE ARCHITECT. FAILURE TO COOPERATE BY NOTICE TO THE ARCHITECT PRIOR TO ANY CONSTRUCTION RELIEVES ARCHITECT OF ALL LIABILITY AND RESPONSIBILITY FROM THE CONSEQUENCES. ADDITIONALLY, FAILURE TO NOTIFY THE ARCHITECT COMPOUNDS MISUNDERSTANDING AND INCREASES CONSTRUCTION COSTS. CHANGES MADE FROM THE PLANS WITHOUT THE CONSENT OF THE ARCHITECT ARE UNAUTHORIZED AND SHALL RELIEVE THE ARCHITECT OF RESPONSIBILITY FOR ALL CONSEQUENCES ARRIVING OUT OF SUCH CHANGES.
- ALL CONTRACTORS, SUBCONTRACTORS, MATERIAL SUPPLIERS AND CONTRACT LABORERS SHALL CARRY THE MINIMUM INSURANCE TO HOLD THE OWNER AND ARCHITECT HARMLESS, INCLUDING, BUT NOT LIMITED TO, WORKMAN'S COMPENSATION (AND/OR MEDICAL AND DISABILITY) AND LIABILITY INSURANCE IN ACCORDANCE WITH ARTICLE 11 OF THE AMERICAN INSTITUTE OF ARCHITECTS' DOCUMENT A201, LATEST EDITION.
- THE OWNER SHALL CARRY MINIMUM INSURANCE INCLUDING, BUT NOT LIMITED TO, LIABILITY AND PROPERTY INSURANCE IN ACCORDANCE WITH ARTICLE 11 OF THE AMERICAN INSTITUTE OF ARCHITECTS' DOCUMENT A201, LATEST EDITION. PROPERTY INSURANCE SHALL BE ON AN ALL-RISK POLICY FORM AND SHALL INSURE AGAINST THE PERILS OF FIRE AND EXTENDED COVERSAGE AND PHYSICAL LOSS OR DAMAGE INCLUDING, WITHOUT DUPLICATION OF COVERAGE, THEFT, VANDALISM, MALICIOUS MISCHIEF, COLLAPSE, FALSE WORK, TEMPORARY BUILDINGS AND DEBRIS REMOVAL, INCLUDING
- DEMOLITION OCCASIONED BY ENFORCEMENT OF ANY APPLICABLE LEGAL REQUIREMENTS. 5. ALL PERSONS DIRECTLY OR INDIRECTLY ASSOCIATED WITH THE WORK SHALL BE FAMILIAR WITH THE LATEST RULES AND REGULATIONS OF THE "OCCUPATIONAL, SAFETY, AND HEALTH ACT" AND IMPLEMENT THOSE RULES AS THEY APPLY TO THIS WORK.
- 6. ALL WORK SHALL BE PERFORMED ACCORDING TO THE LATEST APPLICABLE BUILDING CODE, SEE BUILDING CODE DATA ON TITLE SHEET.
- 7. THE CONTRACTOR SHALL BE RESPONSIBLE FOR COORDINATING THE WORK OF ALL TRADES AND THE PREVENTION OF CONFLICTS BETWEEN ALL TRADES.
- THE CONTRACTOR SHALL BE RESPONSIBLE FOR LOCATING AND PROTECTING EXISTING UTILITY LINES. LOCATIONS, IF SHOWN, ARE APPROXIMATE AND REQUIRE FIELD VERIFICATION. THE CONTRACTOR IS RESPONSIBLE FOR REPAIRING DAMAGE TO THE UTILITY LINES CAUSED BY CONSTRUCTION OPERATIONS AT NO ADDITIONAL COST TO OWNER.
 VERIFY ALL UTILITY LINES AND HOOK UP LOCATIONS PRIOR TO START OF CONSTRUCTION.
- CHANGES OR SUBSTITUTIONS TO THE DESIGN OR PRODUCTS WHICH ARE SPECIFIED IN THESE DOCUMENTS WILL ONLY BE ALLOWED WITH WRITTEN APPROVAL FROM THE OWNER OR ARCHITECT.
- MECHANICAL, ELECTRICAL & PLUMBING TO BE DESIGN-BUILD AND SHALL CONFORM TO THEIR CURRENT RESPECTIVE CODES ADOPTED BY ANY AND ALL GOVERNING AGENCIES HAVING JURISDICTION OVER THIS PROJECT.
 NO PORTION OF THE WORK REQUIRING A SHOP DRAWING OR SAMPLE SUBMISSION SHALL BE COMMENCED UNTIL THE
- SUBMISSION HAS BEEN REVIEWED BY THE ARCHITECT AND/OR ENGINEER. ALL SUCH PORTIONS OF THE WORK SHALL BE INSTALLED IN ACCORDANCE WITH REVIEWED SHOP DRAWINGS AND SAMPLES.
 ARCHITECTURAL DETAILS THAT SHOW OR INDICATE STRUCTURAL SYSTEMS AND/OR COMPONENTS ARE FOR GENERAL
- REFERENCE ONLY. REFER TO STRUCTURAL DRAWINGS FOR SYSTEM SPECIFICATIONS, DESIGN, LAYOUT, ETC. RELATED TO THEIR TRADE. 14. ANY CHANGES IN THE FIELD TO THE STRUCTURAL PLANS SHALL RELIEVE THE ARCHITECT AND STRUCTURAL ENGINEER
- 14. ANY CHANGES IN THE FIELD TO THE STRUCTURAL PLANS SHALL RELIEVE THE ARCHITECT AND STRUCTURAL ENGINEER FROM ANY CONSEQUENCES WHICH MAY ARISE. ANY PROPOSED CHANGES TO THE STRUCTURAL DOCUMENTS MUST BE APPROVED BY THE ARCHITECT AND STRUCTURAL ENGINEER IN WRITING.
 15. ARCHITECTURAL DETAILS THAT SHOW OR INDICATE MANUEACTURES COMPONENTS (L.E., DOORS & WINDOWS)
- 15. ARCHITECTURAL DETAILS THAT SHOW OR INDICATE MANUFACTURES COMPONENTS (I.E. DOORS & WINDOWS, WATERPROOFING, EXTERIOR FINISHES, ETC...) ARE FOR GENERAL REFERENCE ONLY. REFER TO EACH MANUFACTURES SPECIFICATIONS / WARRANTY, APPLICABLE BUILDING CODES AND/OR INDUSTRY STANDARDS (WHICHEVER IS MORE STRINGENT) FOR THE CORRECT INSTALLATION OF EACH COMPONENT AND ITS SEQUENCING WITH ADJACENT MATERIALS. THE PREVIOUSLY REFERENCED ENTITIES SUPERCEDE ARCHITECTURAL DETAILS INCLUDED WITHIN THIS SET WHEN THERE IS A DISCREPANCY.
- THE CONTRACTOR IS RESPONSIBLE FOR OBTAINING ALL PERMITS, INSPECTIONS, LICENSES AND APPROVALS ASSOCIATED WITH THIS PROJECT.
 ALL CONSTRUCTION AND CONSTRUCTION METHODS ARE TO BE IN ACCORDANCE WITH ALL APPLICABLE CODES AND
- GOVERNMENTAL AGENCIES HAVING JURISDICTION OVER THE PROJECT. UNDER NO CONDITION DOES THE ARCHITECT HAVE RESPONSIBILITY FOR THE MEANS OR METHODS USED BY THE CONTRACTOR IN THE PERFORMANCE OF THE WORK OR FOR CONDITIONS OF SAFETY AT THE JOB SITE.18. ALL DIMENSIONS ARE TO FACE OF STUD, FACE OF EXISTING FINISH OR FACE OF CONCRETE UNLESS NOTED.
- ALE DIMENSIONS ARE TO FACE OF STOD, FACE OF EXISTING TIMISTION FACE OF CONCRETE UNLESS NOTED.
 THE CONTRACTOR MUST VERIFY THE BUILDING LAYOUT WITH THE OWNER, CIVIL ENGINEER OR ARCHITECT PRIOR TO DIGGING THE FOOTINGS. THE CONTRACTOR SHALL BE RESPONSIBLE FOR THE ACCURATE PLACEMENT OF ALL NEW CONSTRUCTION ON THE SITE.
- 20. THE CONTRACTOR SHALL VISIT THE PROJECT SITE PRIOR TO ESTIMATING THE COST OF THE SCOPE OF WORK AND PRIOR TO ORDERING OR FABRICATING MATERIALS OR BEGINNING ANY CONSTRUCTION RELATED ACTIVITIES FOR THE PURPOSE OF BECOMING COMPLETELY FAMILIAR WITH THE SITE AND ALL EXISTING CONDITIONS WHICH MIGHT IMPACT THE COST OF OR PERFORMANCE OF THE SCOPE OF WORK.
- 21. THE CONTRACTOR IS RESPONSIBLE FOR VERIFYING ALL EXISTING CONDITIONS PRIOR TO THE COMMENCEMENT OF CONSTRUCTION.
- THE CONTRACTOR IS RESPONSIBLE FOR LOCATING AND VERIFYING ALL FINISH GRADES ON SITE.
 THE CONTRACTOR AND THEIR SUBCONTRACTORS ARE RESPONSIBLE FOR COMPLETING ALL THE WORK WITHIN THESE DOCUMENTS, UNLESS NOTED OTHERWISE.
- 24. CONTRACTOR TO VERIFY ALL DIMENSIONS PRIOR TO CONSTRUCTION. CONTRACTOR TO VERIFY BOTH ROUGH OPENINGS & FINISH OPENINGS OF ALL DOORS & WINDOWS PRIOR TO FRAMING. ALL DIMENSIONS SHALL TAKE PRECEDENCE OVER SCALE OF DRAWINGS. DRAWINGS SHOULD NEVER BE SCALED.
- 25. DIMENSIONS OF AND FROM EXISTING CONDITIONS HAVE BEEN TAKEN FROM EXISTING DRAWINGS AND/OR FIELD MEASUREMENTS. ALL EXISTING DIMENSIONS ARE TO FINISH FACE UNLESS NOTED OTHERWISE ON DRAWINGS. CONTRACTOR SHALL FIELD VERIFY ALL DIMENSIONS PERTAINING TO EXISTING CONDITIONS, INCLUDING ALL WORK ALREADY IN PLACE, PRIOR TO ORDERING OR FABRICATING MATERIALS, AND PRIOR TO START OF CONSTRUCTION.
- 26. THE CONTRACTOR SHALL VERIFY THE LOCATIONS ALL FLOOR / CEILING ASSEMBLY PENETRATIONS. ALL PENETRATIONS SHALL NOT OCCUR ON ANY SECTION OF THE JOIST. NOTIFY ARCHITECT AND STRUCTURAL ENGINEER OF ANY LOCATION THAT WOULD REQUIRE PENETRATION OF THE JOIST.
- CONTRACTOR TO PROVIDE ALL NECESSARY BLOCKING, BACKING AND FRAMING FOR LIGHT FIXTURES, ELECTRICAL UNITS, AC EQUIPMENT, MILLWORK, CASEWORK, RECESSED ITEMS AND ALL OTHER ITEMS AS REQUIRED.
 CONTRACTORS TO VERIFY ALL EQUIPMENT ROUGH-IN DIMENSIONS AND CLEARANCES WITH THE MANUFACTURERS PRIOR TO
- 28. CONTRACTORS TO VERIFT ALL EQUIPMENT ROUGH-IN DIMENSIONS AND CLEARANCES WITH THE MANUFACTURERS PRIOR TO CONSTRUCTION.
 29. PROVIDE COMBUSTION AIR & VENT GAS FOR APPLIANCES PER MANUFACTURERS REQUIREMENTS.
- ALL PENETRATIONS FROM HABITABLE SPACE TO AN ATTIC, FULLY INSULATED ROOF CEILING CAVITY OR CRAWL SPACE SHALL BE SEALED AND INSULATED.
- WHERE LARGER STUDS OR FURRING ARE INDICATED ON DRAWINGS TO COVER PIPING AND CONDUITS, THE LARGER STUD SIZE OR FURRING SHALL EXTEND THE FULL SURFACE OF THE WALL WIDTH AND LENGTH WHERE THE FURRING OCCURS.
 OWNER/ARCHITECT TO HAVE WALK-THROUGH WITH ELECTRICAL SUB-CONTRACTOR IN ORDER TO INSPECT LOCATION OF
- ELECTRICAL FIXTURES, OUTLETS, ETC. PRIOR TO INSTALLATION. 33. PROVIDE ACCESS DOORS TO ALL ATTIC SPACES GREATER THAN 24" IN HEIGHT. COORDINATE LOCATION WITH OWNER AND
- ARCHITECT AND SIZE ACCORDING TO APPLICABLE CODES. 34. WATER FROM DOWNSPOUTS TO BE DIRECTED BEYOND LIMIT OF BACKFILL, PROVIDE SPLASHBLOCKS AT EACH DOWNSPOUT. 35. GC TO COORDINATE HEAT TRACE AT ALL ROOF DRAIN, OVERFLOW DRAIN, AND GUTTER LOCATIONS W/ ROOFING AND
- ELECTRICAL SUBCONTRACTORS. 36. GC TO COORDINATE ALL DRAIN AND GUTTER/DOWNSPOUT LOCATIONS WITH MAIN LEVEL STORM PIPPING PLAN & TAPERED
- ROOF PLAN. 37. MINIMUM ROOF SLOPE = 1/4" PER FOOT.
- 38. GC TO COORDINATE EAVE ELECTRICAL OUTLETS FOR HOLIDAY LIGHTING AND HEAT TRACE W/ ELECTRICAL
- SUBCONTRACTOR AND OWNER. 39. ALL EXTERIOR DOORS AND DOORS LEADING TO UNHEATED SPACES ABOVE GRADE TO BE WEATHER STRIPPED.
- 40. PROVIDE TEMPERED GLASS AT HAZARDOUS LOCATIONS AS DEFINED BY IRC 2021 AND ALL OTHER APPLICABLE CODES. 41. ALL STAIRS, GUARDRAILS, AND HANDRAILS TO COMPLY WITH IRC STANDARDS AND REQUIREMENTS.
- 42. ALL MASONRY WORK SHALL BE INSTALLED IN ACCORDANCE WITH MASONRY STANDARDS AND MANUFACTURER'S
- RECOMMENDATIONS. 43. PROVIDE ATTIC VENTILATION AS REQUIRED BY APPLICABLE CODES. COORDINATE LOCATION OF VENTS WITH ARCHITECT PRIOR TO CONSTRUCTION.
- 44. INSTALL CONTINUOUS PERFORATED DRAINAGE PIPE AT BOTTOM OF FOOTINGS ALONG FOUNDATION WALLS DRAIN TO DAYLIGHT OR SUMP PUMP, PER GEOTECHNICAL RECCOMENDATIONS.45. STRUCTURAL LUMBER TO BE EXPOSED TO WEATHER TO BE PRESSURE TREATED OR OF NATURAL RESISTANCE TO DECAY.
- 46. PROVIDE POSITIVE DRAINAGE AWAY FROM BUILDING FOR A MINIMUM OF TEN FEET.47. PROVIDE WATER RESISTANT SHEET ROCK AT ALL APPLICATIONS WHICH MAY BE SUBJECT TO THE ADVERSE EFFECTS OF MOISTURE.
- 48. PROVIDE VENTILATION TO BATHROOMS PER M1506.1
 49. MOISTURE IS THE PREVALENT CAUSE OF MOLD GROWTH. GENERAL CONTRACTOR AND SUBCONTRACTORS ARE TO BE PROACTIVE IN THE MITIGATION OF MOISTURE DURING CONSTRUCTION. "TIGHT BUILDING" CONSTRUCTION IS ONE OF THE IMPLICATED CAUSES OF MOLD. ALL ROOFS AND OTHER UNCONDITIONED SPACES ARE TO BE VENTILATED ADEQUATELY. IF ACCESS MOISTURE IS NOTICED DURING CONSTRUCTION, THE ARCHITECT IS TO BE NOTIFIED IMMEDIATELY. ANY MODIFICATIONS TO THE PLANS REGARDING MOISTURE CONTROL DURING CONSTRUCTION SHALL BE REVIEWED BY THE ARCHITECT.
- 50. THE GARAGE SHALL BE SEPARATED FROM THE RESIDENCE BY NOT LESS THAN 1/2" TYPE 'X' GYPSUM BOARD OR EQUIVALENT, APPLIED ON THE GARAGE SIDE OF WALLS AND CEILINGS.
- 51. EMERGENCY ESCAPE AND RESCUE OPENINGS SHALL HAVE A NET CLEAR OPENING OF NOT LESS THAN 5.7 SQUARE FEET. THE NEW CLEAR HEIGHT OF THE OPENING SHALL NOT BE LESS THAN 24 INCHES, AND THE NET CLEAR WIDTH SHALL NOT BE LESS THAN 20 INCHES.
- 52. CONTRACTOR TO PROVIDE SMOKE DETECTORS & CARBON MONOXIDE DETECTORS IN ACCORDANCE WITH LOCAL APPLICABLE CODES.
- 53. CONTRACTOR TO PROVIDE A MONITORED AUTOMATIC SPRINKLER SYSTEM INSTALLED IN ACCORDANCE WITH NFPA 13D, 2021 IFC.

- 54. CONTRACTOR TO PROVIDE A KNOX BOX AT
- 55. PROVIDE ALL ACCESS PANELS AS REQUIRED
- VERIFY TYPE REQUIRED WITH ARCHITECT PF 56. THE GENERAL CONTRACTOR IS RESPONSIBLE EQUIPMENT TO PREVENT RADON BUILD-UP I OF SYSTEM THAT IS IN FULL COMPLIANCE W FOR ALL INHABITABLE AREAS. SEAL ALL PEN
- W/ INTERIOR SLAB ON GRADE.57. ALL MATERIALS STORED ON THE SITE SHALL DETERIORATION. FAILURE TO PROTECT MAT
- 58. THE JOB SITE SHALL BE MAINTAINED IN A CL UNREASONABLY ENCUMBERED WITH ANY MA COMPLETION OF EACH PHASE OF THEIR WOR
- 59. THE CONTRACTOR SHALL CONFINE THEIR OF THE PROPERTY OWNERS ASSOCIATION.
- 60. SOILS REPORTS PROVIDED BY WESTERN SLOI
- 61. THE GENERAL CONTRACTOR & APPLICABLE S
 SPECIFIED WITHIN THE SOILS REPORT IN CO
 62. A FINAL INVESTIGATION OF THE OPEN EXCA
- OF THE CONCRETE FOUNDATIONS. 63. ROUTT COUNTY REGIONAL BUILDING DEPAR
- CODE. ALL ROOFING MUST HAVE APPROVED EAVES, AND SOFFITS SHALL BE PROTECTED INCLUDING NON-COMBUSTIBLE MATERIALS (WHERE PROVIDED, GUTTERS AND DOWNSPO

FINISH TYPES - NONE

- PAINT
 THIN (2") STONE CLADDING WITH LATH,
- THICK (4") STONE CLADDING WITH LATH
 WOOD
- 5. METAL PANEL
- BOARD FORMED CONCRETE
 3/4" TBD
- 8. ASPHALT SHINGLES
- 9. STANDING SEAM METAL
 10. TPO


- SHEATHING/SUBSTRATE TYPES - NONE
- A. GYPSUM BOARD
- B. 1/2" PLYWOOD C. 1" AIR GAP
- D. ROCKWOOL INSULATION
- E. 3" RIGID INSULATION
- F. 3/4" PLYWOODG. 3/4" PLYWOOD AND GYPCRETE


GENERAL NOTES NO SCALE 12


RDANCE WITH LOCAL APPLICABLE

THE MAIN ENTRANCE ON THE ADDRESS SIDE FOR EMERGENCY ACCESS. BY GOVERNING CODES TO ALL CONCEALED SPACES, VOIDS, ATTICS, ETC. RIOR TO INSTALLATION IF NOT NOTED ON PLANS. E FOR RADON TESTING IN THE FIELD & MUST INSTALL ALL NECESSARY IN THE STRUCTURE. PROVIDE DESIGN-BUILD ENGINEERING AND CONSTRUCTION // IRC 2021 APPENDIX F. SYSTEM TO MAINTAIN LEVELS BELOW EPA STANDARDS NETRATIONS IN INTERIOR SLAB ON GRADE AND COORDINATE ALL PENETRATIONS . BE PROPERLY STACKED AND PROTECTED TO PREVENT DAMAGE AND FERIALS MAY BE CAUSE FOR REJECTION OF WORK. LEAN, ORDERLY CONDITION, FREE OF DEBRIS AND LITTER AND SHALL NOT BE ATERIALS OR EQUIPMENT. EACH SUBCONTRACTOR IMMEDIATELY UPON RK SHALL REMOVE ALL TRASH AND DEBRIS AS A RESULT OF THEIR OPERATION. PERATIONS ON THE SITE TO THE AREAS PERMITTED BY THESE DOCUMENTS AND	BUILDING GRID LINES	REVISION C
PERATIONS ON THE SITE TO THE AREAS PERMITTED BY THESE DOCUMENTS AND PE GEOTECH, PROJECT NO. 24-1031, DATED JUNE 5, 2024. SUB-CONTRACTORS SHALL FOLLOW ALL APPLICABLE RECOMMENDATIONS PORDINATION WITH STRUCTURAL DESIGN & SPECIFICATIONS. WATION BY THE SOILS ENGINEER WILL BE REQUIRED PRIOR TO THE PLACEMENT RTMENT HAS ADOPTED THE 2021 INTERNATIONAL WILD-LAND URBAN INTERFACE D CLASS A ROOFING MATERIAL PER SECTION 504.2. THE ROOF ASSEMBLY, ROOF ON THE EXPOSED UNDERSIDE BY ONE OF THE ITEMS PER SECTION 504.3, DR IGNITION-RESISTANT MATERIAL IN ACCORDANCE WITH SECTION 503.2. DUTS SHALL BE CONSTRUCTED OF NON-COMBUSTIBLE MATERIAL.	DETAIL AREA REFERENCE DRAWING NUMBER A9.2 SHEET NUMBER	MATCH SHEET NUMBER THE SHADED PORTION IS THE SIDE CONSIDERED
	WORK POINT OR CONTROL POINT	DRAWING NUMBER
	EXTERIOR ELEVATION SHEET NUMBER A200 2 - DRAWING NUMBER	SHEET NUMBER
	WINDOW TAG ROOM NUMBER 102.B WINDOW NUMBER	DOOF ROOM NUMBER 102.2 DOOR NUMBER
	DIMENSION STRING	ROOM ROOM NAME ROOM 102 - ROOM NUMBER
GENERAL NOTES NO SCALE 8	NORTH ARROW	SHEET GRID (AR) 10 7 4 1 DRA 10 7 4 1 DRA 11 8 5 2 EXA 11 8 5 2 EXA 12 9 6 3 LOC
	WALL/FLOOR/ROOF ASSEMBLY TAG ASSEMBLY TYPE DESIGNATION: (W) WALL, (F) FLOOR, (R) ROOF CONSTRUCTION TYPE: (W) WOOD, (C) CONCRETE INT OR BOT FINISH TYPE* INT OR BOT SUBSTRATE/SHEATHING TYPE* STRUCTURAL THICKNESS EXT OR TOP SUBSTRATE/SHEATHING TYPE* FW4C12B3 SHOWN HERE: WOOD FLOOR W/ TOP SUBSTRATE/SHEATHING TYPE B 12" NOM STRUCTURAL THICKNESS BOTTOM SUBSTRATE/SHEATHING TYPE C BOTTOM SUBSTRATE/SHEATHING TYPE C BOTTOM SUBSTRATE/SHEATHING TYPE C BOTTOM SUBSTRATE/SHEATHING TYPE C BOTTOM FINISH TYPE 4 *SEE 9/A001	
FINISH & SHEATHING/SUBSTRATE TYPES NO SCALE 9		SYMBOL: NO SCALI

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	@ 6	At Centerline		B0487
	φ φ	Flush Diameter or Round		* CONS' * CONS' * STREET RINGS, CO OUTAEC.CC
	#	Perpendicular Number		ENGINEERING + CONSTRUCTI ENGINEERING + CONSTRUCTI 628 OAK STREET 570.759.3745
	(E) A.C.	Existing Asphaltic Concrete		
	A.D. APPROX ARCH	Area Drain Approximate Architectural		
H LINE	ASPH	Asphalt		
	BLDG BOT B.O.C	Building Bottom Bottom of Curb		
IE ED	B.O.W. C.B.	Bottom of Wall Catch Basin		
	CIP CLR CMU	Cast In Place Clear Concrete Masonry Unit		
	CONC CONT	Concrete Continuous		
	CTR DET	Center Detail		
	DIA DIM DWG	Diameter Dimension Drawing		487 CE
	DWR	Drawer		RESIDENC
	E EJ ELEC	East Expansion Joint Electrical		REEK NGS, (
	EQ EQUIP EXT	Equal Equipment Exterior		SS R DOW C
	F.G. FF	Finish Grade Finish Floor		WIEMERS RESIDENC 33170 MEADOW CREEK DRIVE STEAMBOAT SPRINGS, CO 804
ATION	FLR FLUOR	Floor Flourescent		3317(STEA
	FTG GA	Footing Gauge		
	GALV GND GR	Galvanized Ground Grade		RADO LICENS
	GYP H.B.	Gypsum Hose Bib		00406667
	I.D.	Inside Diameter		PO406667
OR TAG	INT L.F.	Interior Lineal Foot		
	L.H. MATL	Left Hand Material		REVIEWED
	MAX MECH MFR	Maximum Mechanical Manufacturer		FOR
	MH MIN	Manhole Minimum		CODE COMPLIANCE
	MISC MTD	Miscellaneous Mounted		01/08/2025
M TAG	N N/A N.I.C.	North Not Applicable Not in Contract		
M TAG	NO NOM N.S.	Number Nominal No Scale		
	N.T.S.	Not to Scale		
	0/ 0A 0.C.	Over Overall On Center		l v
	0.D. 0.F.D. 0.H.	Outside Diameter Overflow Drain Overall Height		MBO
	P.D. P.L.	Planter Drain Property Line		SYI
RCH D)	PLMG POB	Plumbing Point of Beginning		AND
IEET RAWING	RAD R.D.	Radius Roof Drain	1	SNC
JMBER	REF REQ REV	Reference Required Revised		ATIO
(AMPLE: RAWING JMBER 2	R.H. RWD	Right Hand Redwood		REVI
THIS OCATION	S SCHED SECT	South Schedule Section		ABBREVIATIONS AND SYMBOLS
	SHT SIM	Sheet Similar		DATE DESCRIPTION
	SPEC SQ S.S.	Specification Square Stainless		10.28.2024 PERMIT SET
	STD STL SYM	Standard Steel Symmetrical		
	T.O. T.O.C.	Top of Top of Curb		
	T.O.D. T.O.P. T.O.S.	Top of Drain Top of Pavement Top of Slab		
	T.O.W. TBD	Top of Wall To Be Determined		
	TYP	Typical Unfinished		
	U.N.O. VERT	Unless Noted Otherwise Vertical		
	V.I.F. W	Verify in Field		
	W/ W/O	With Without		
	WD WP WPM	Wood Waterproof Waterproof Membrane		
LSZ	WT	Weight	ABBREVIATIONS	A001
E 6			ABBREVIATIONS NO SCALE 3	AUUI

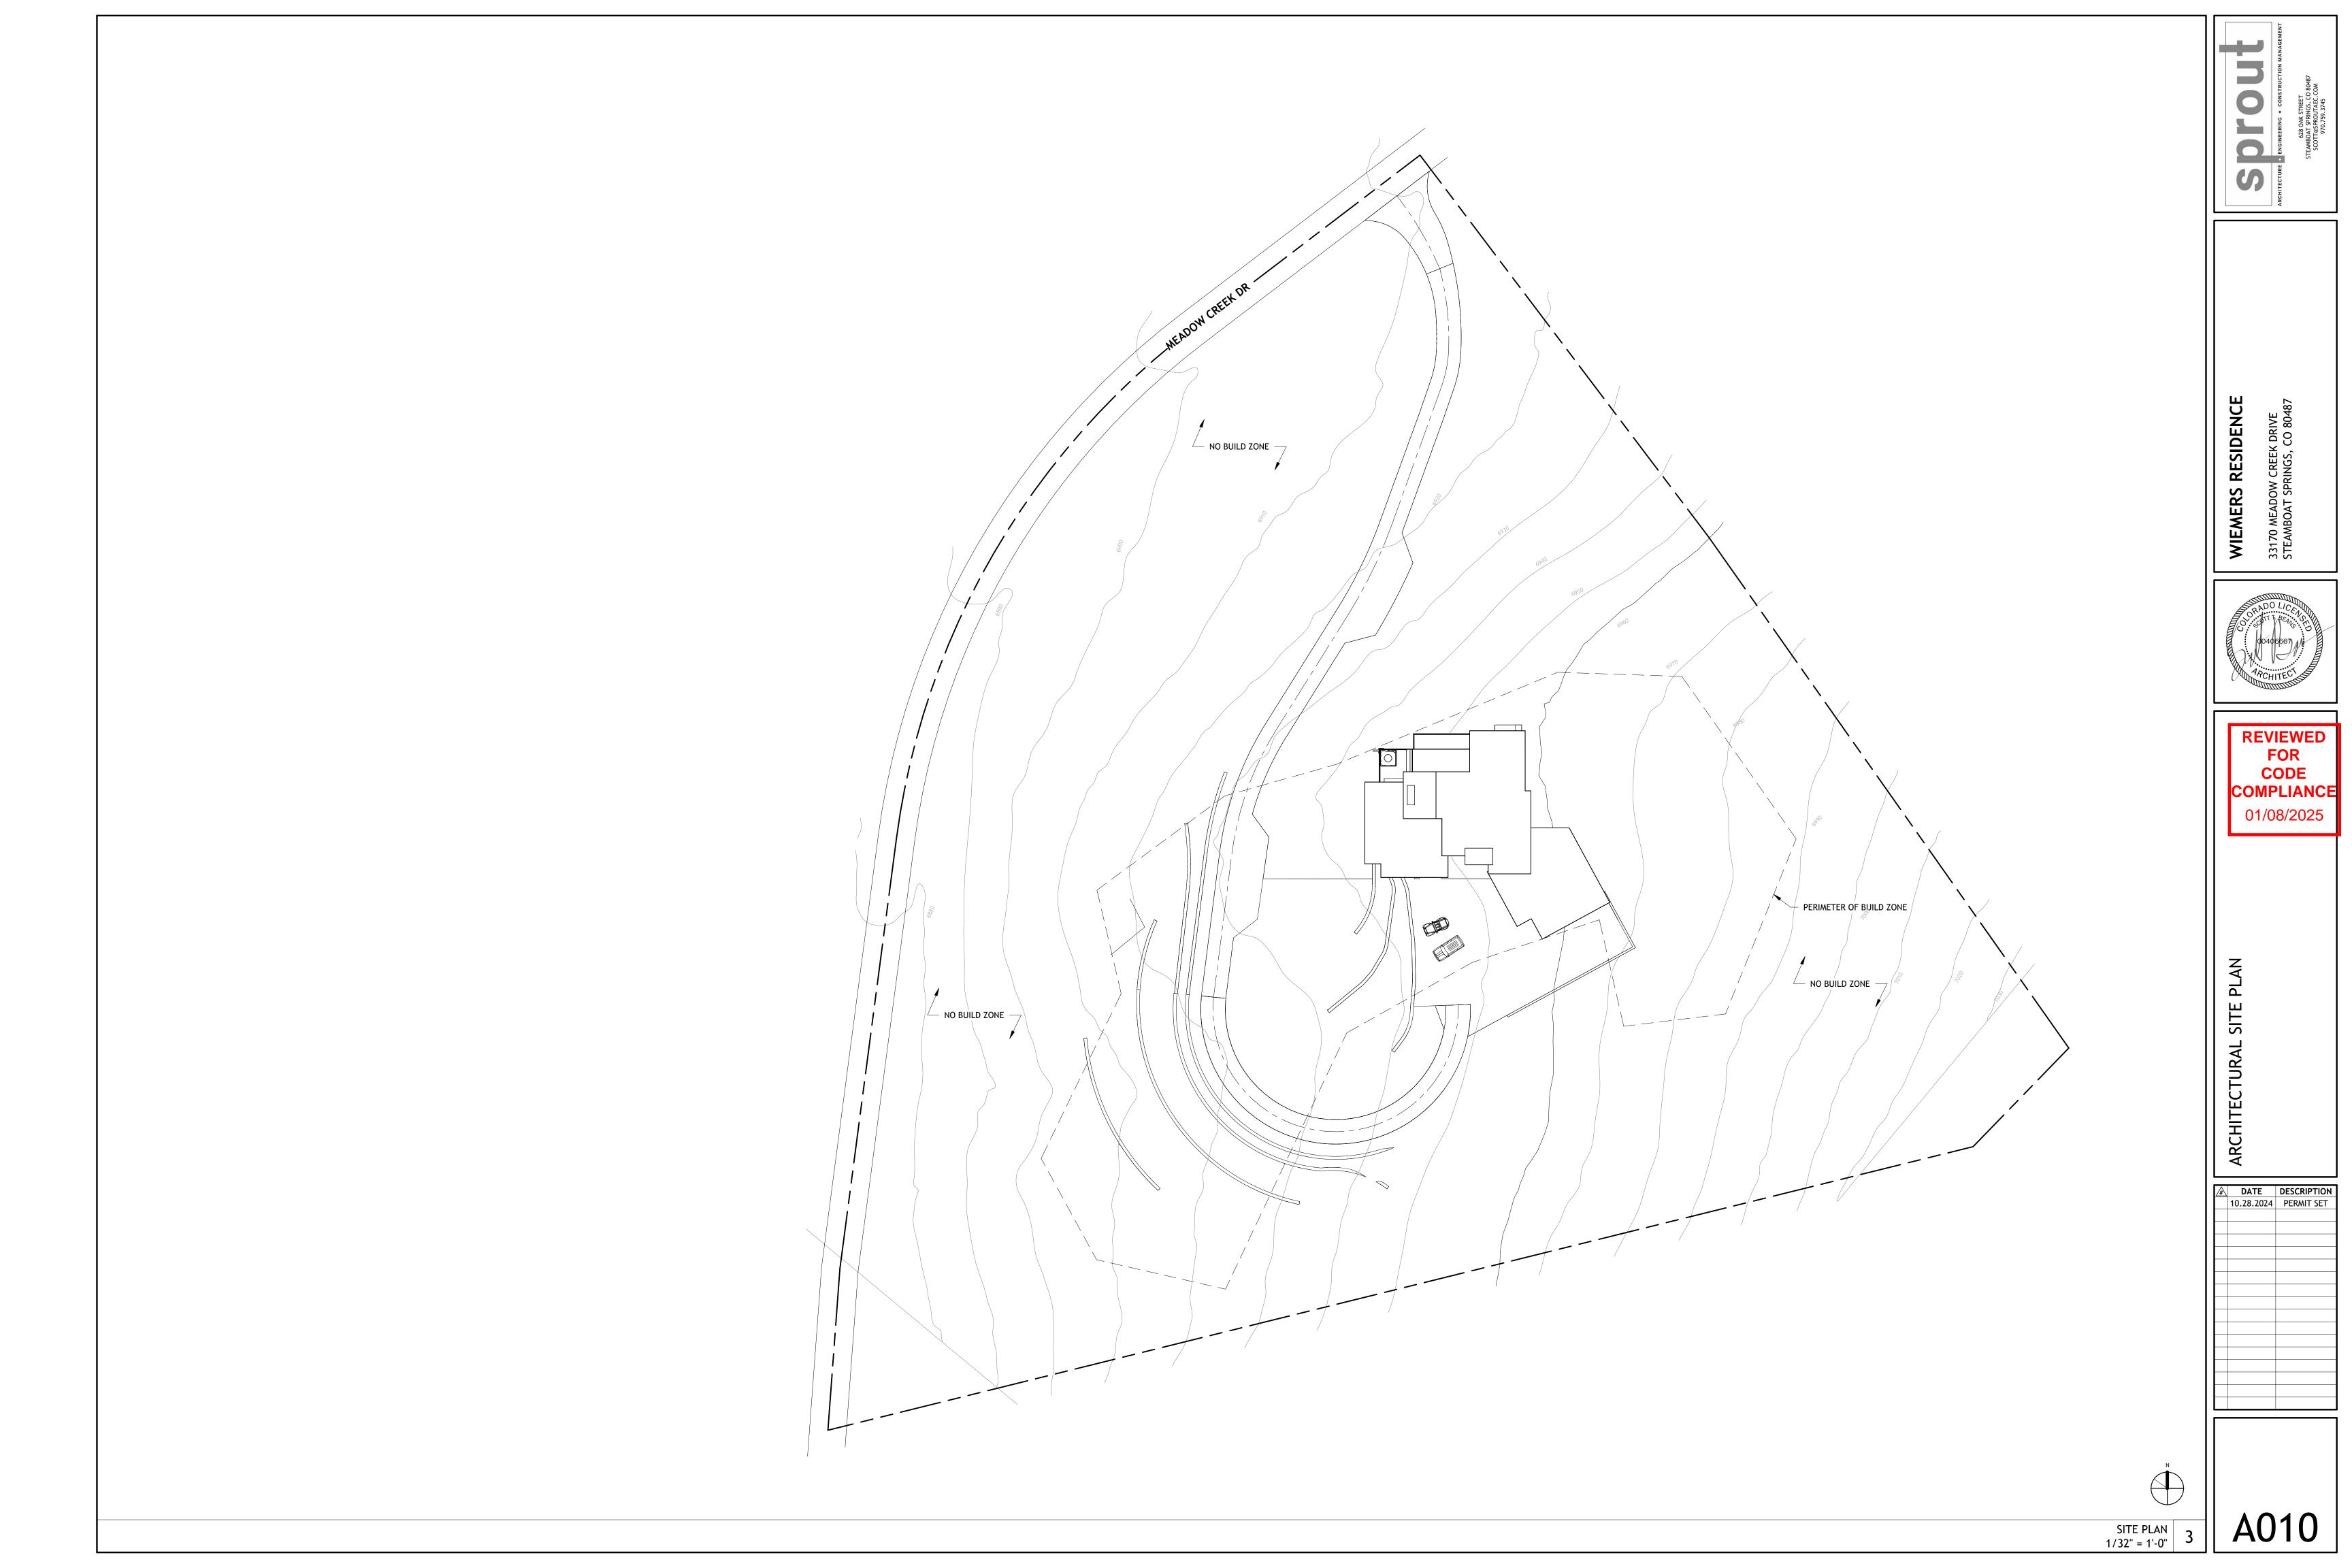

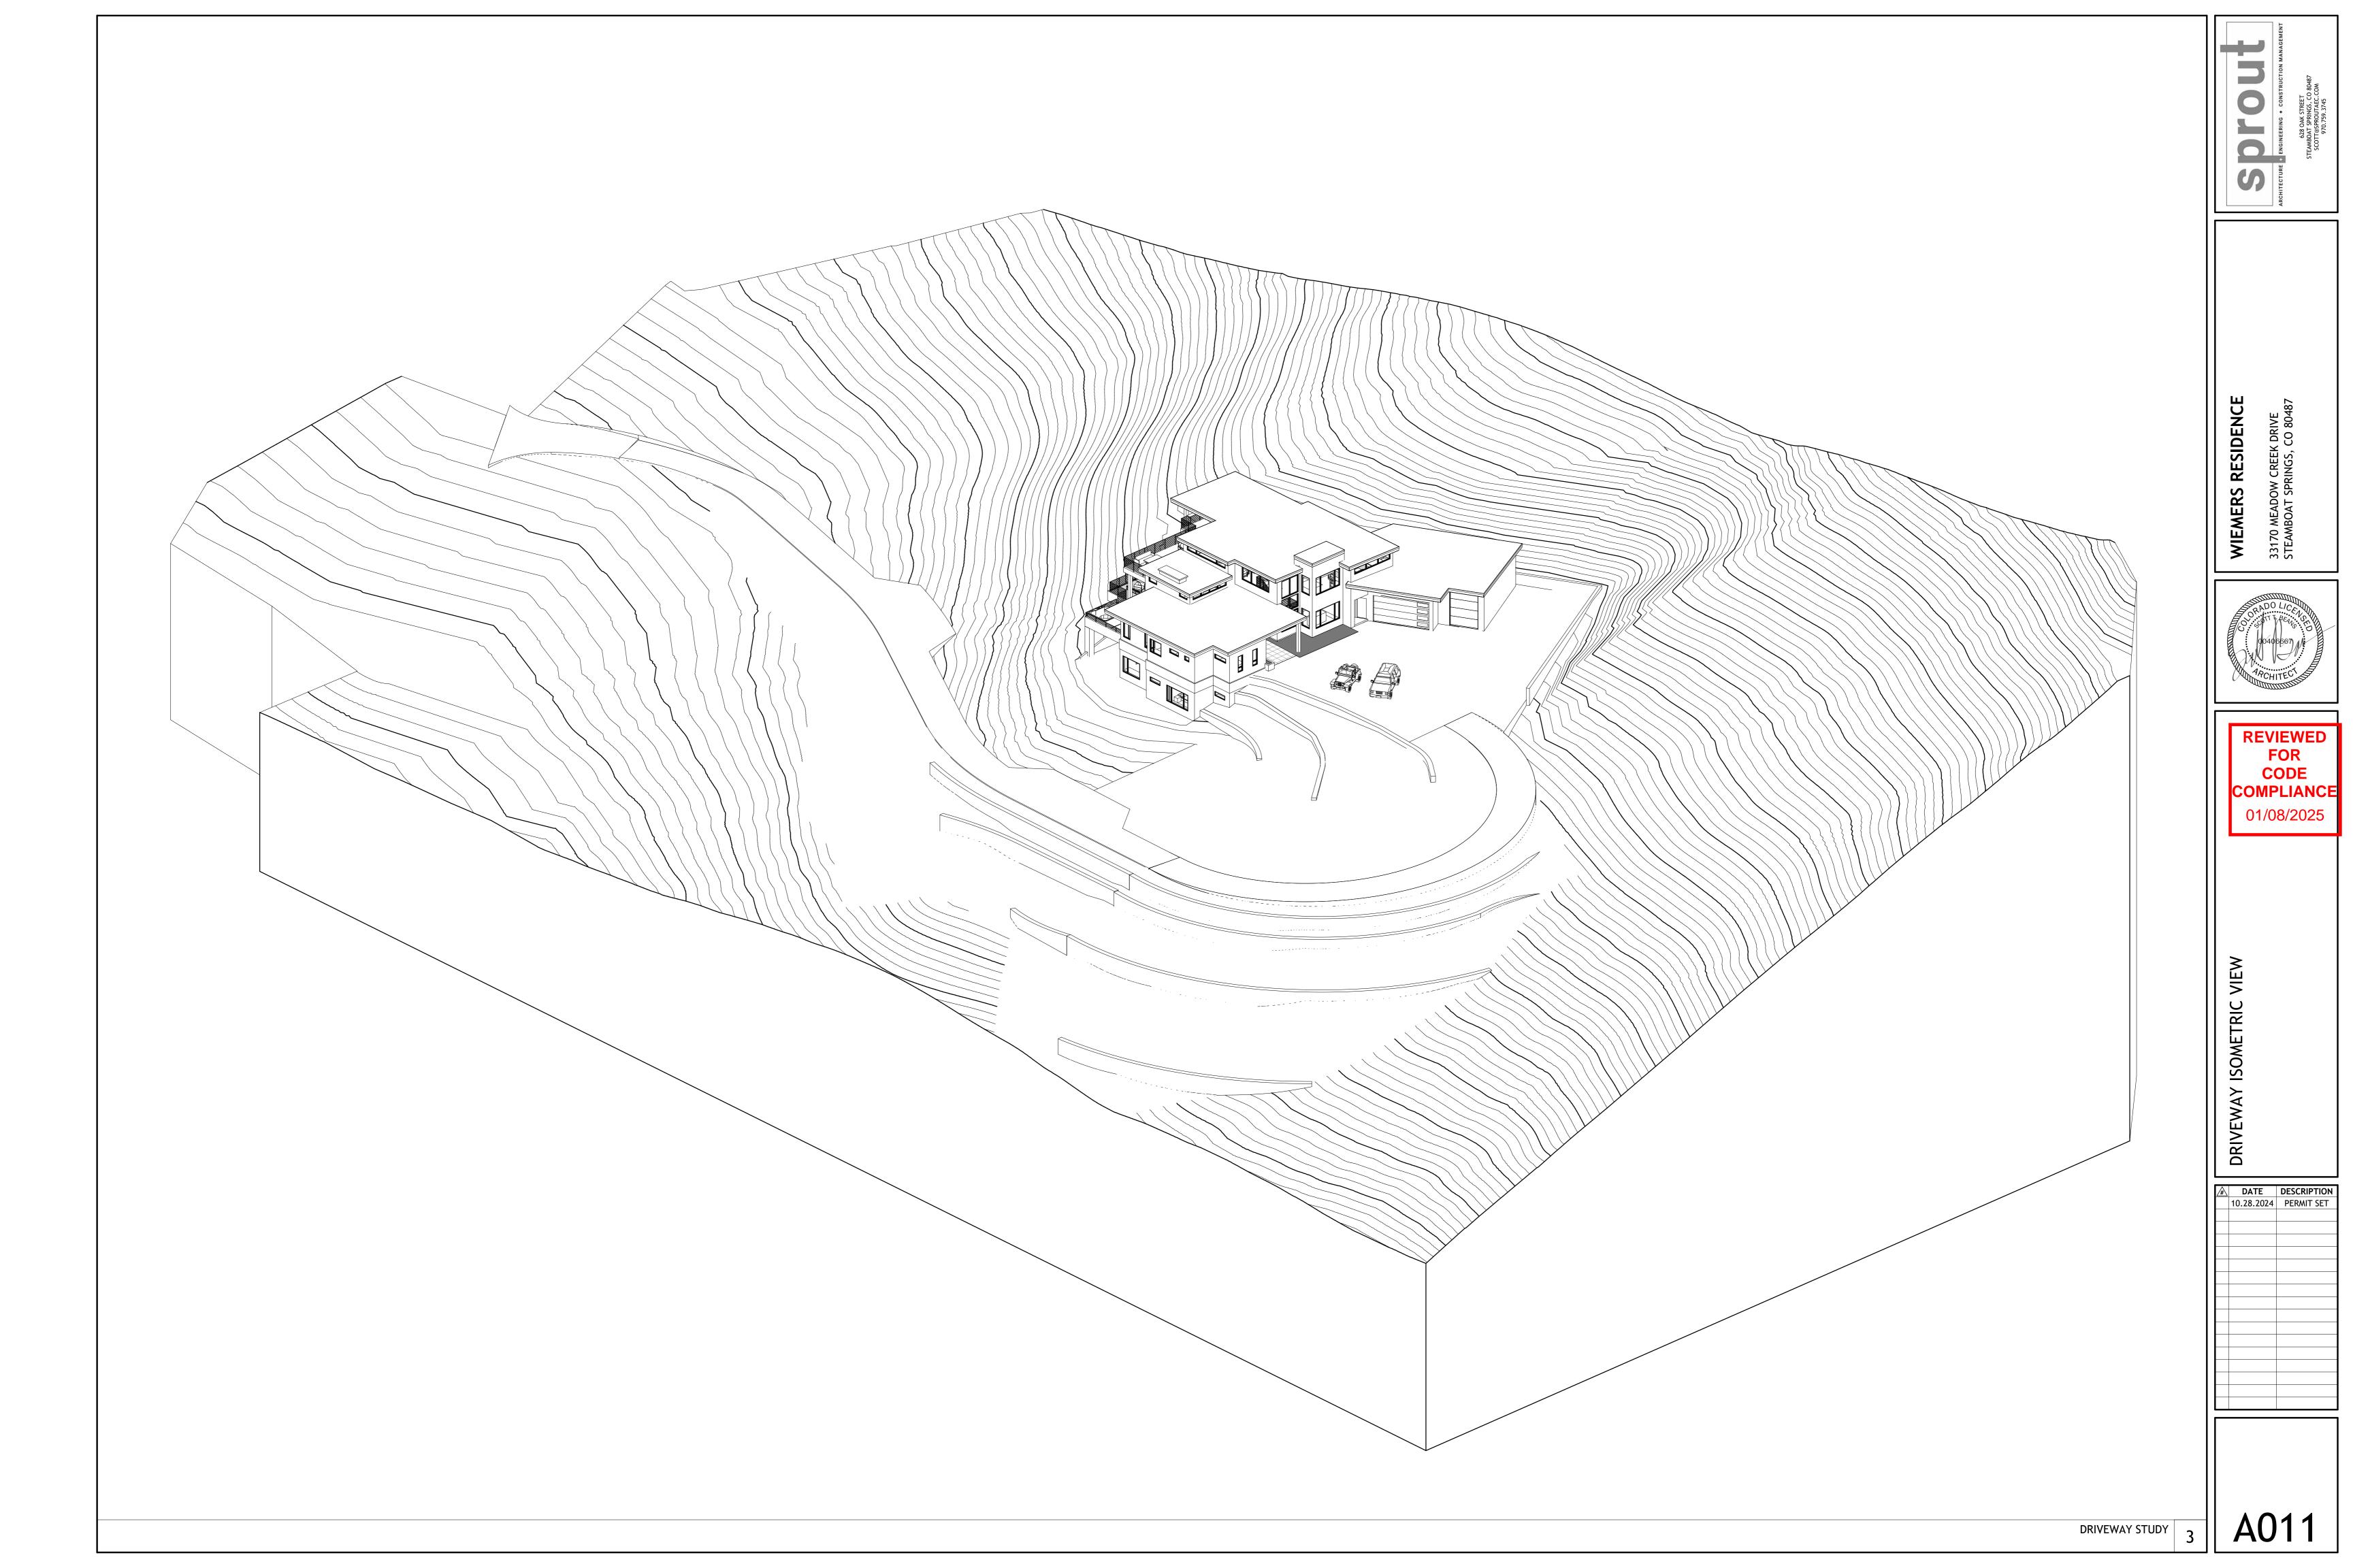

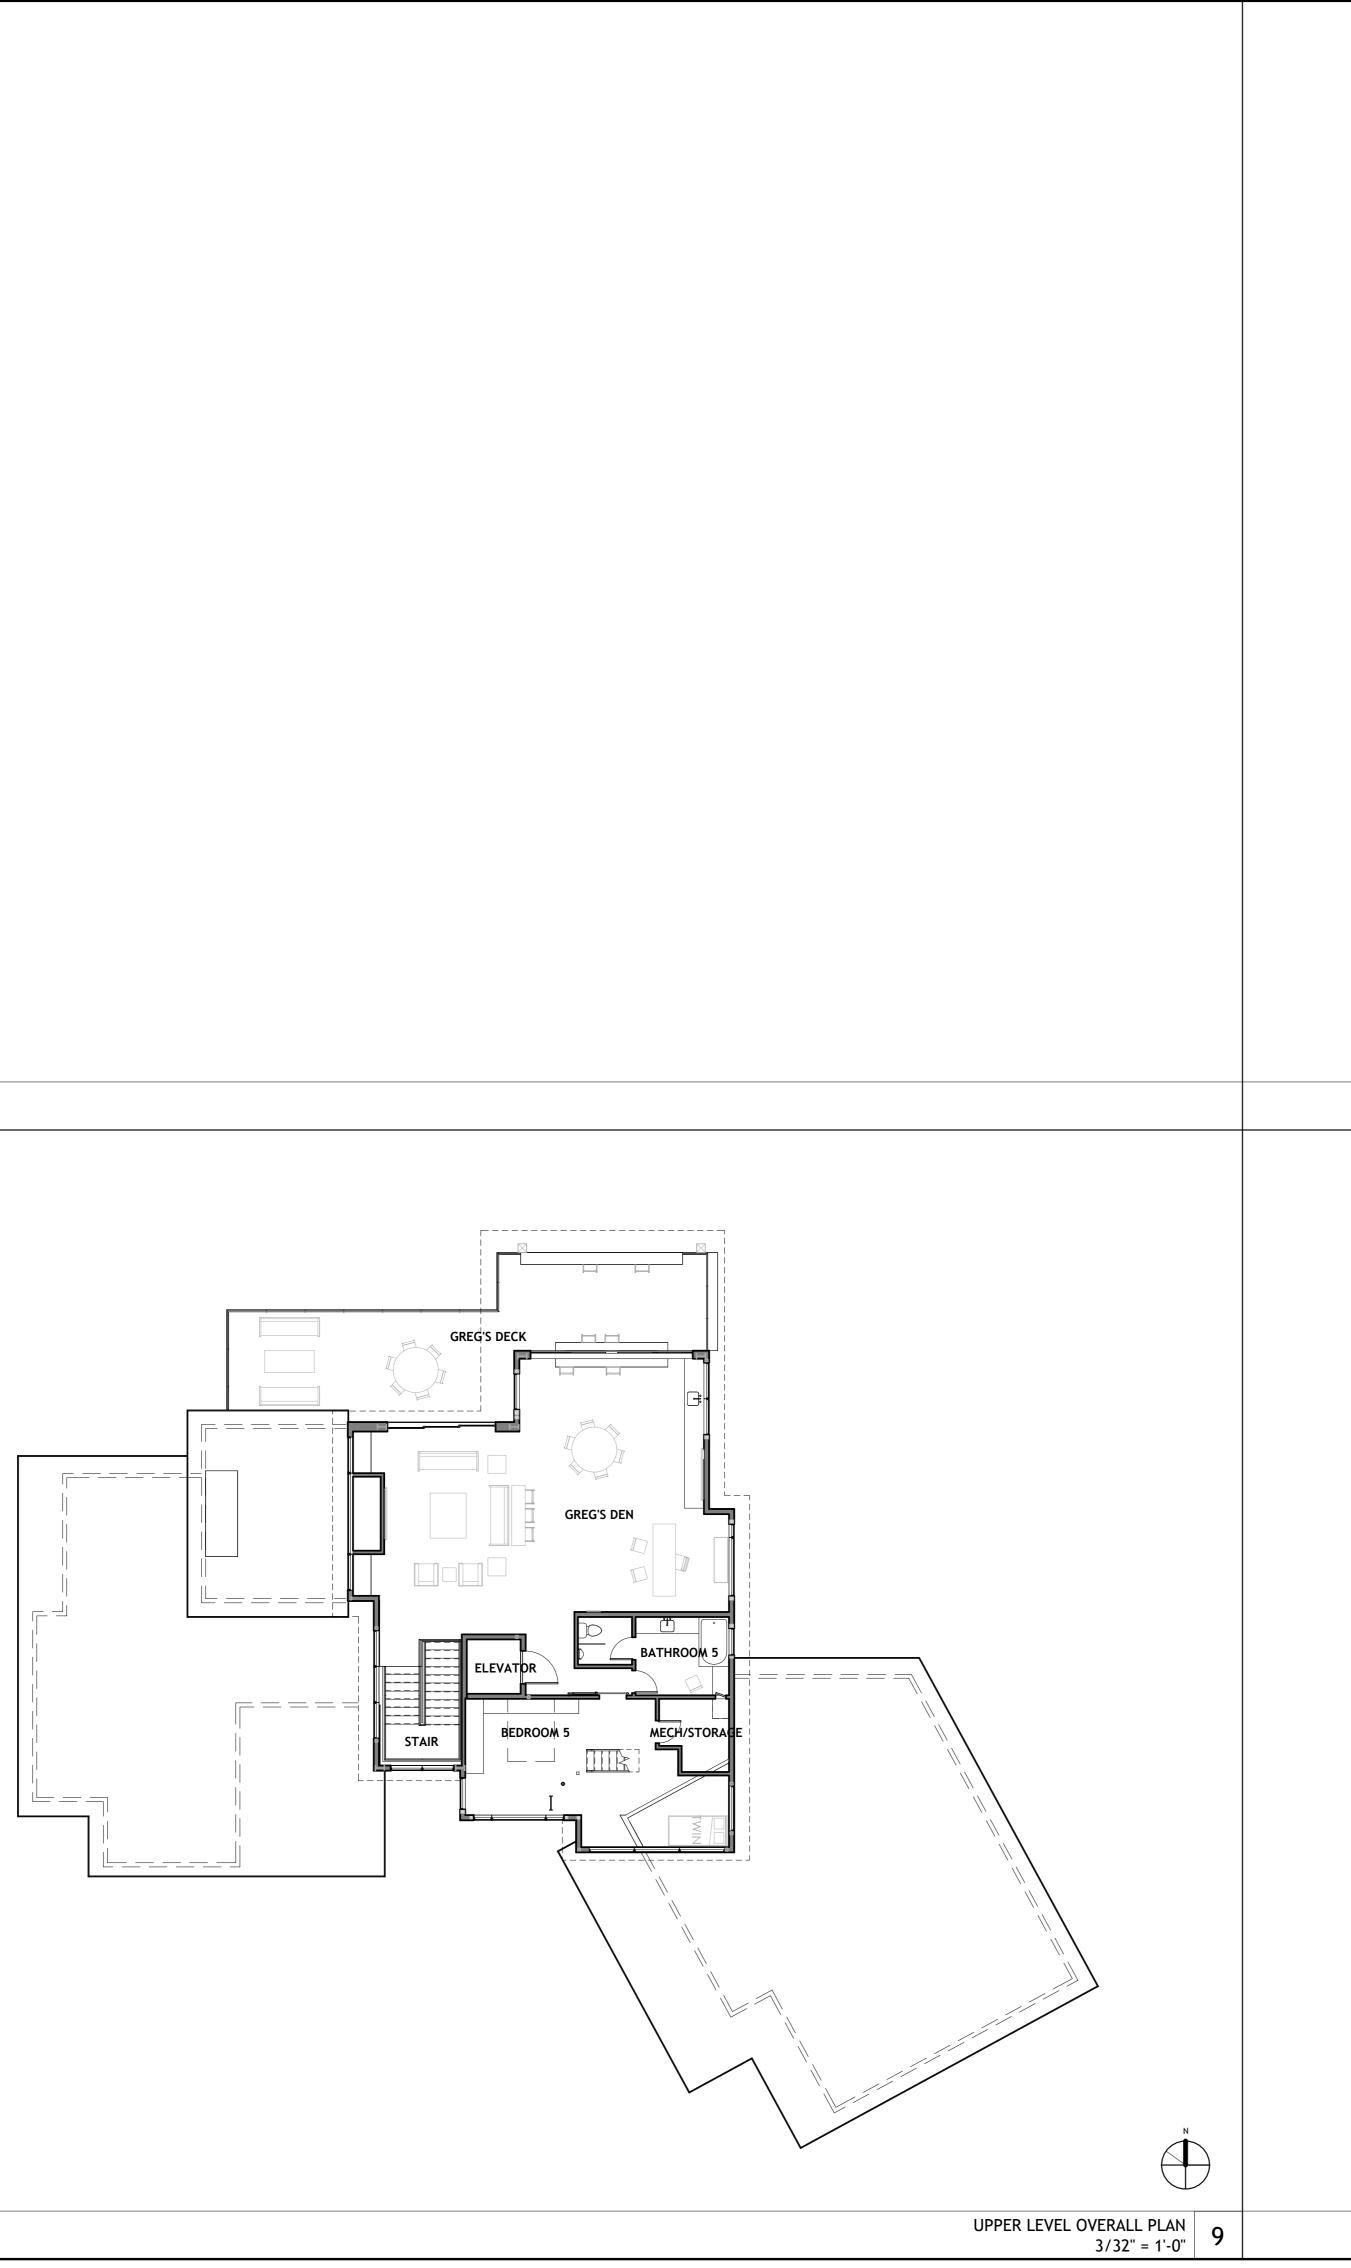











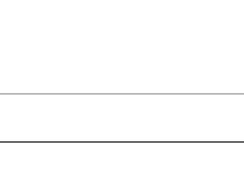








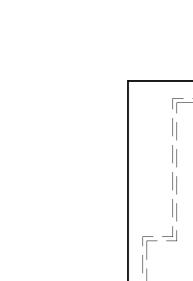


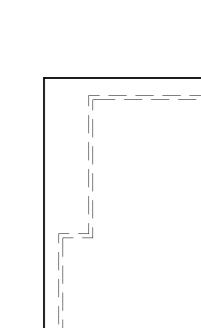







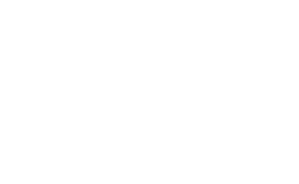

















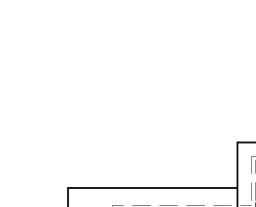

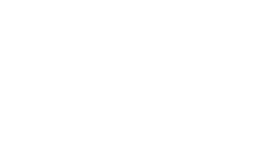
















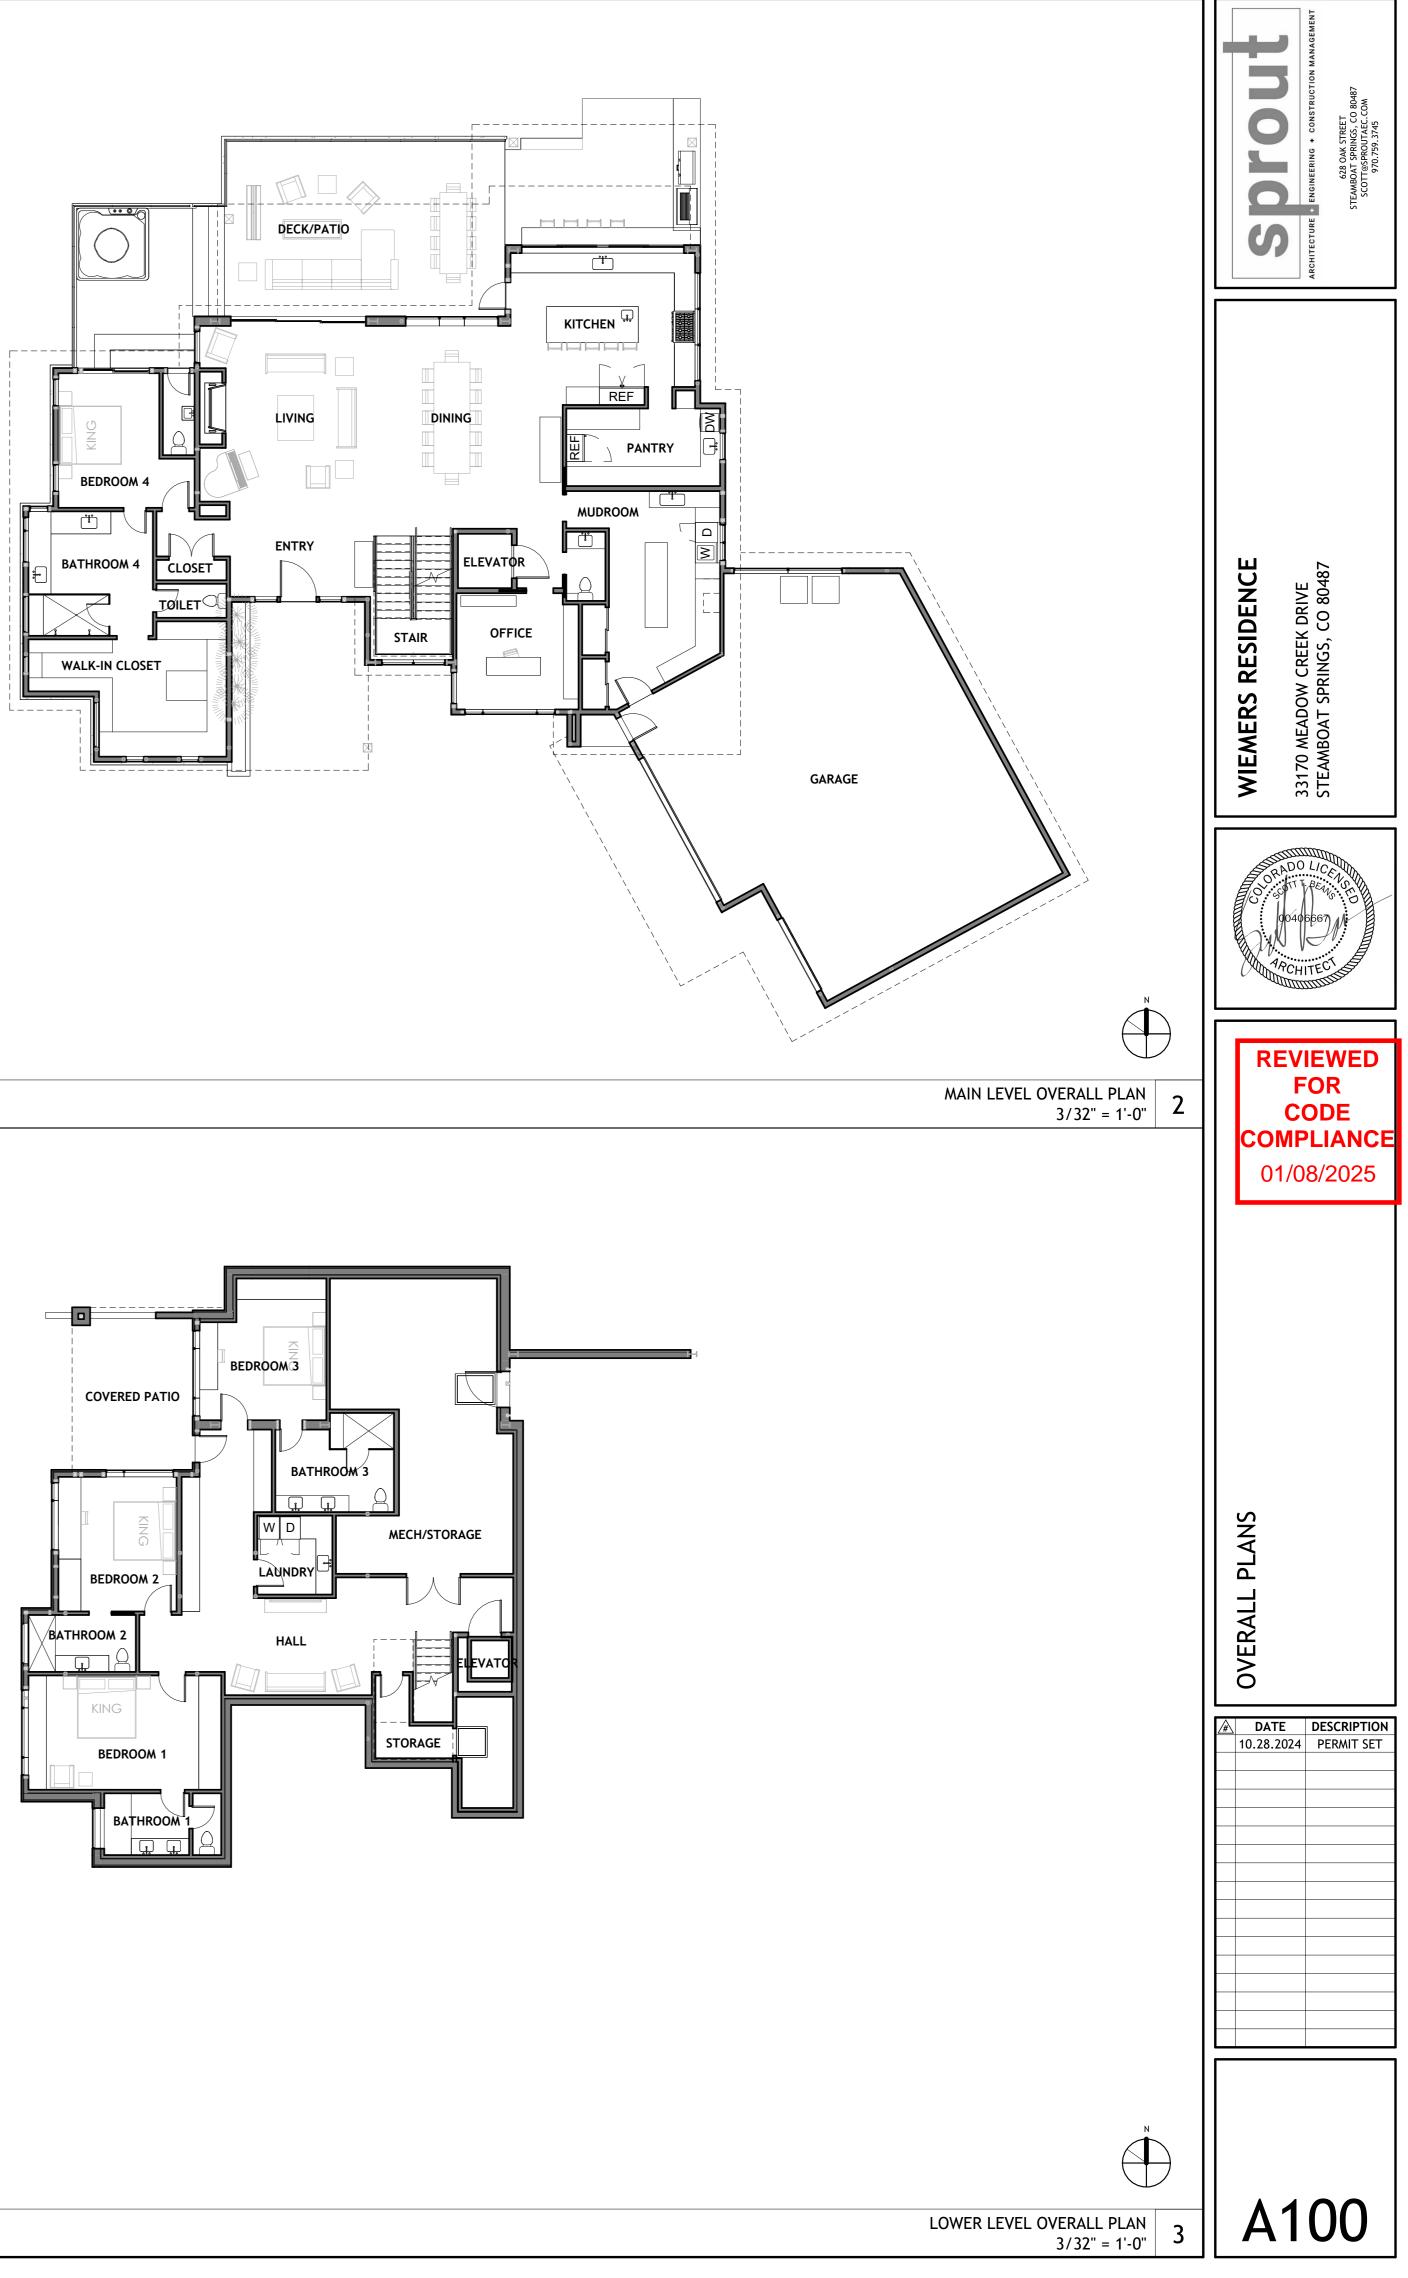


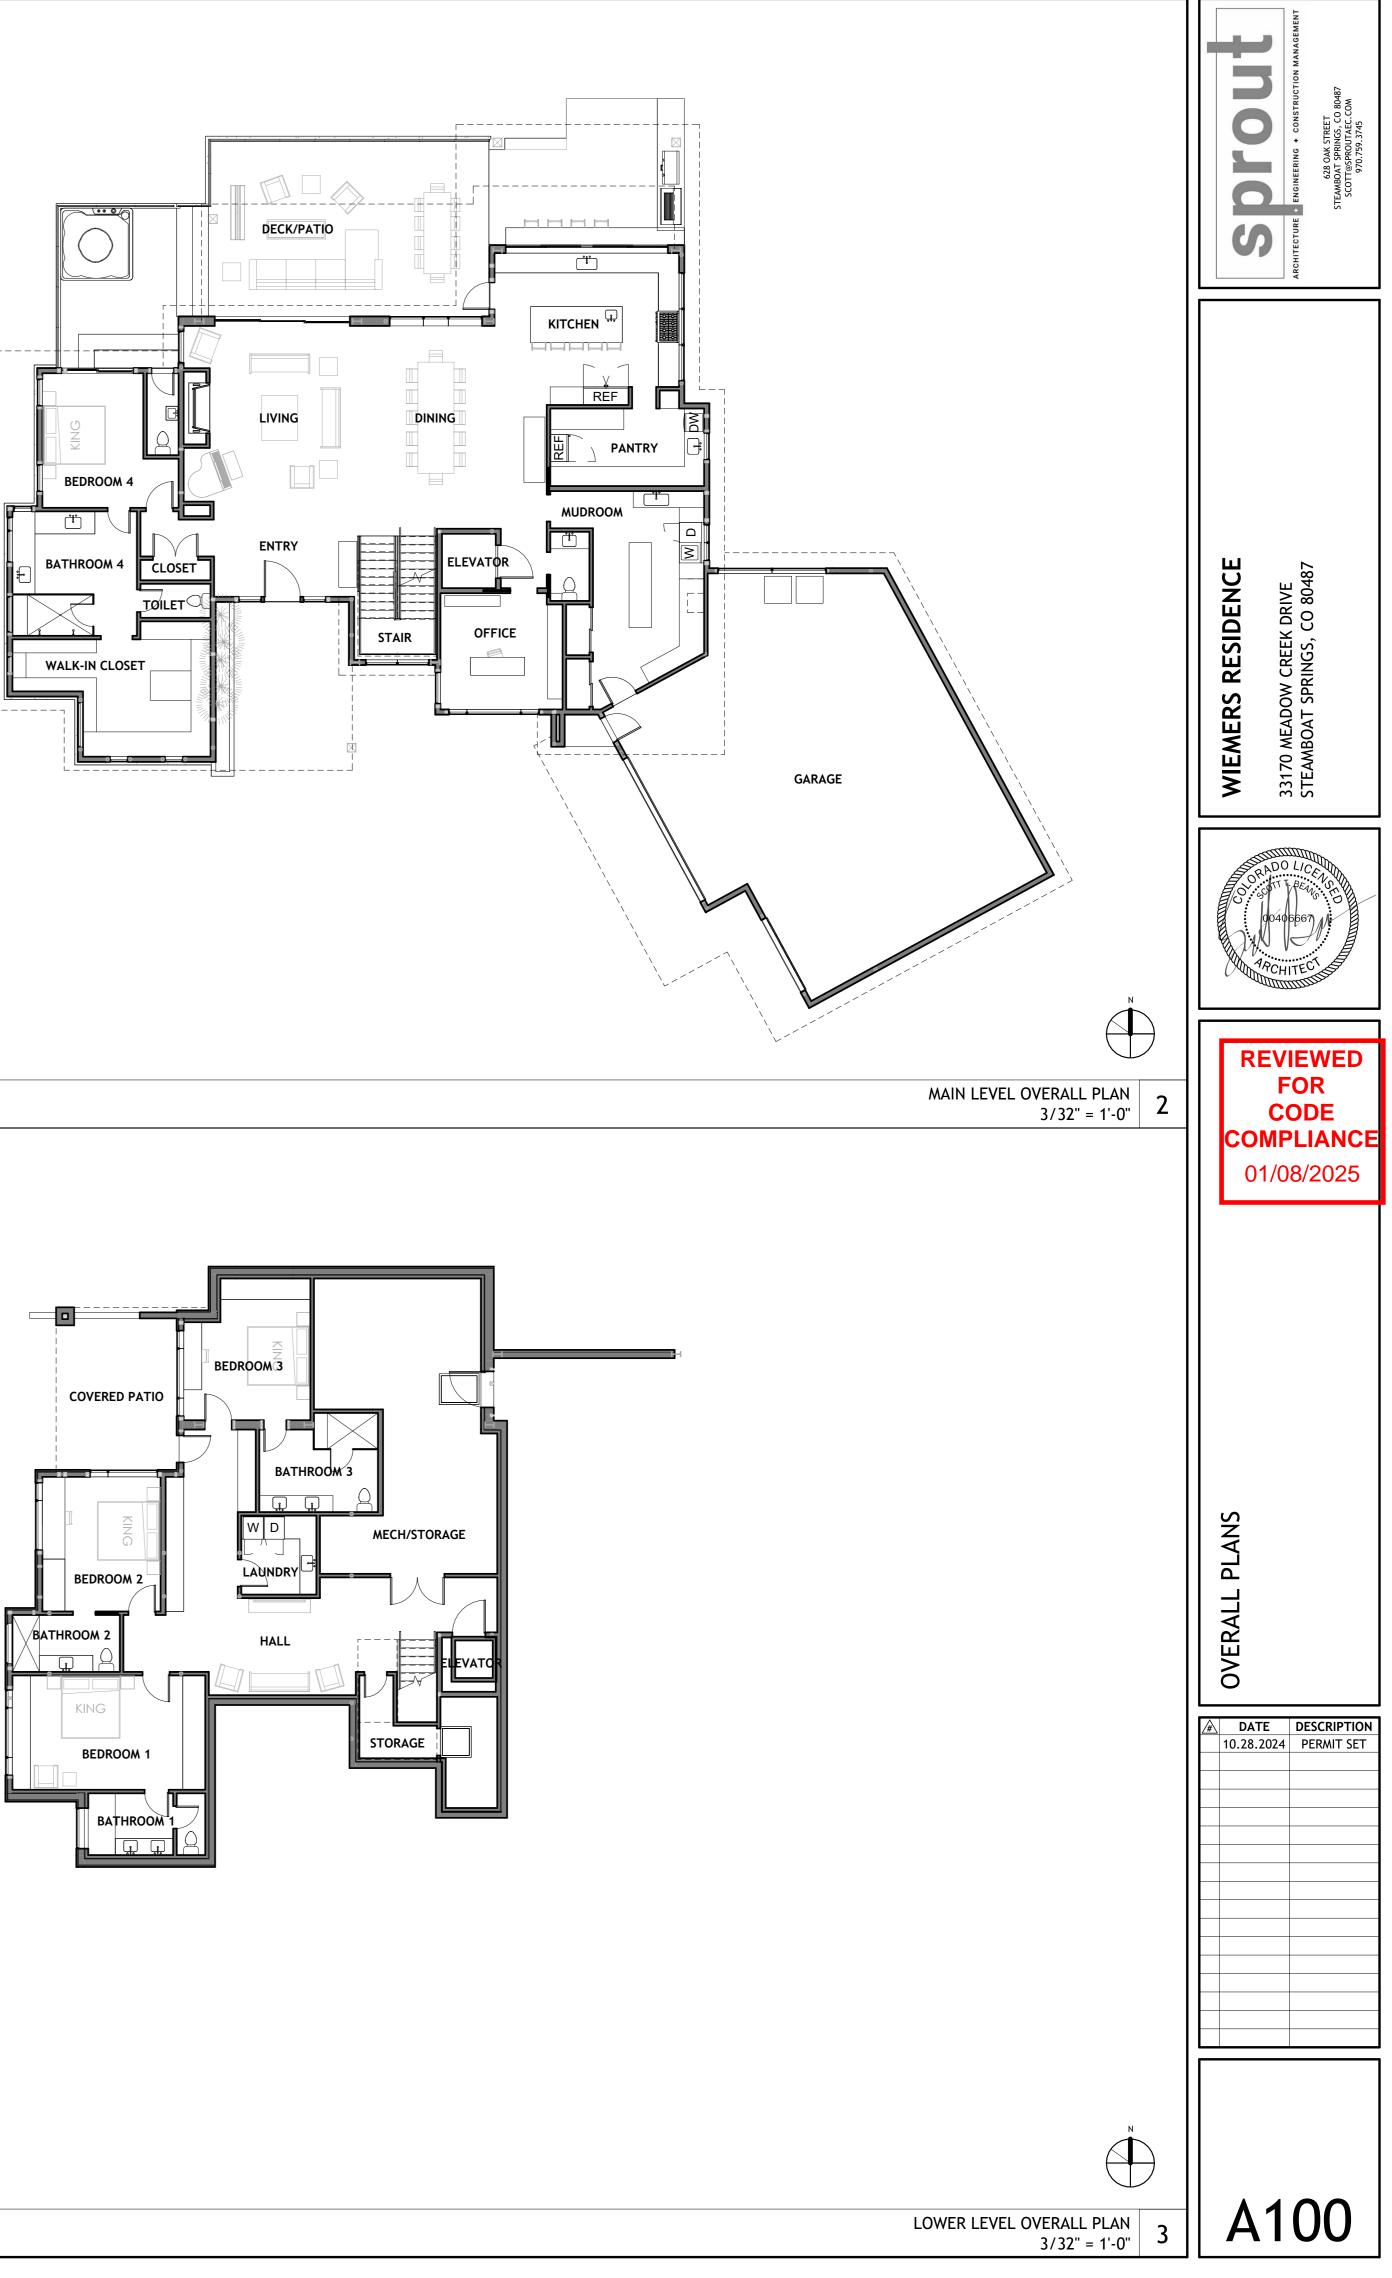


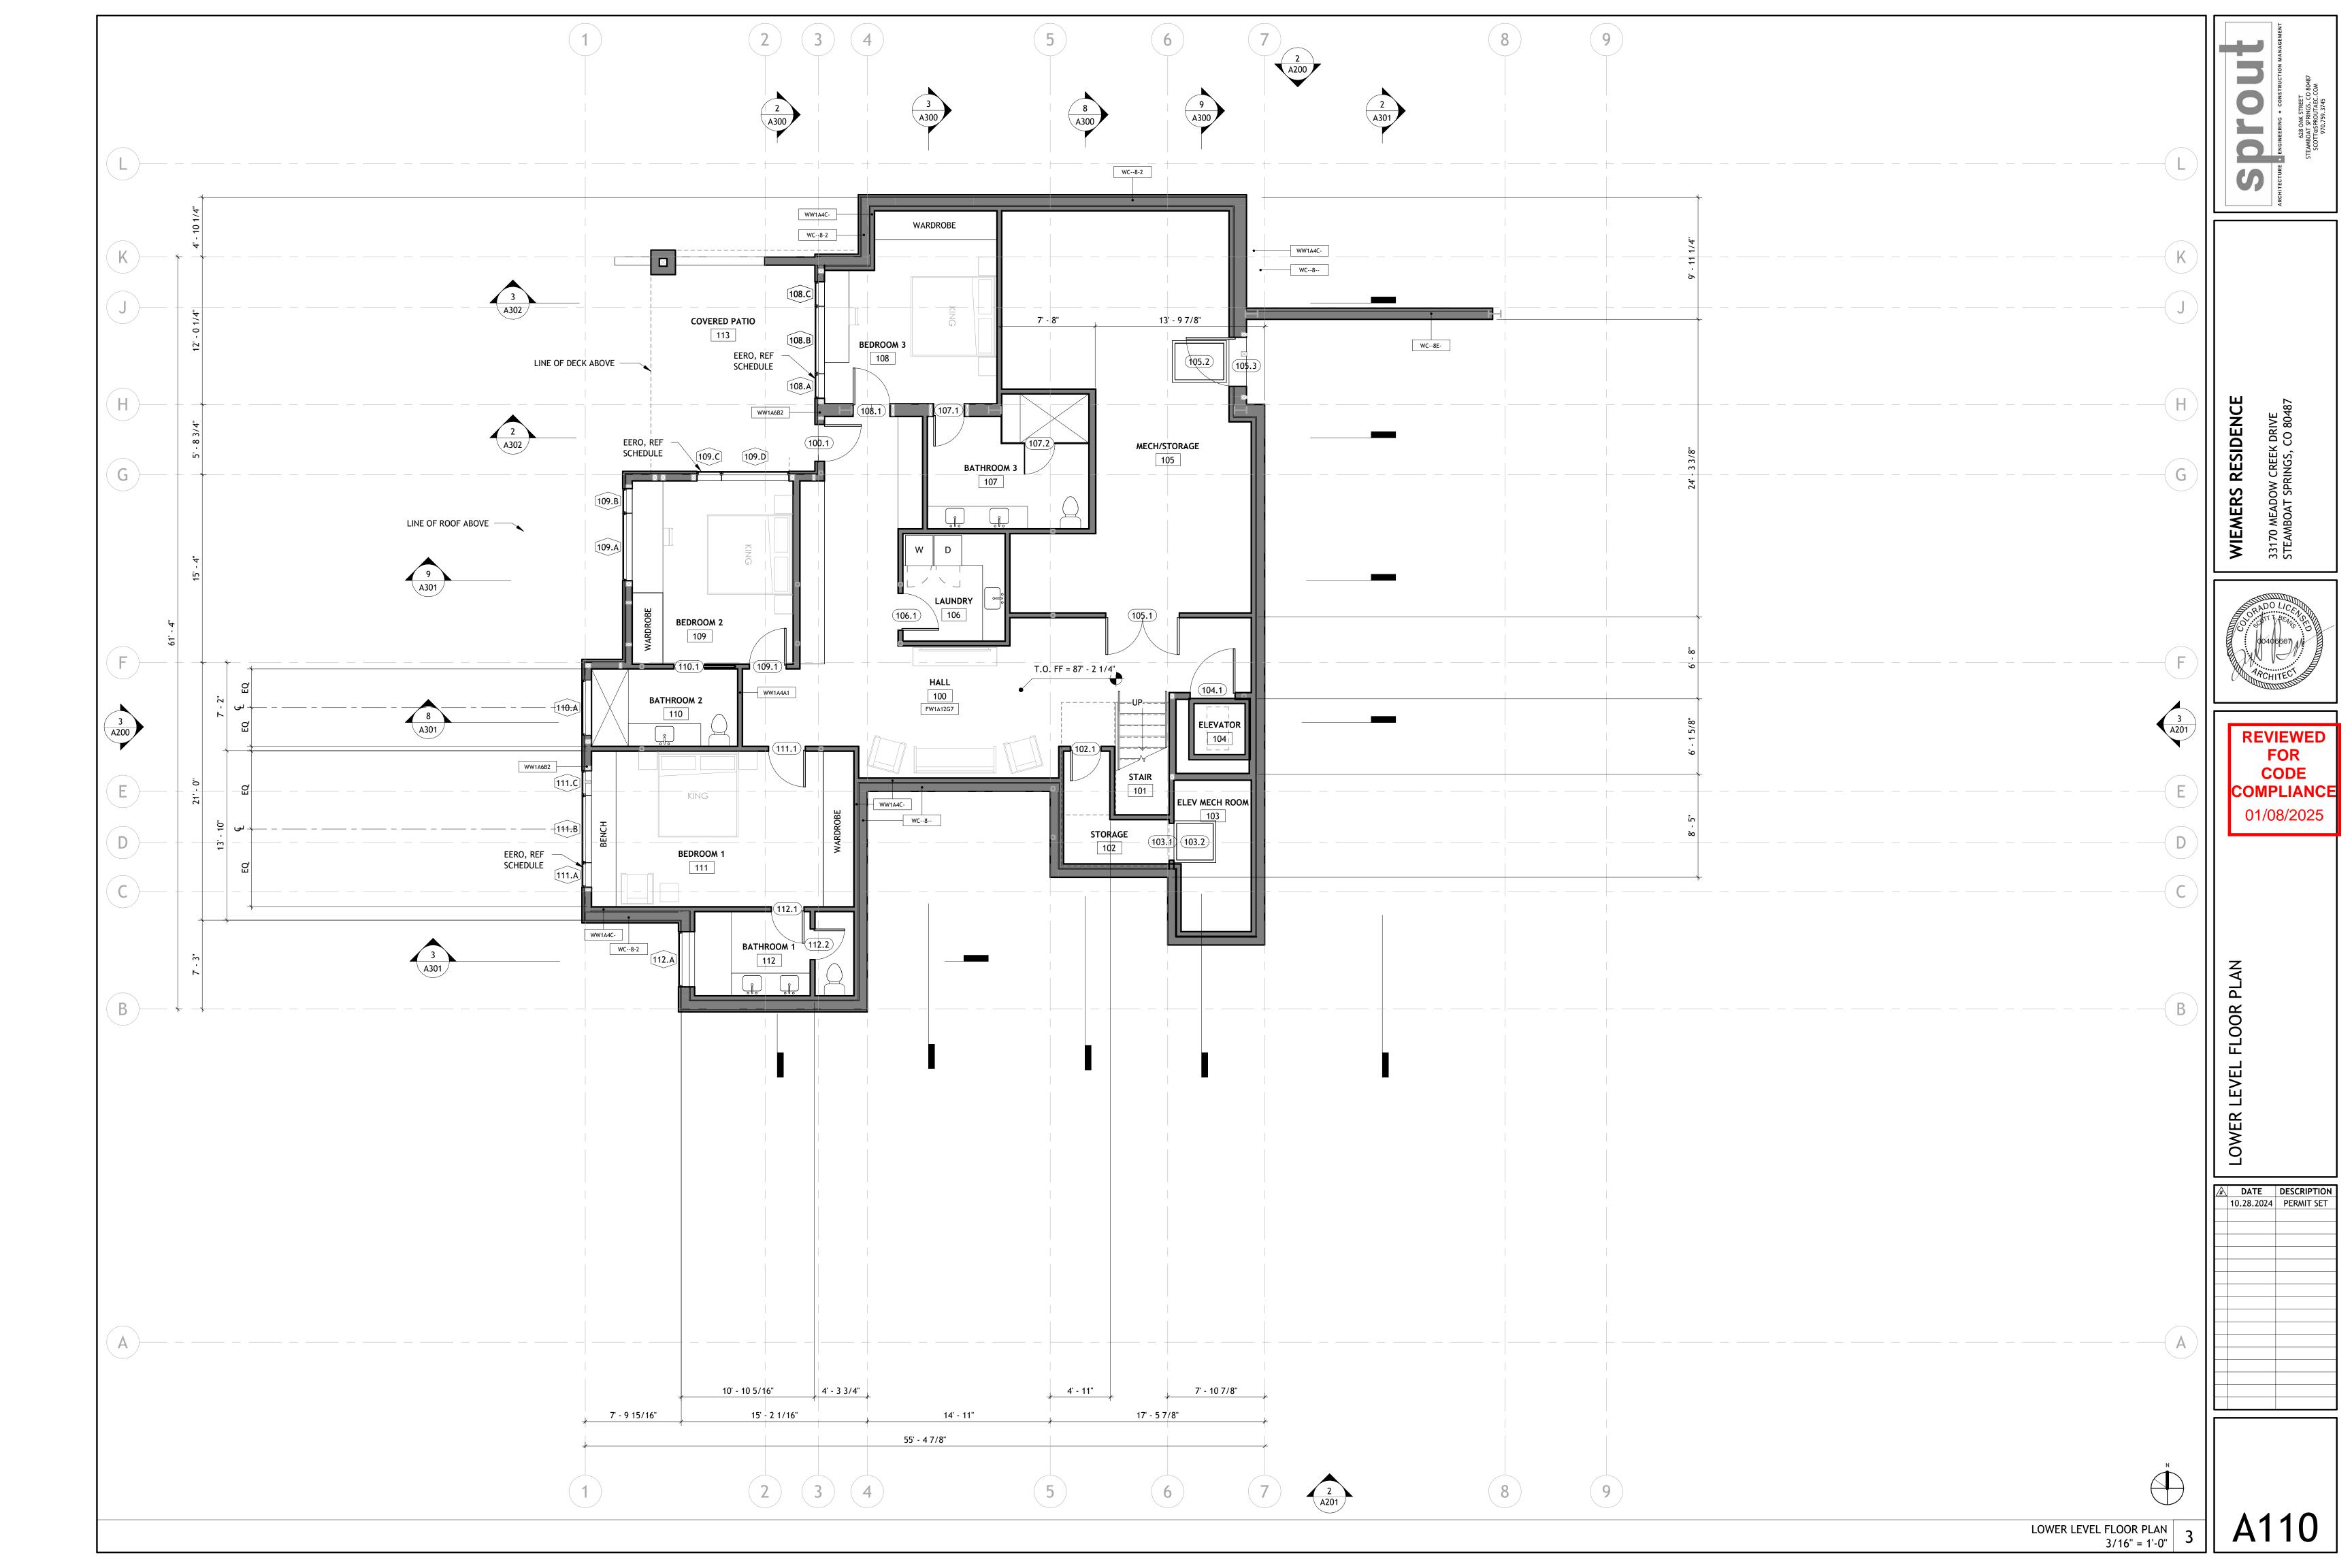

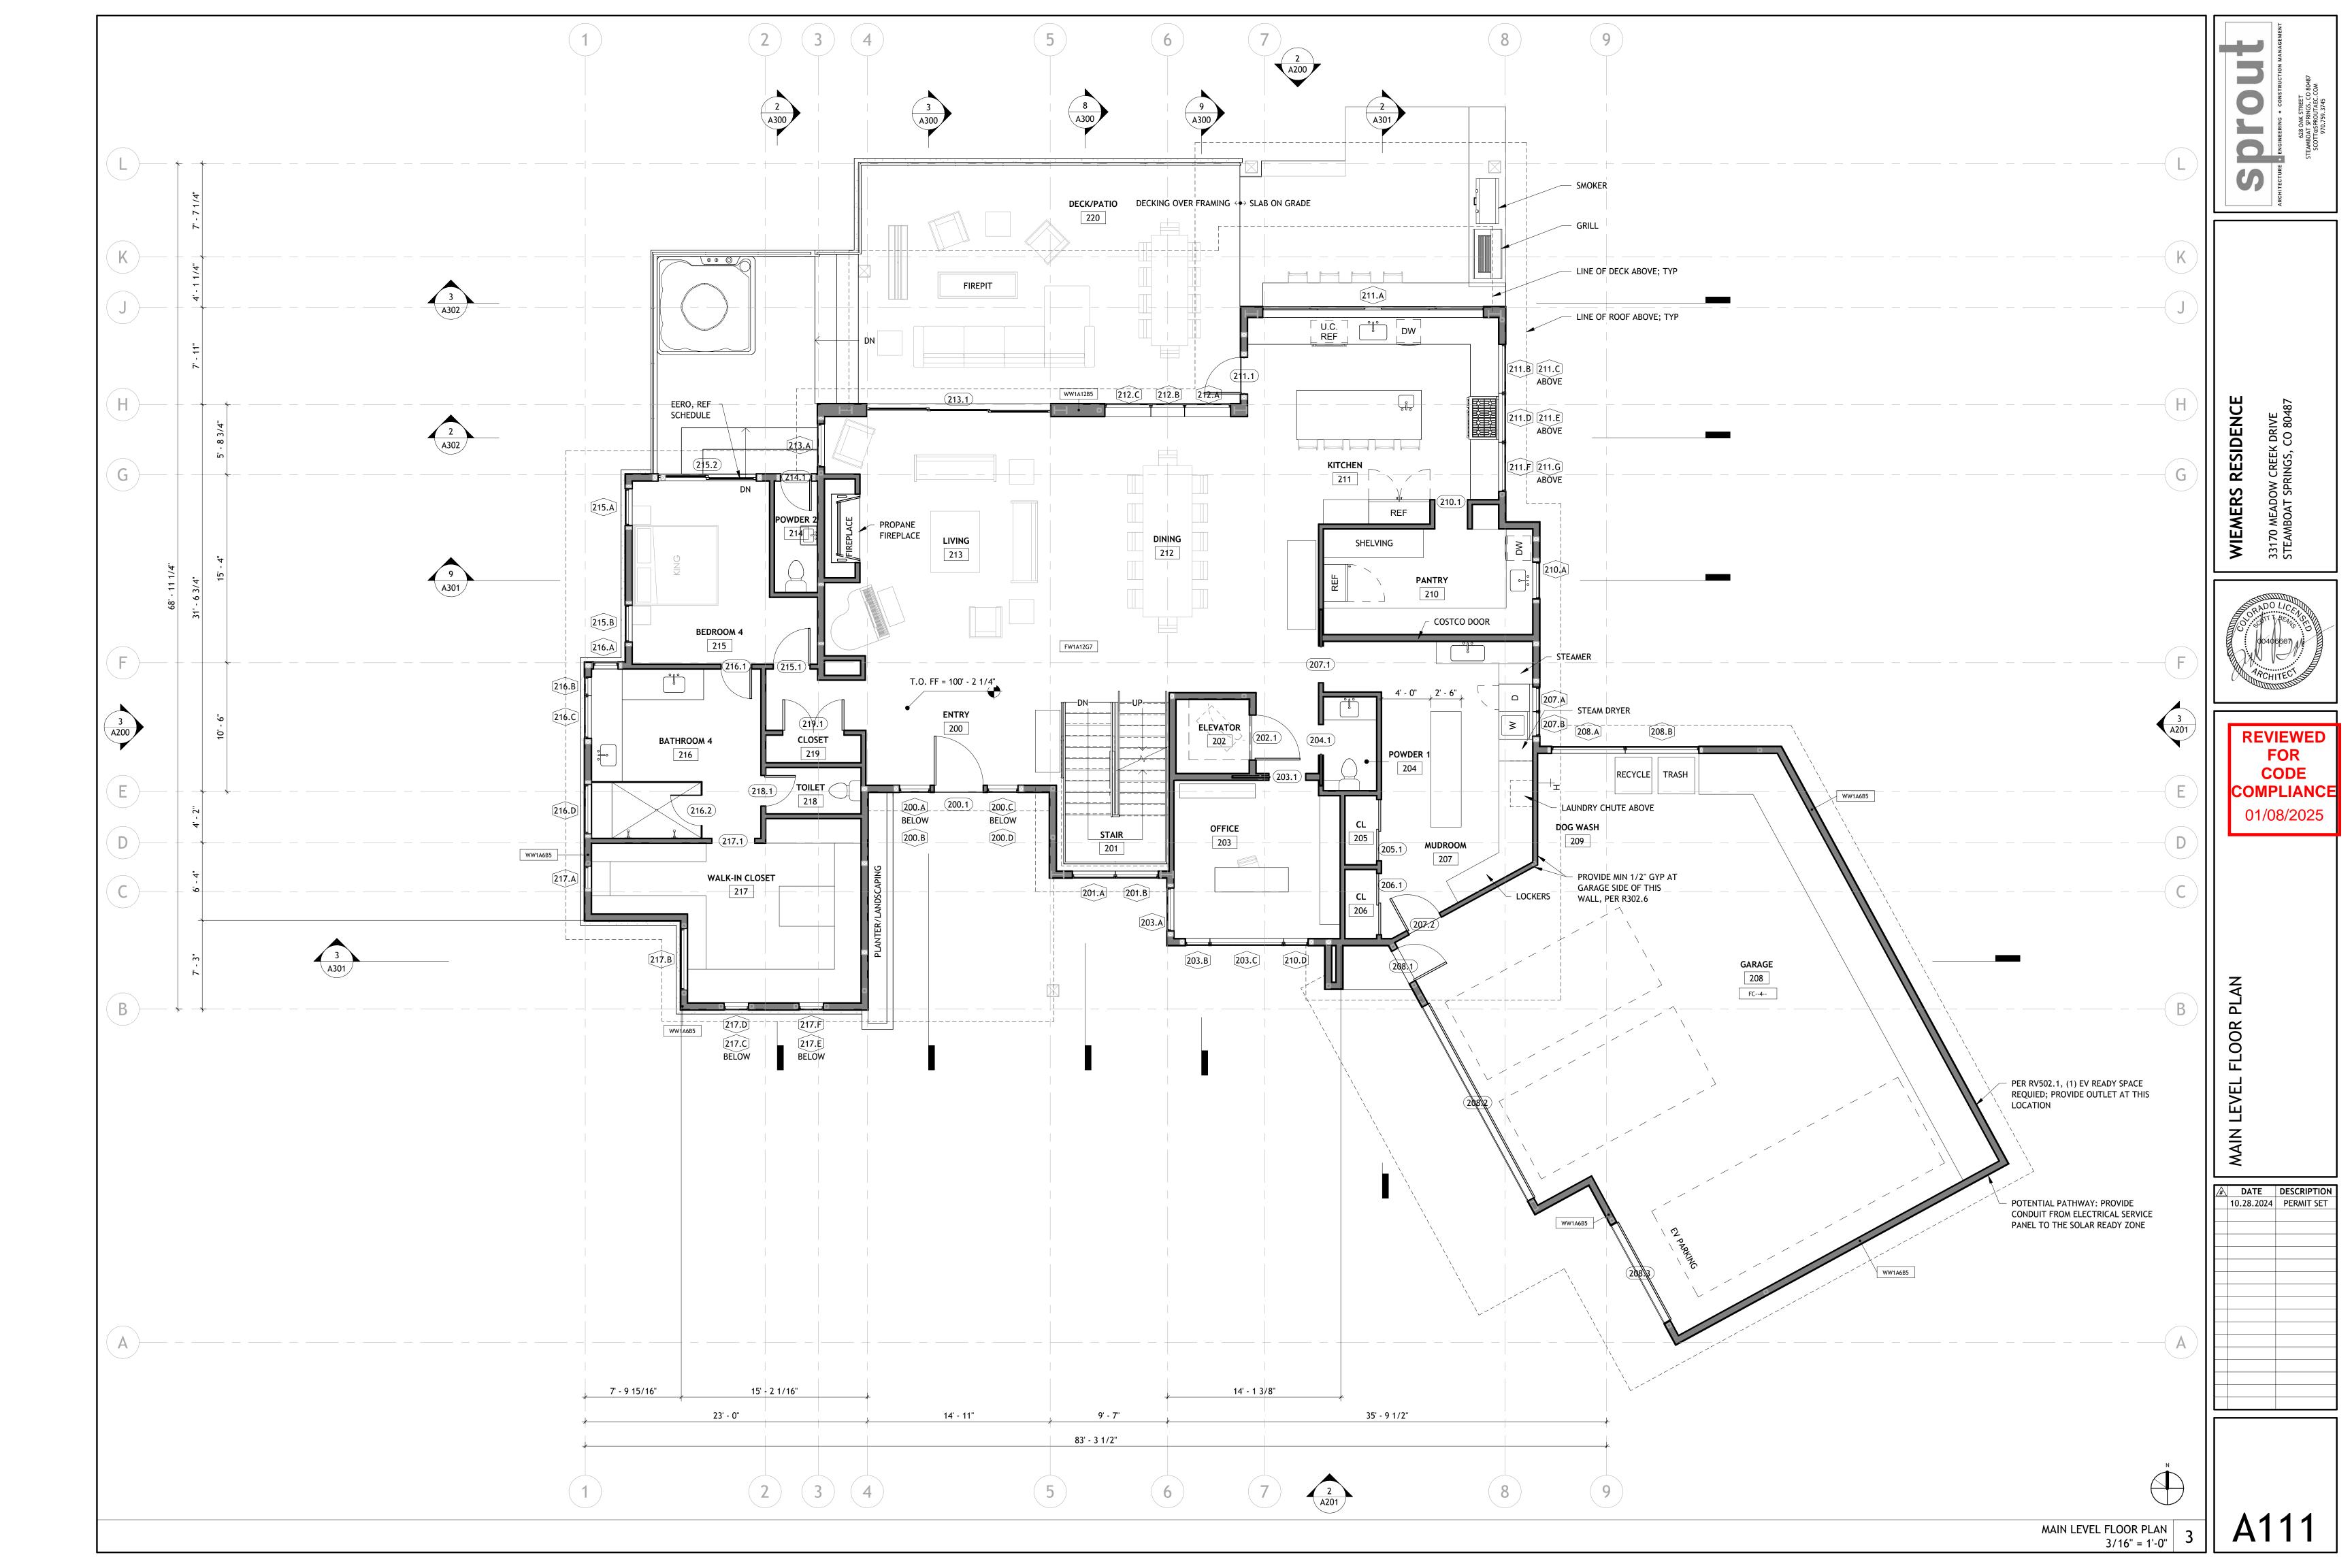


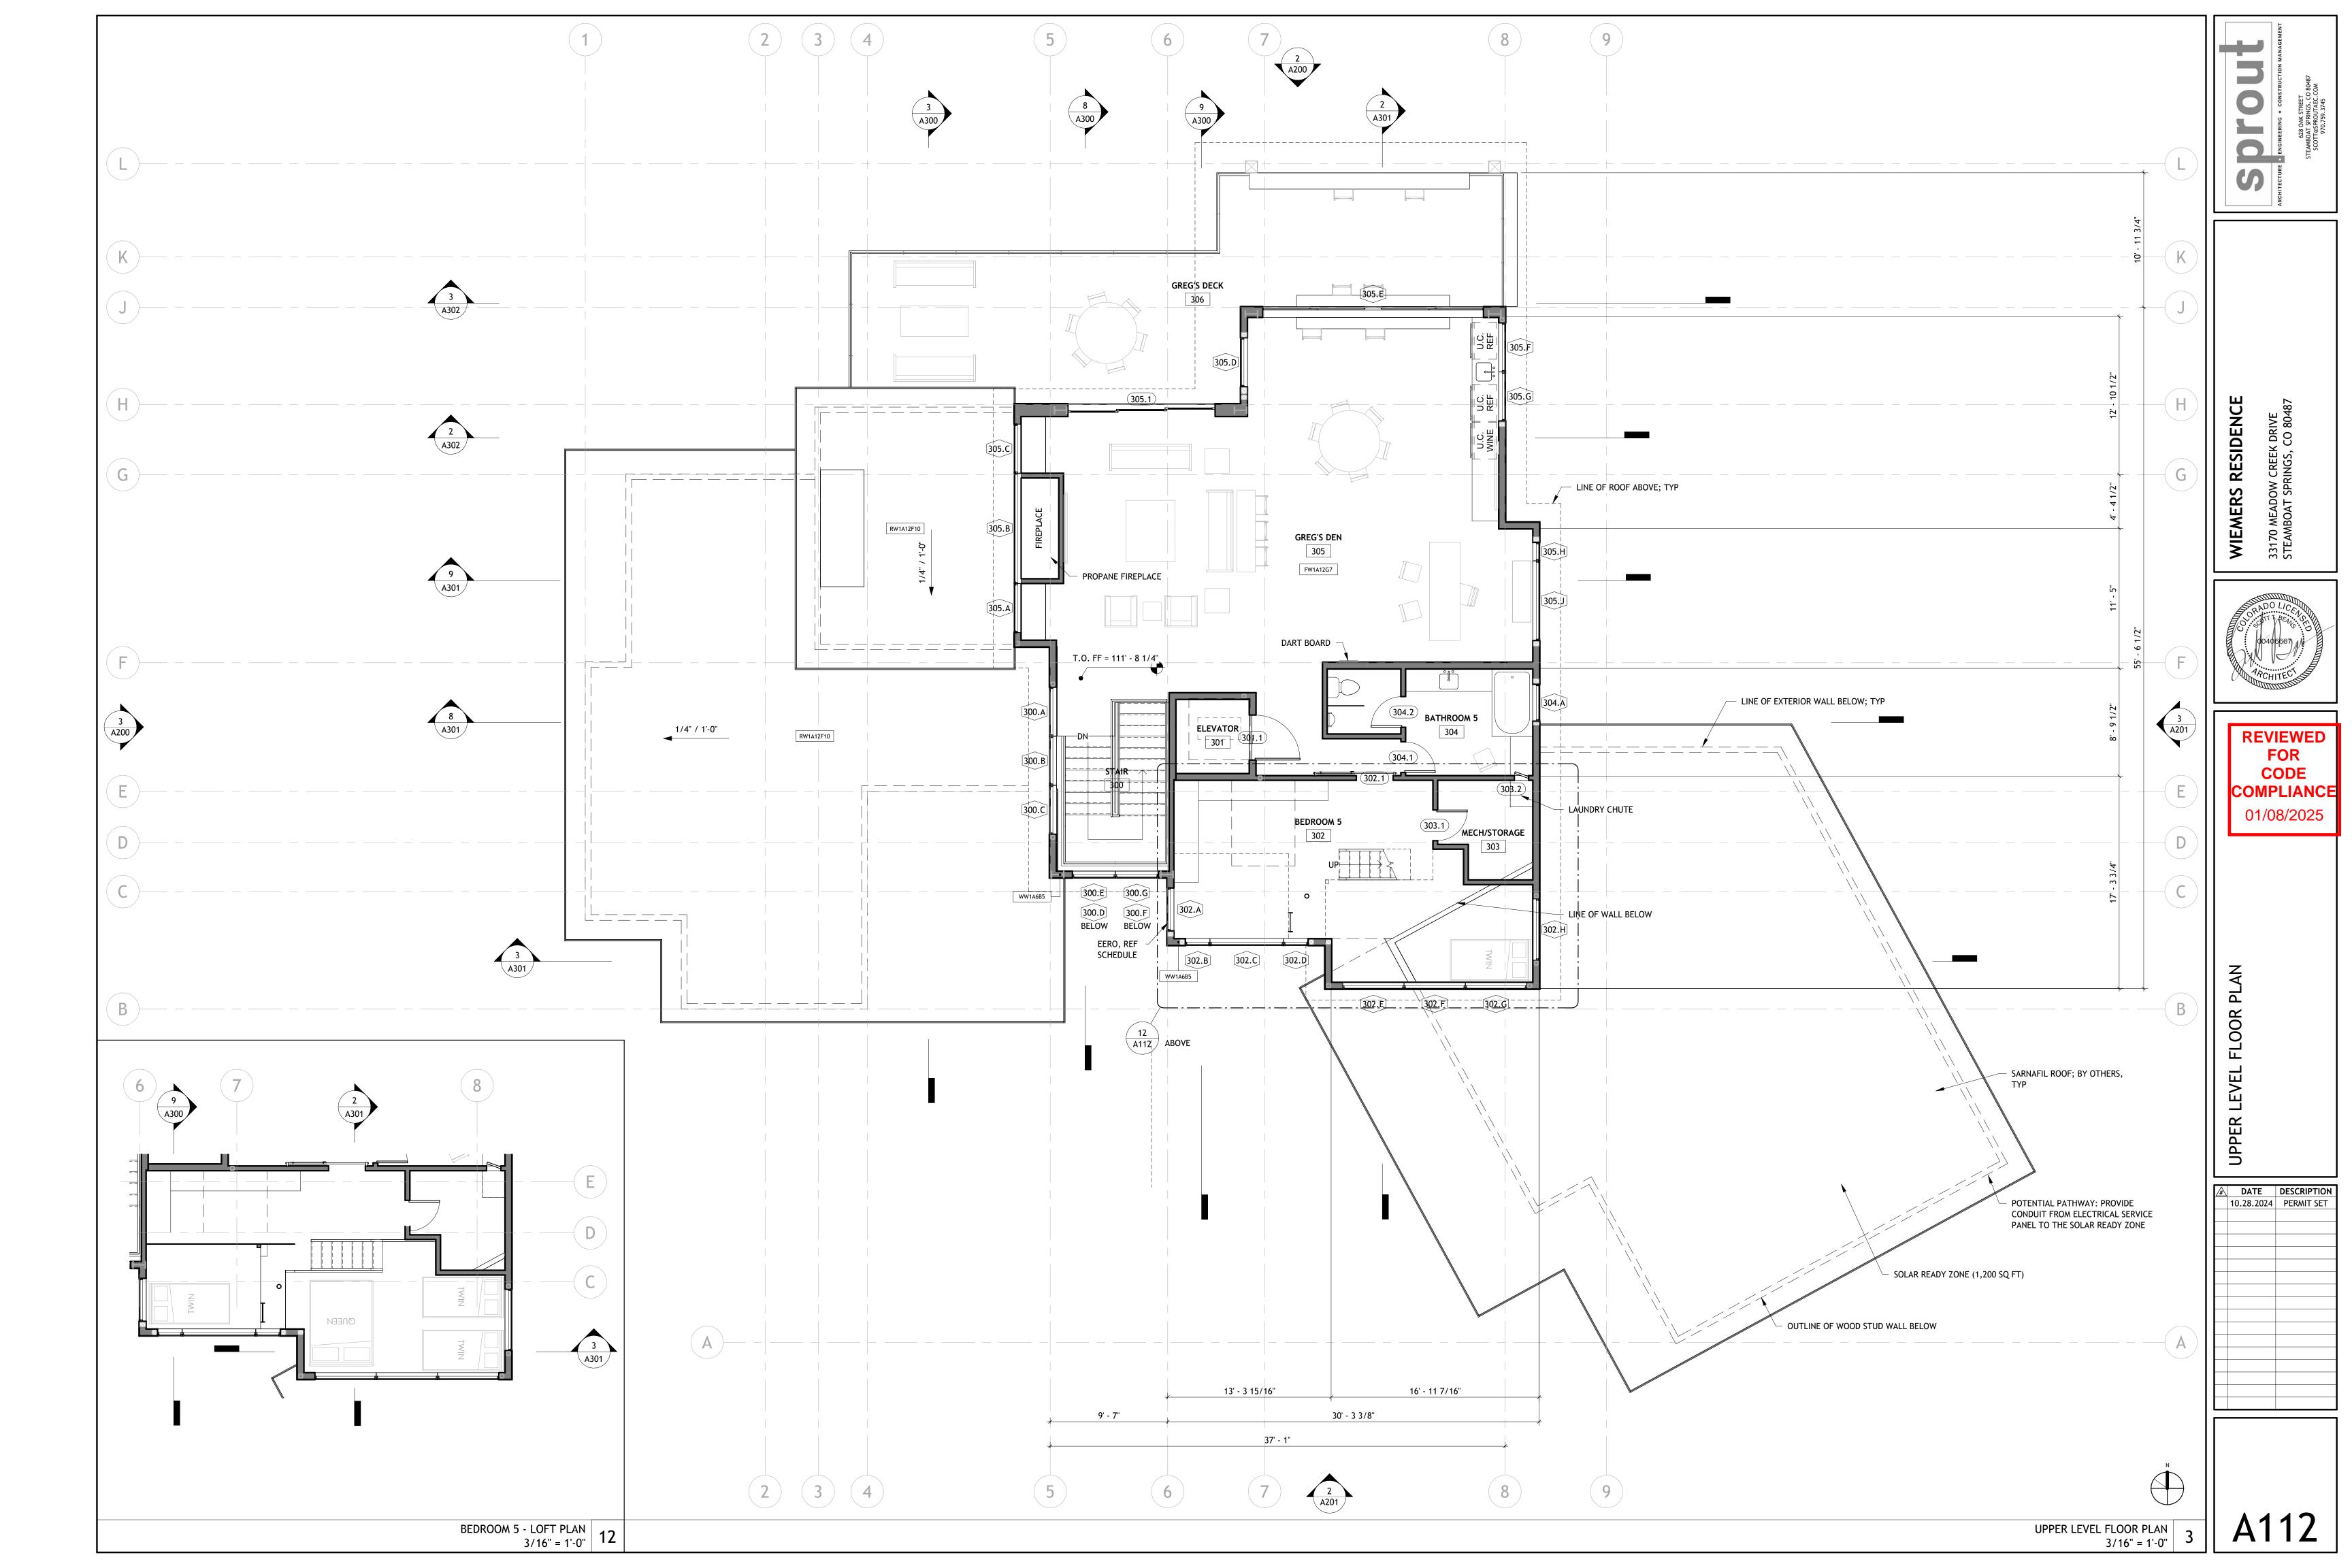

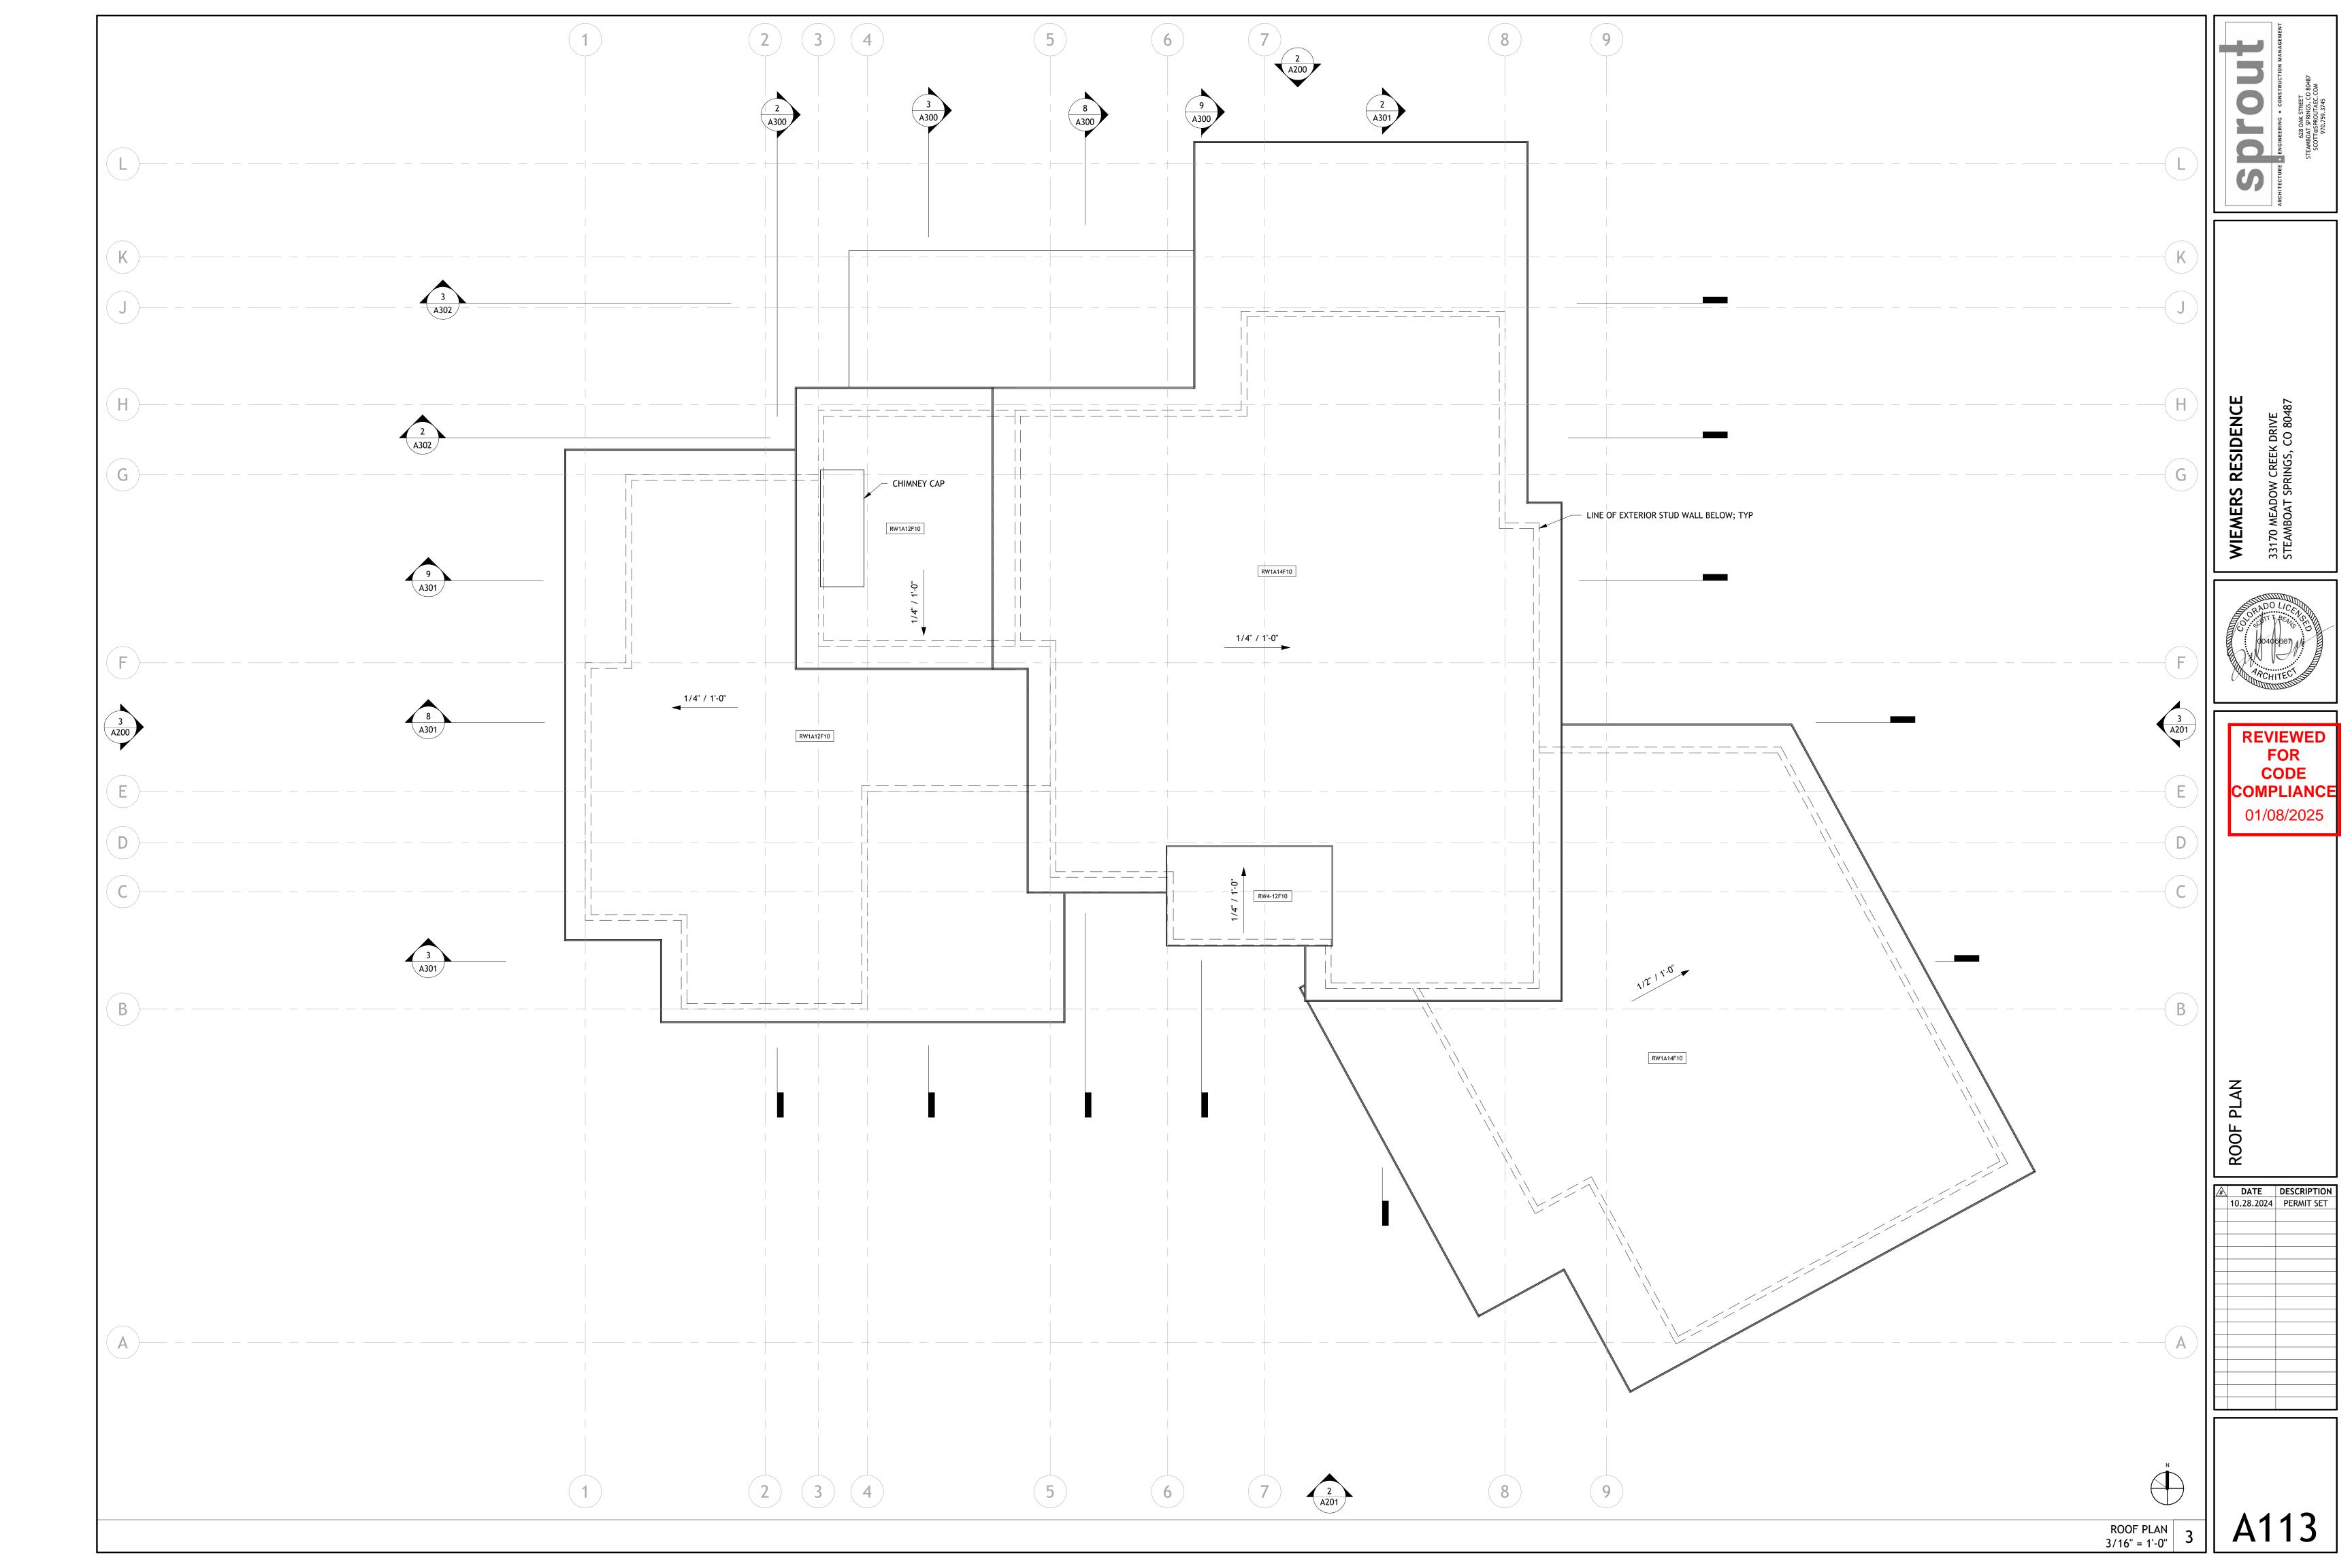


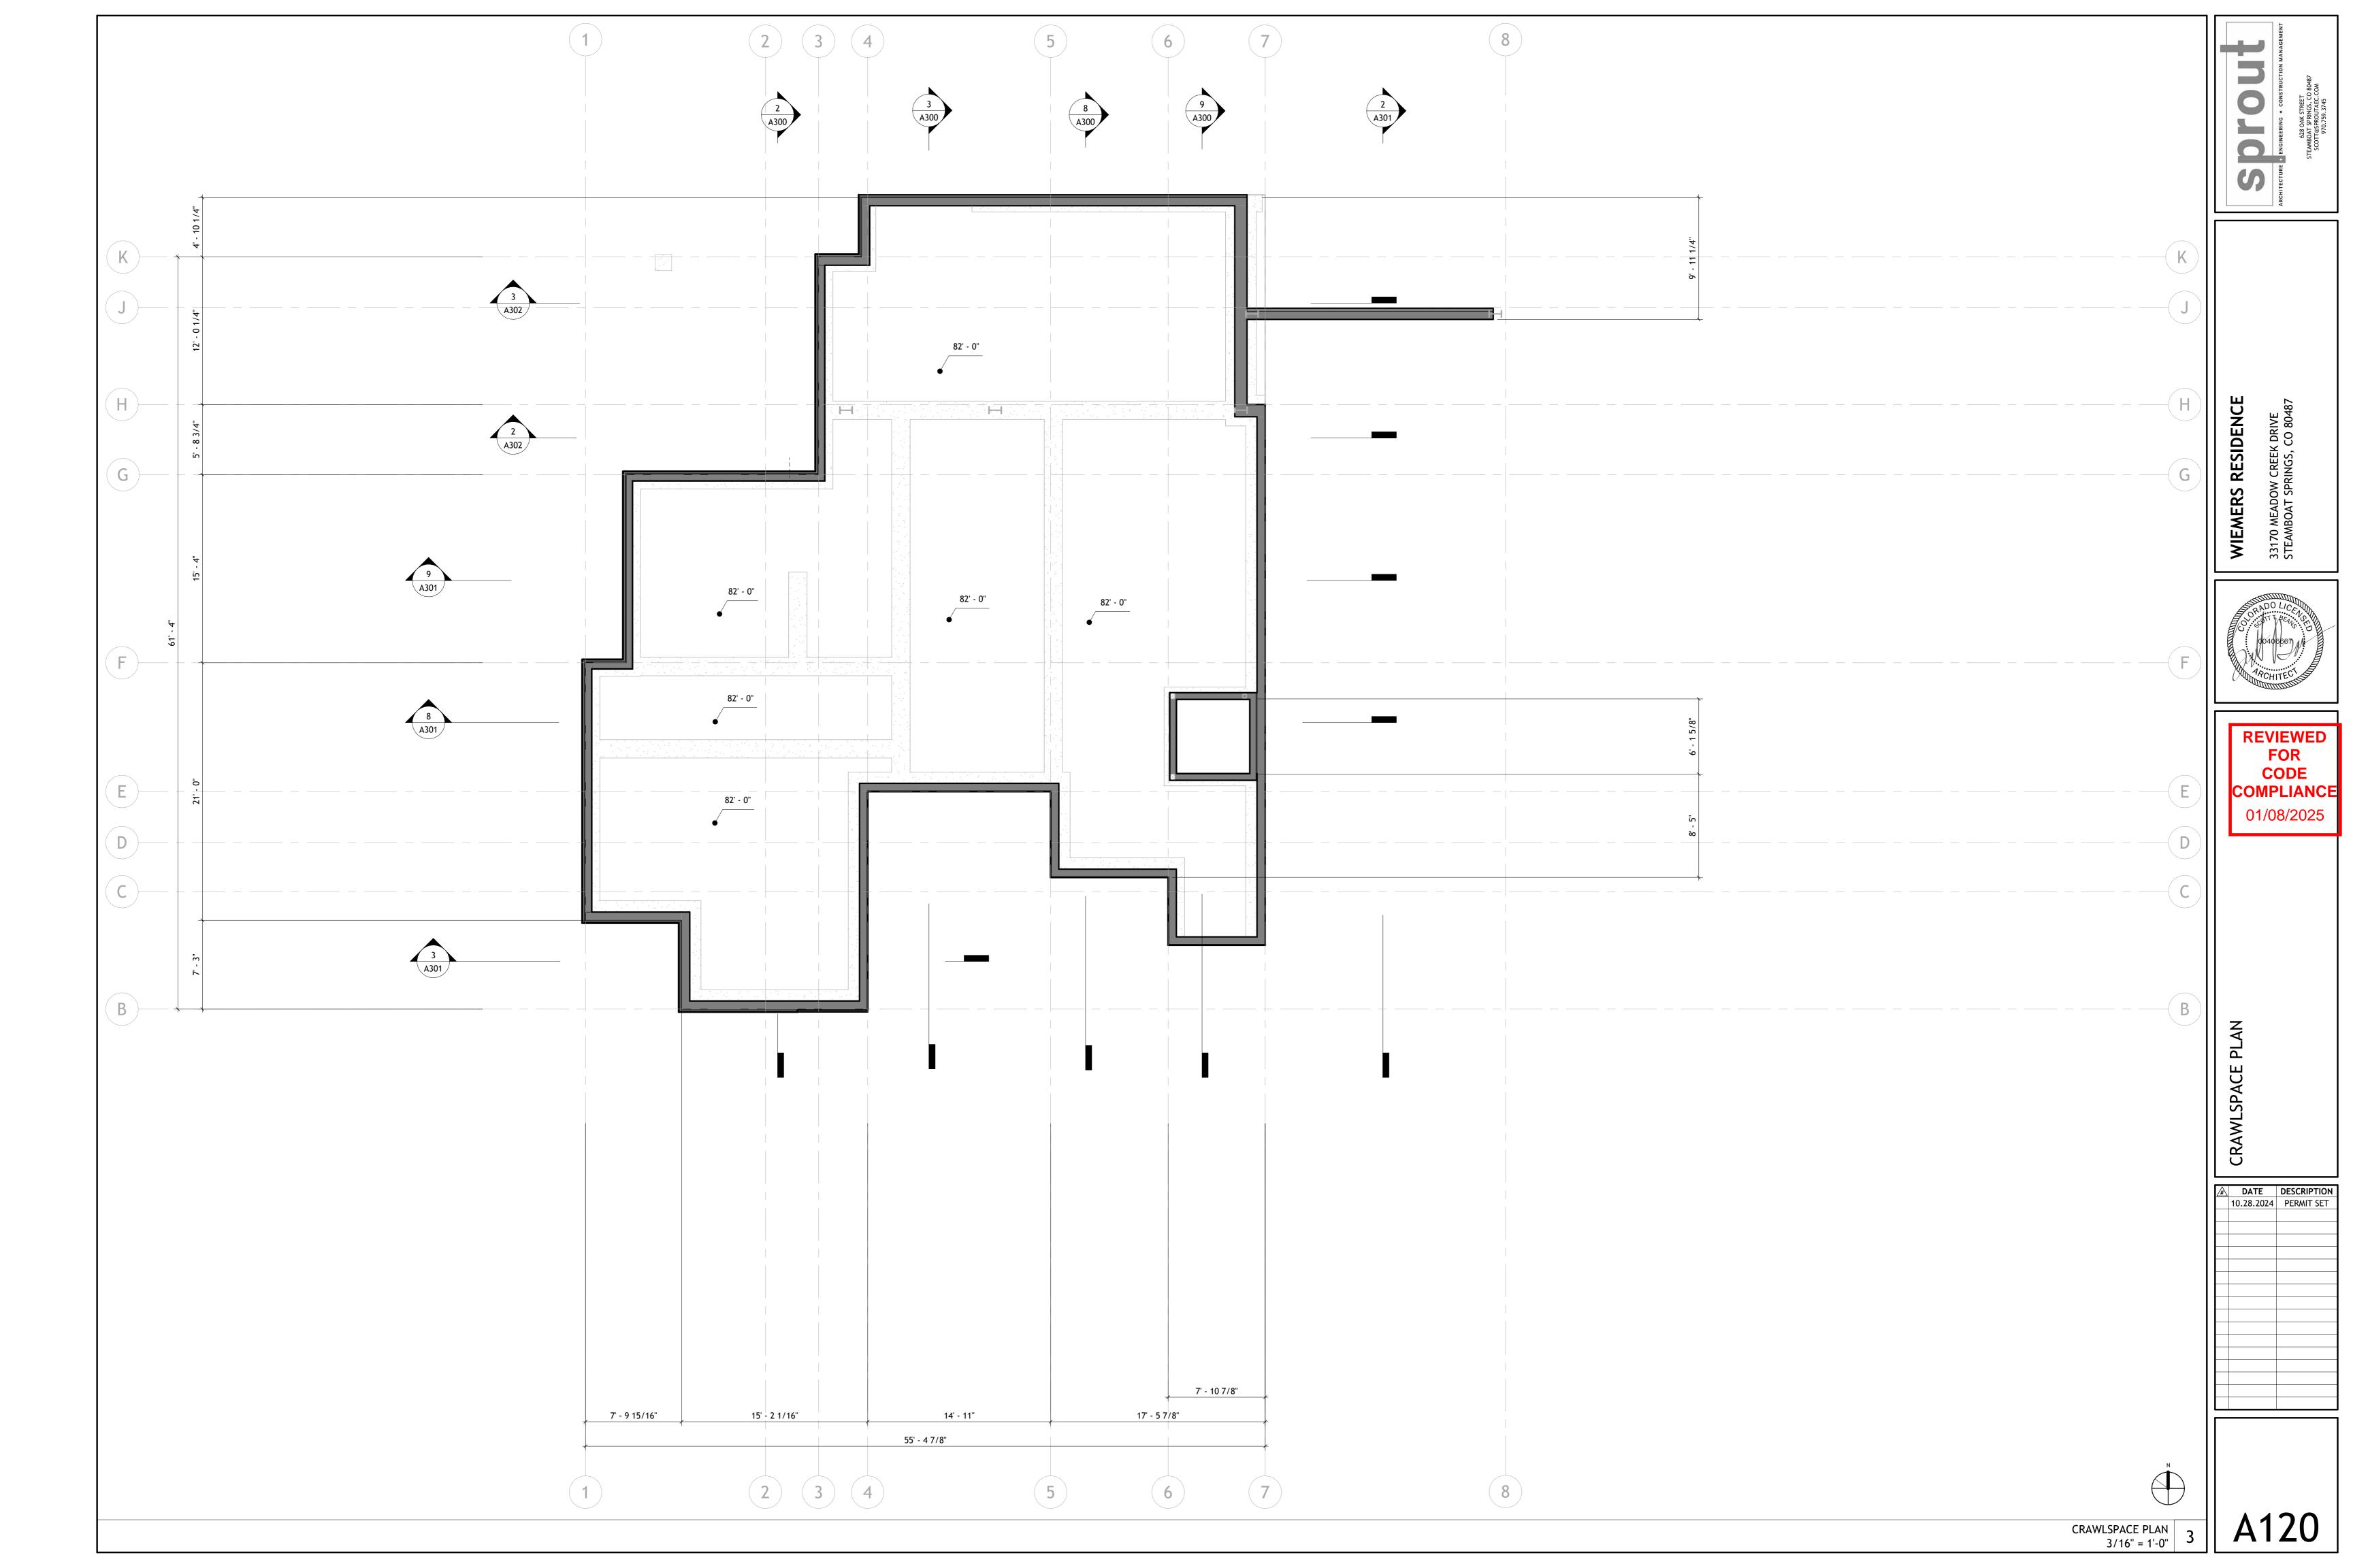





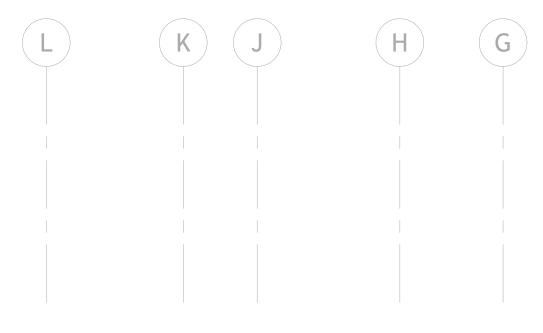




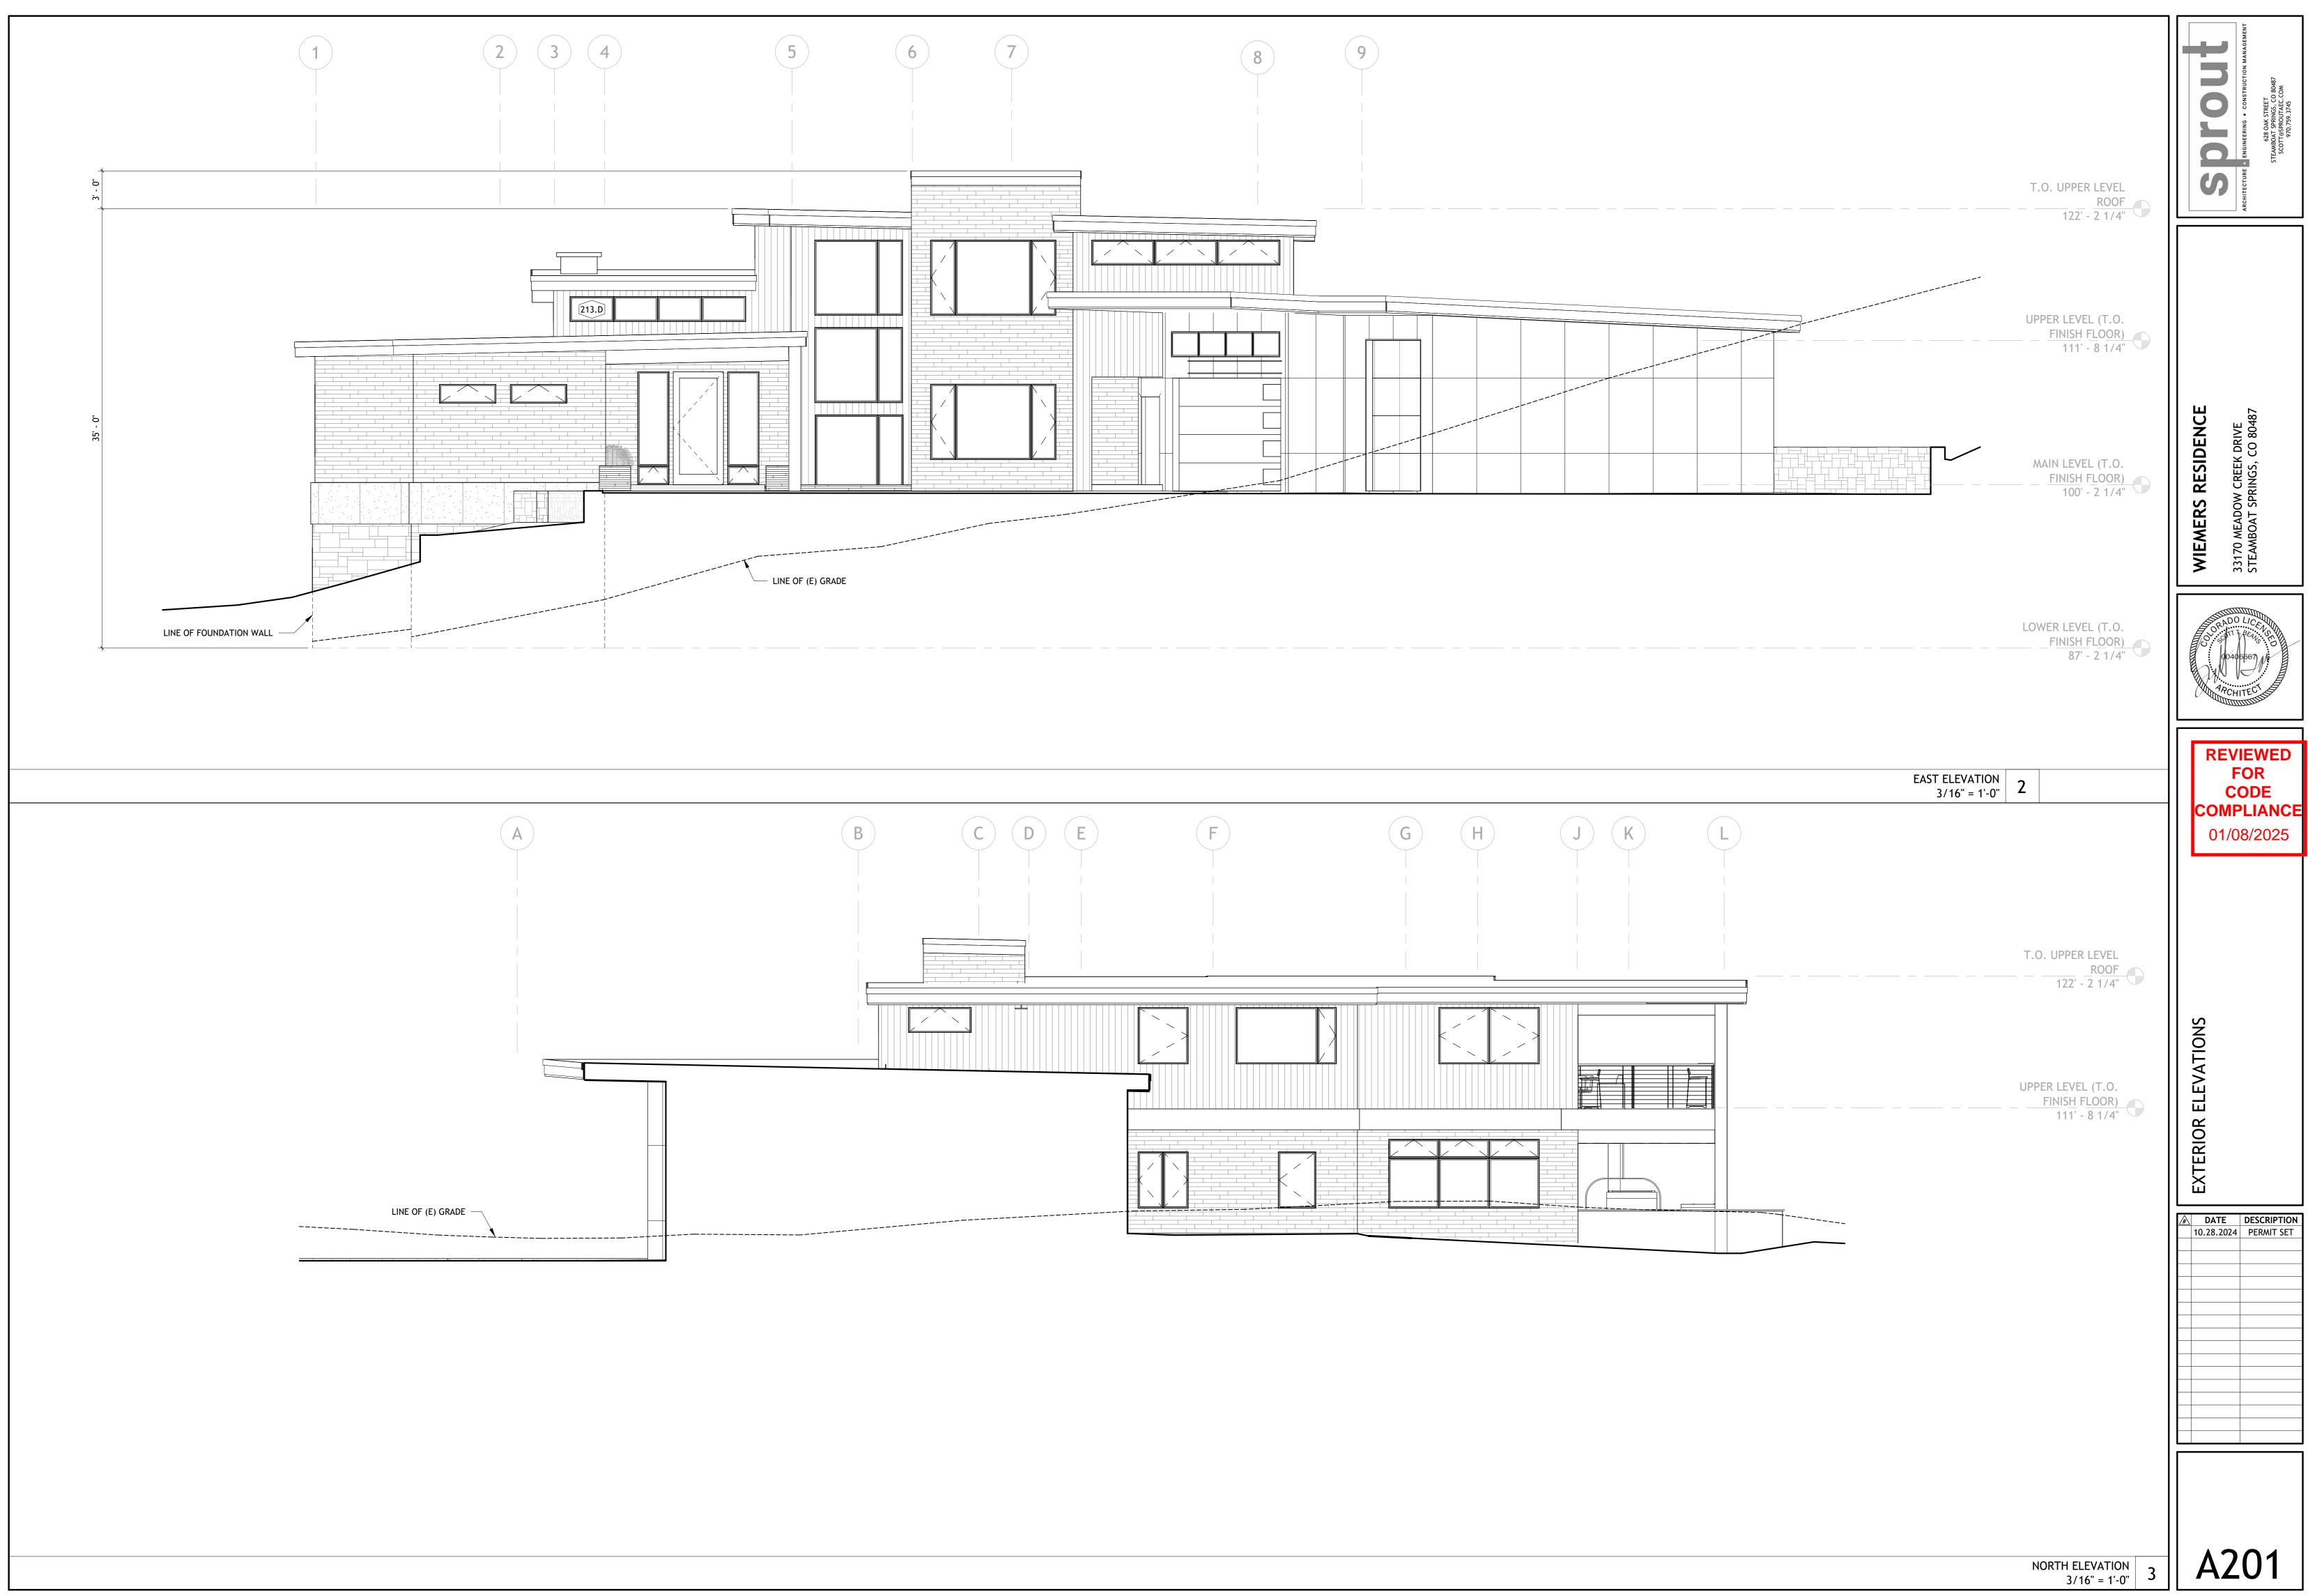


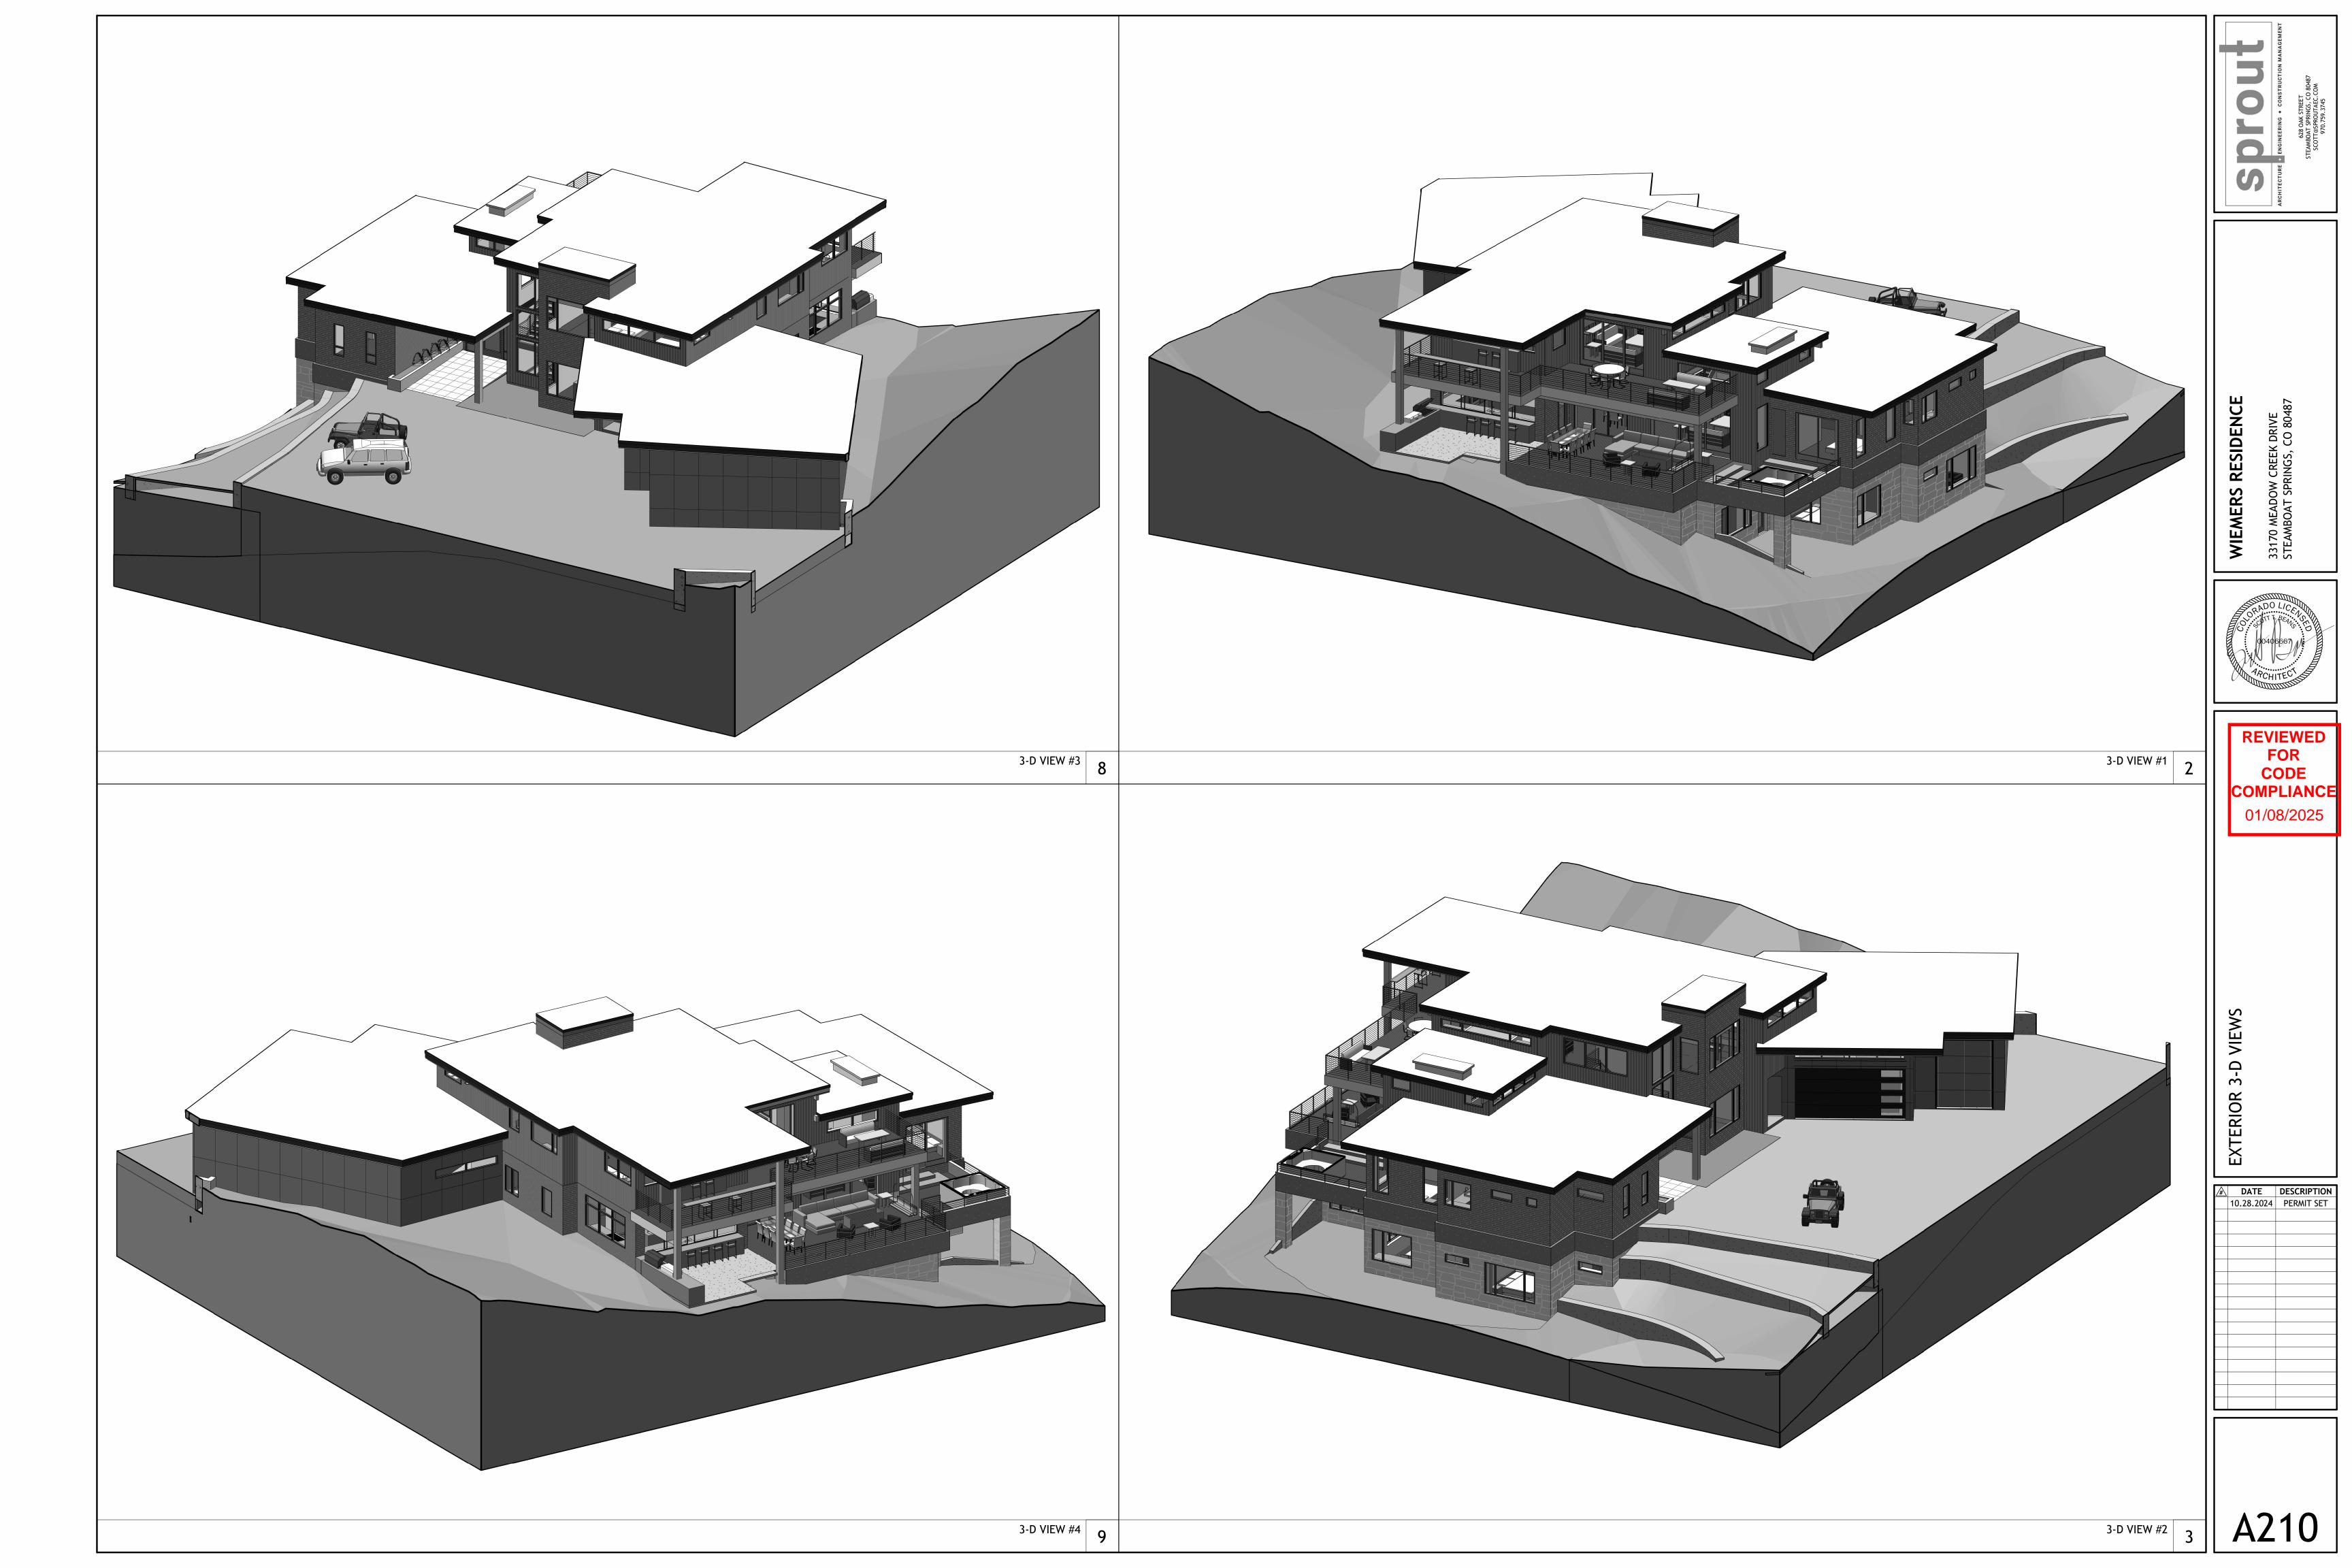


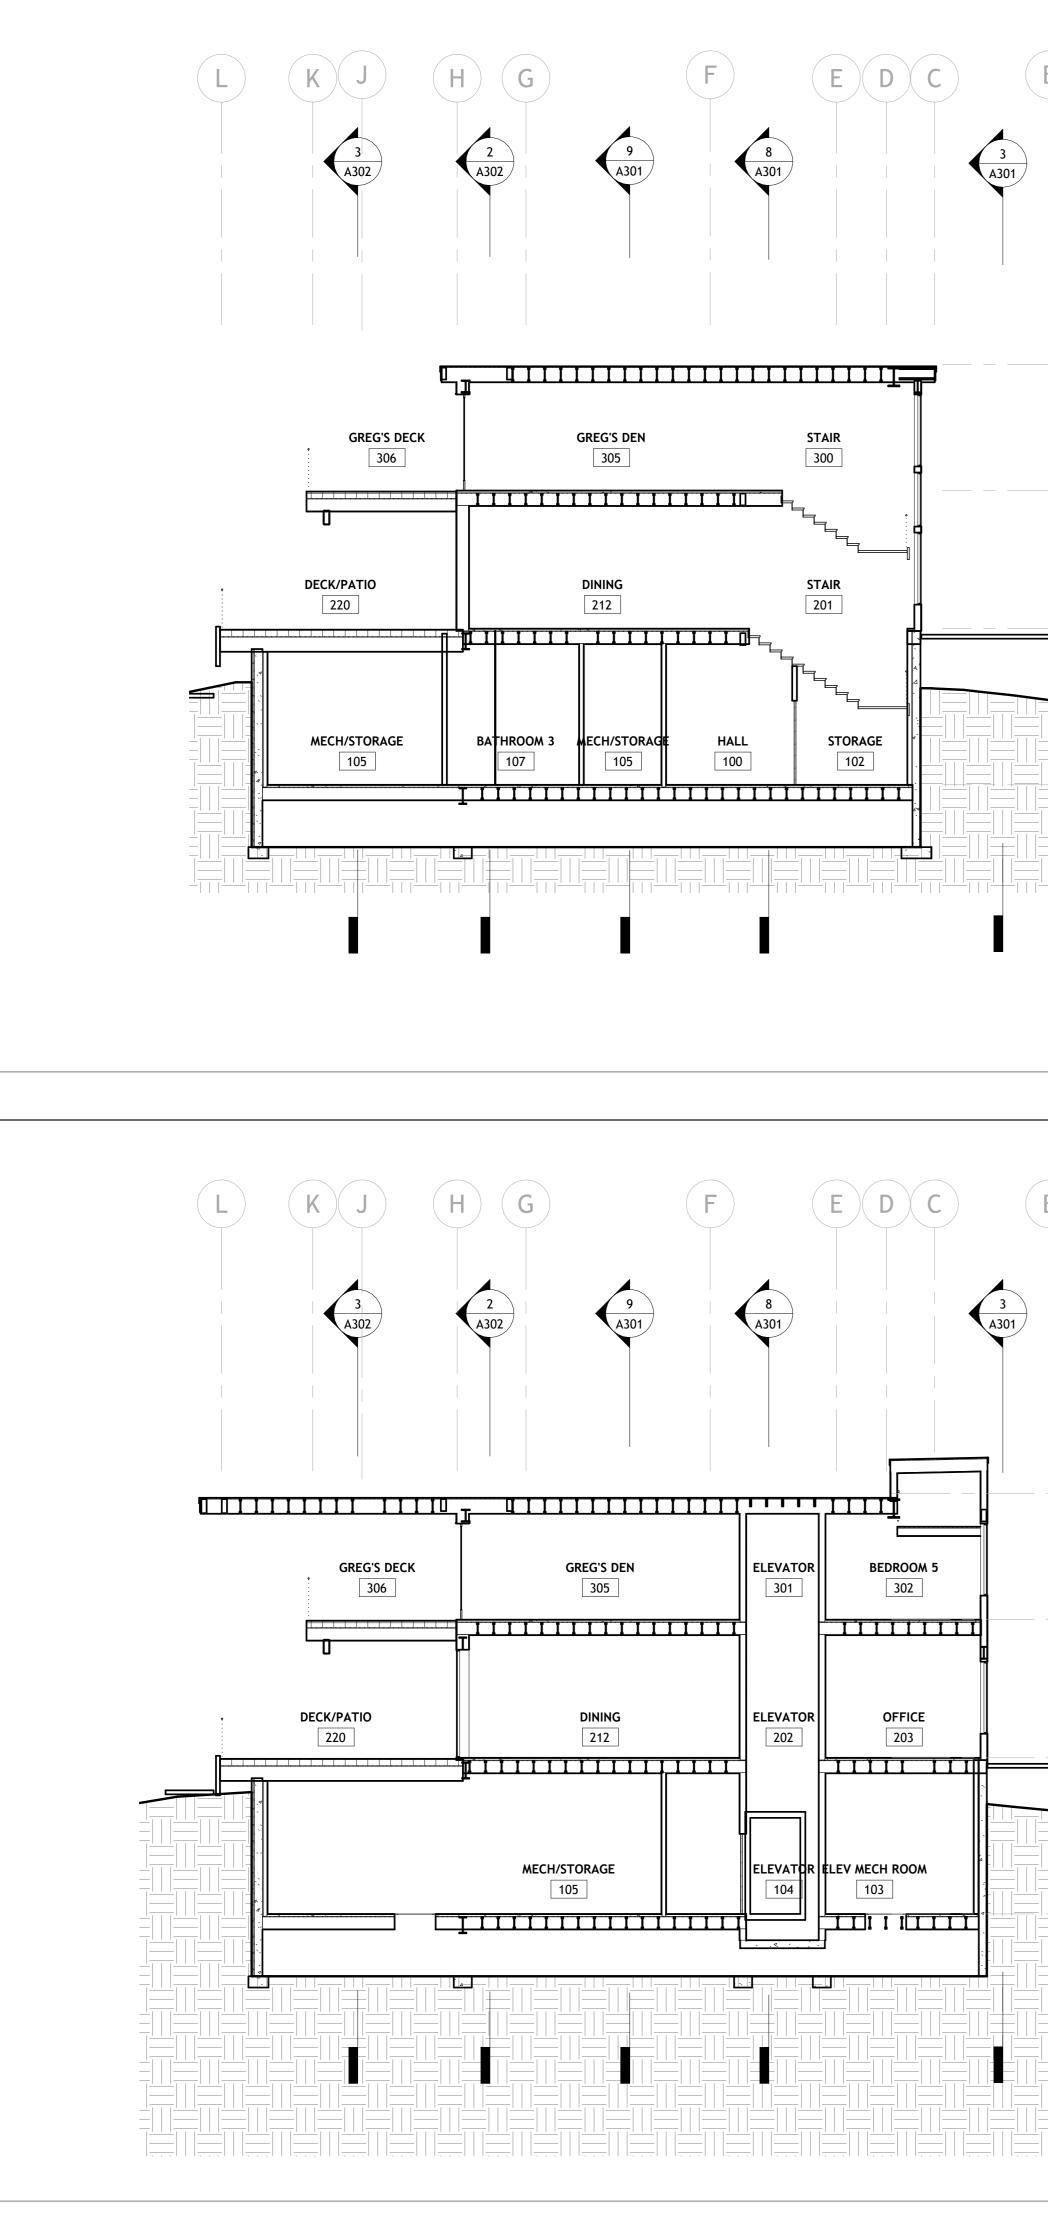


B	$\begin{array}{c c} \mathbf{L} & \mathbf{K} & \mathbf{J} & \mathbf{H} & \mathbf{G} \\ \hline 3 \\ \hline 3 \\ \mathbf{A}302 \\ $
T.O. UPPER LEVEL <u>ROOF</u> 122' - 2 1/4"	
UPPER LEVEL (T.O. 	DECK/PATIO
MAIN LEVEL (T.O. <u>FINISH FLOOR)</u> 100' - 2 1/4"	
LOWER LEVEL (T.O. FINISH FLOOR) 87' - 2 1/4"	
SECTION 3 1/8" = 1'-0"	3
	$\begin{array}{c c} \mathbf{L} & \mathbf{K} & \mathbf{J} & \mathbf{H} & \mathbf{G} \\ & & & & & \\ & & & & \\ & & & & \\ & & & & \\ & & & & \\ & & & & \\ & & & & \\ $
T.O. UPPER LEVEL 	
UPPER LEVEL (T.O. 	GREG'S DECK
MAIN LEVEL (T.O. <u>FINISH FLOOR)</u> 100' - 2 1/4"	
IIIIIIIIIIIIIIIIIIIIIIIIIIIIIIIIIIII	
SECTION 4 1/8" = 1'-0"	

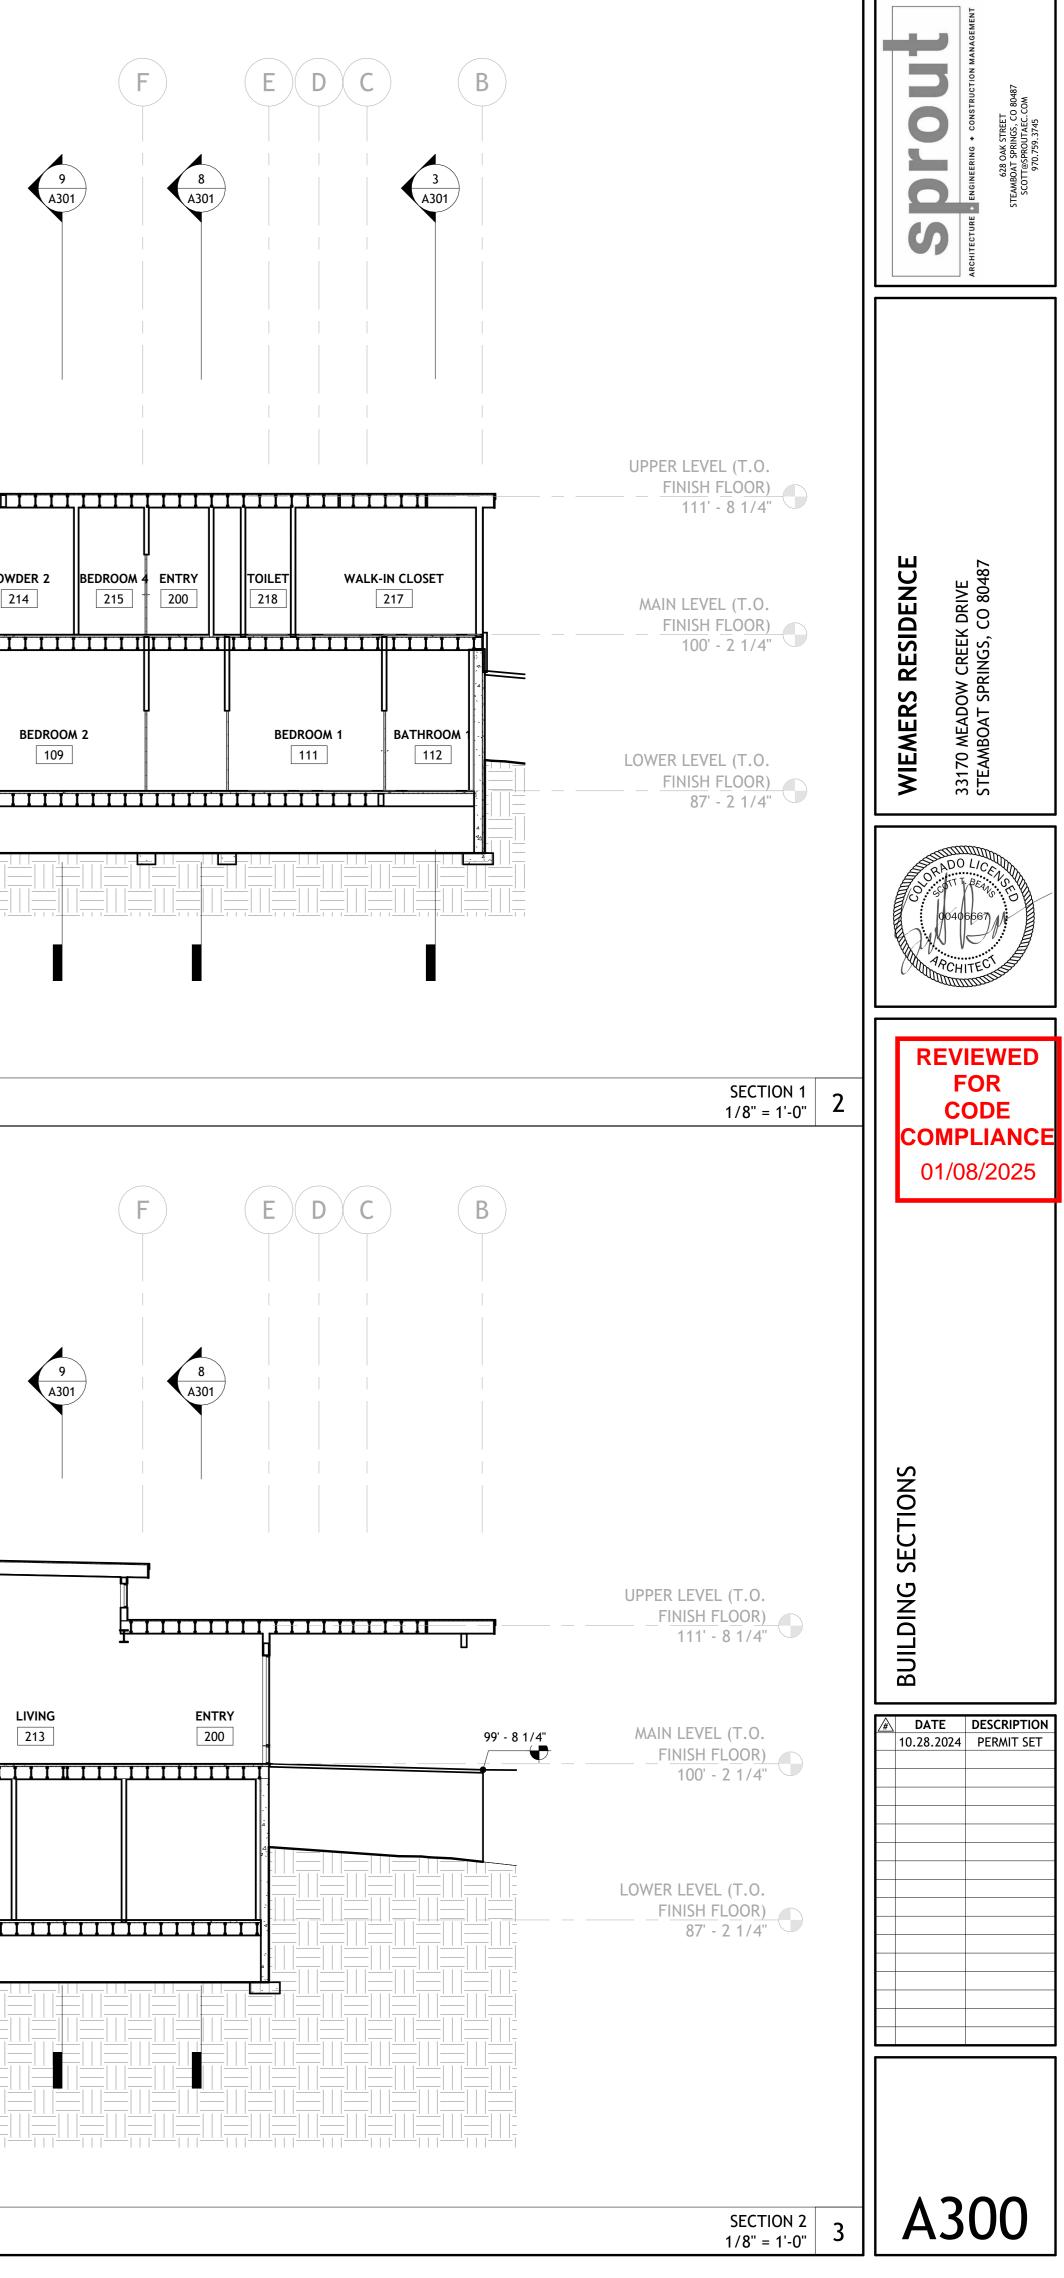

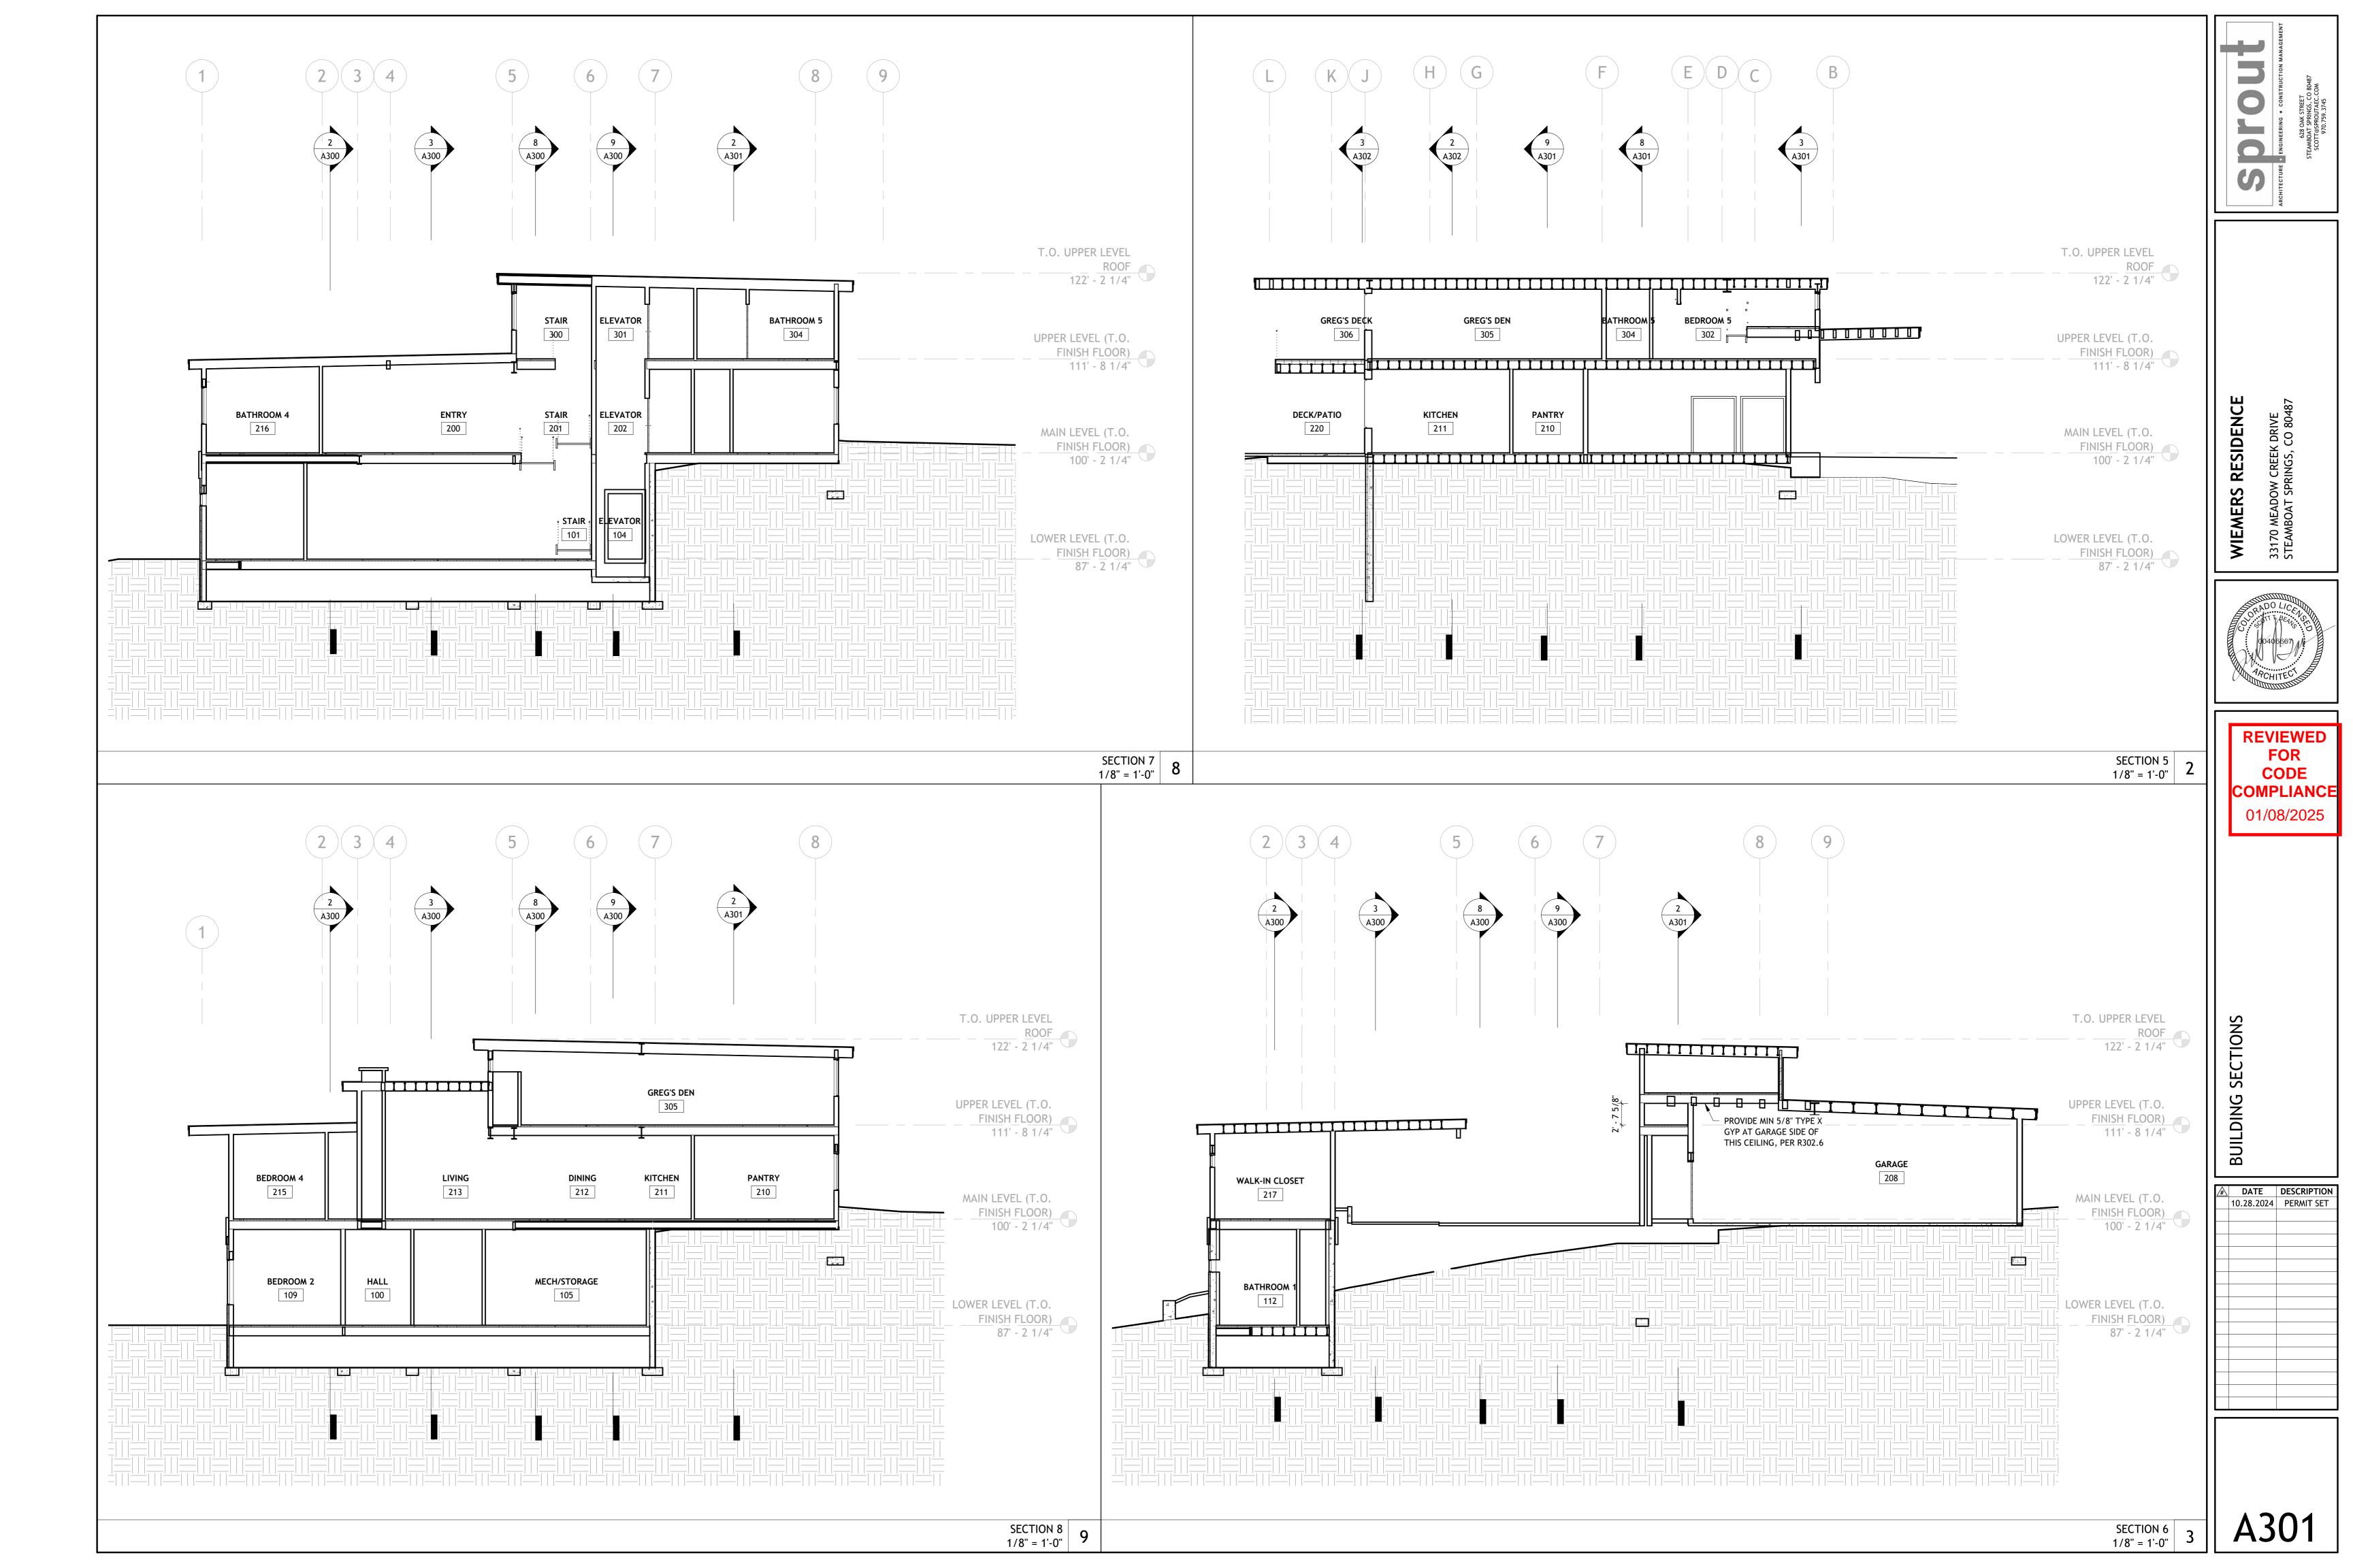

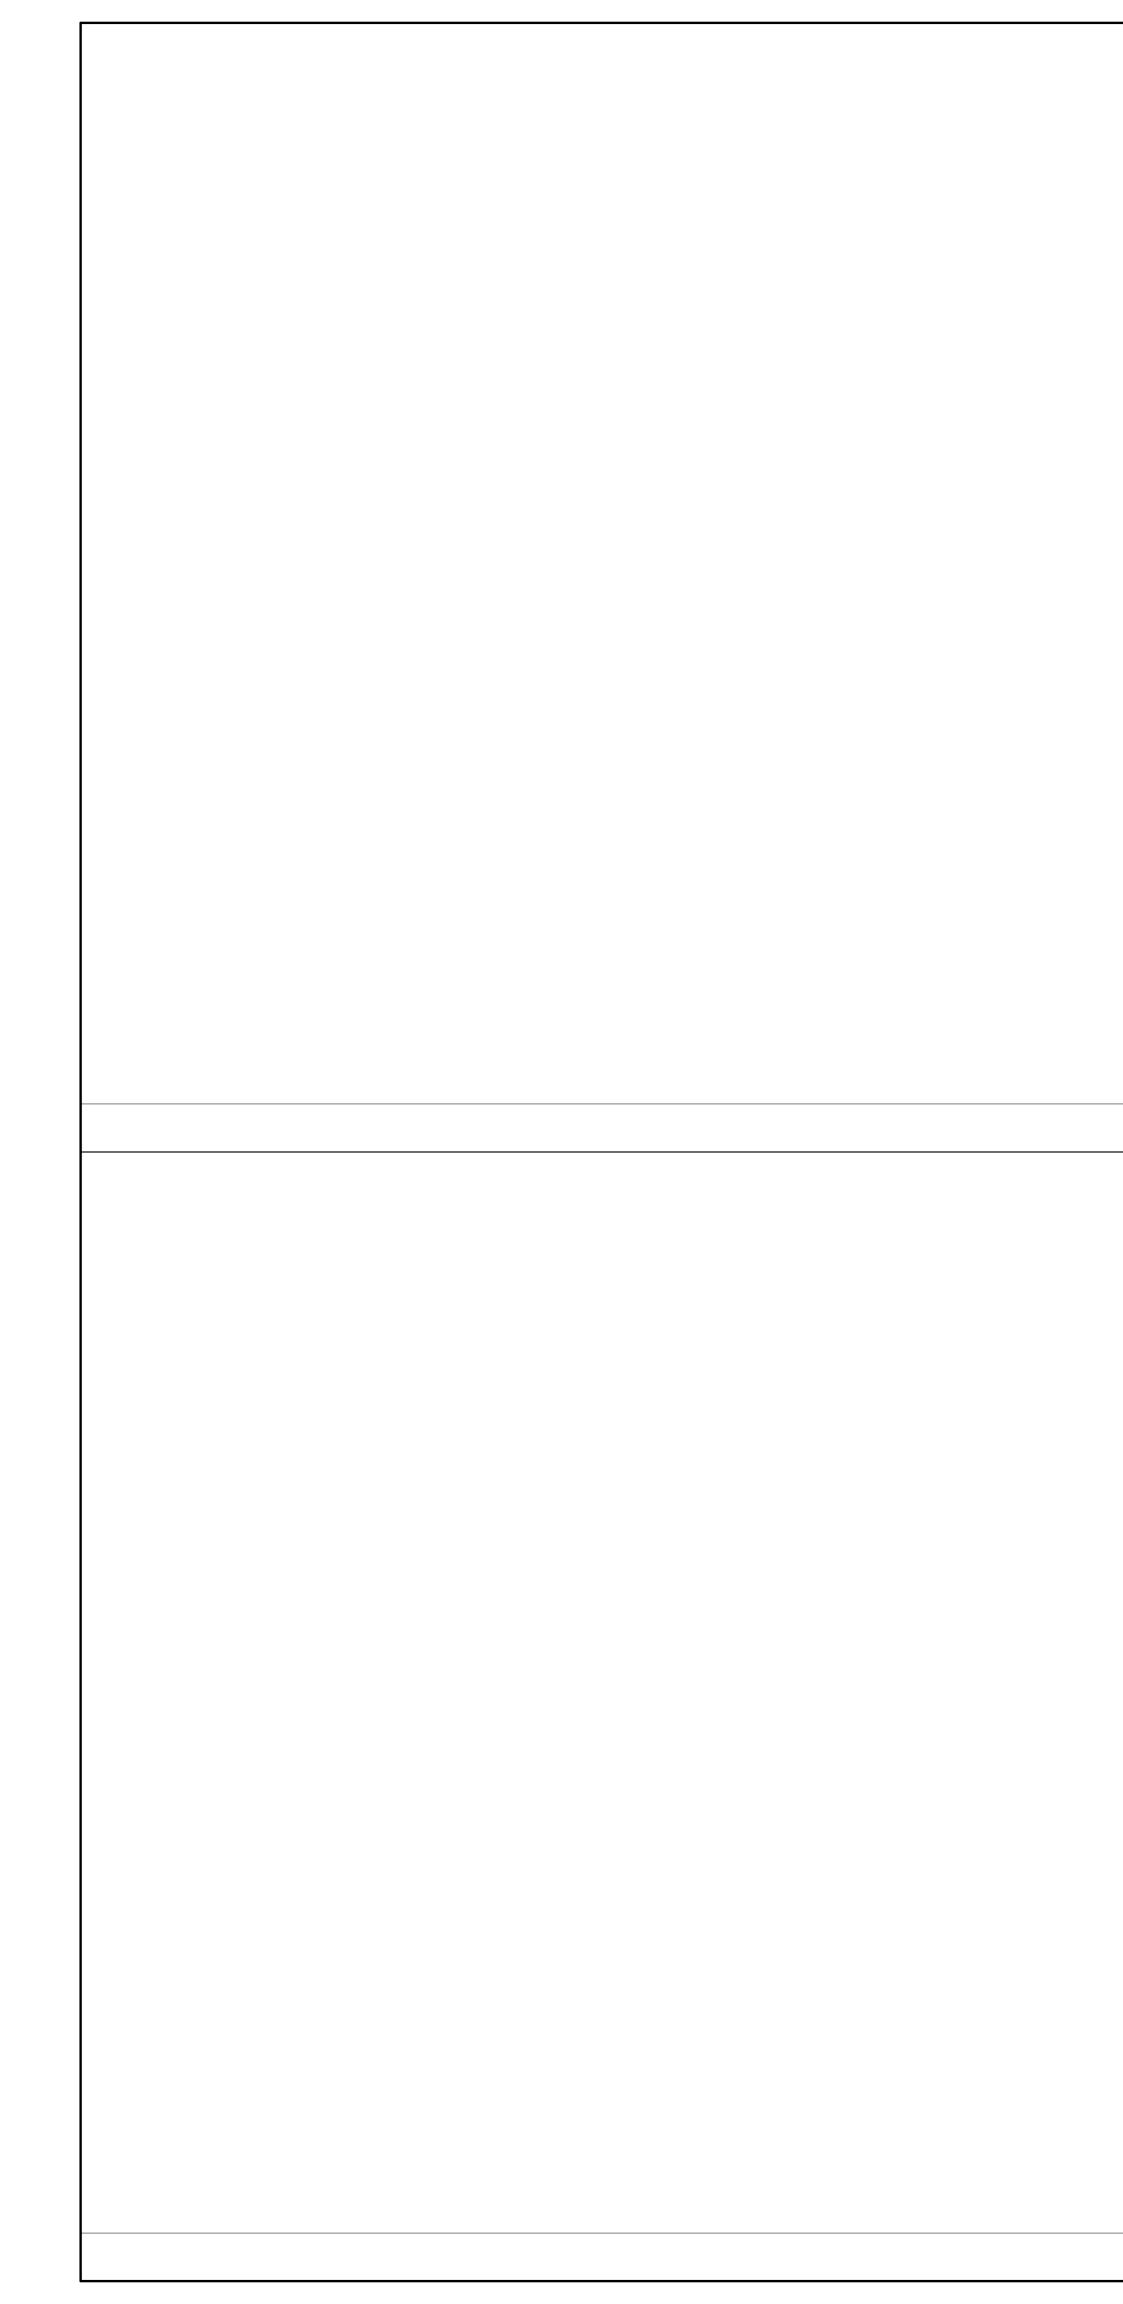

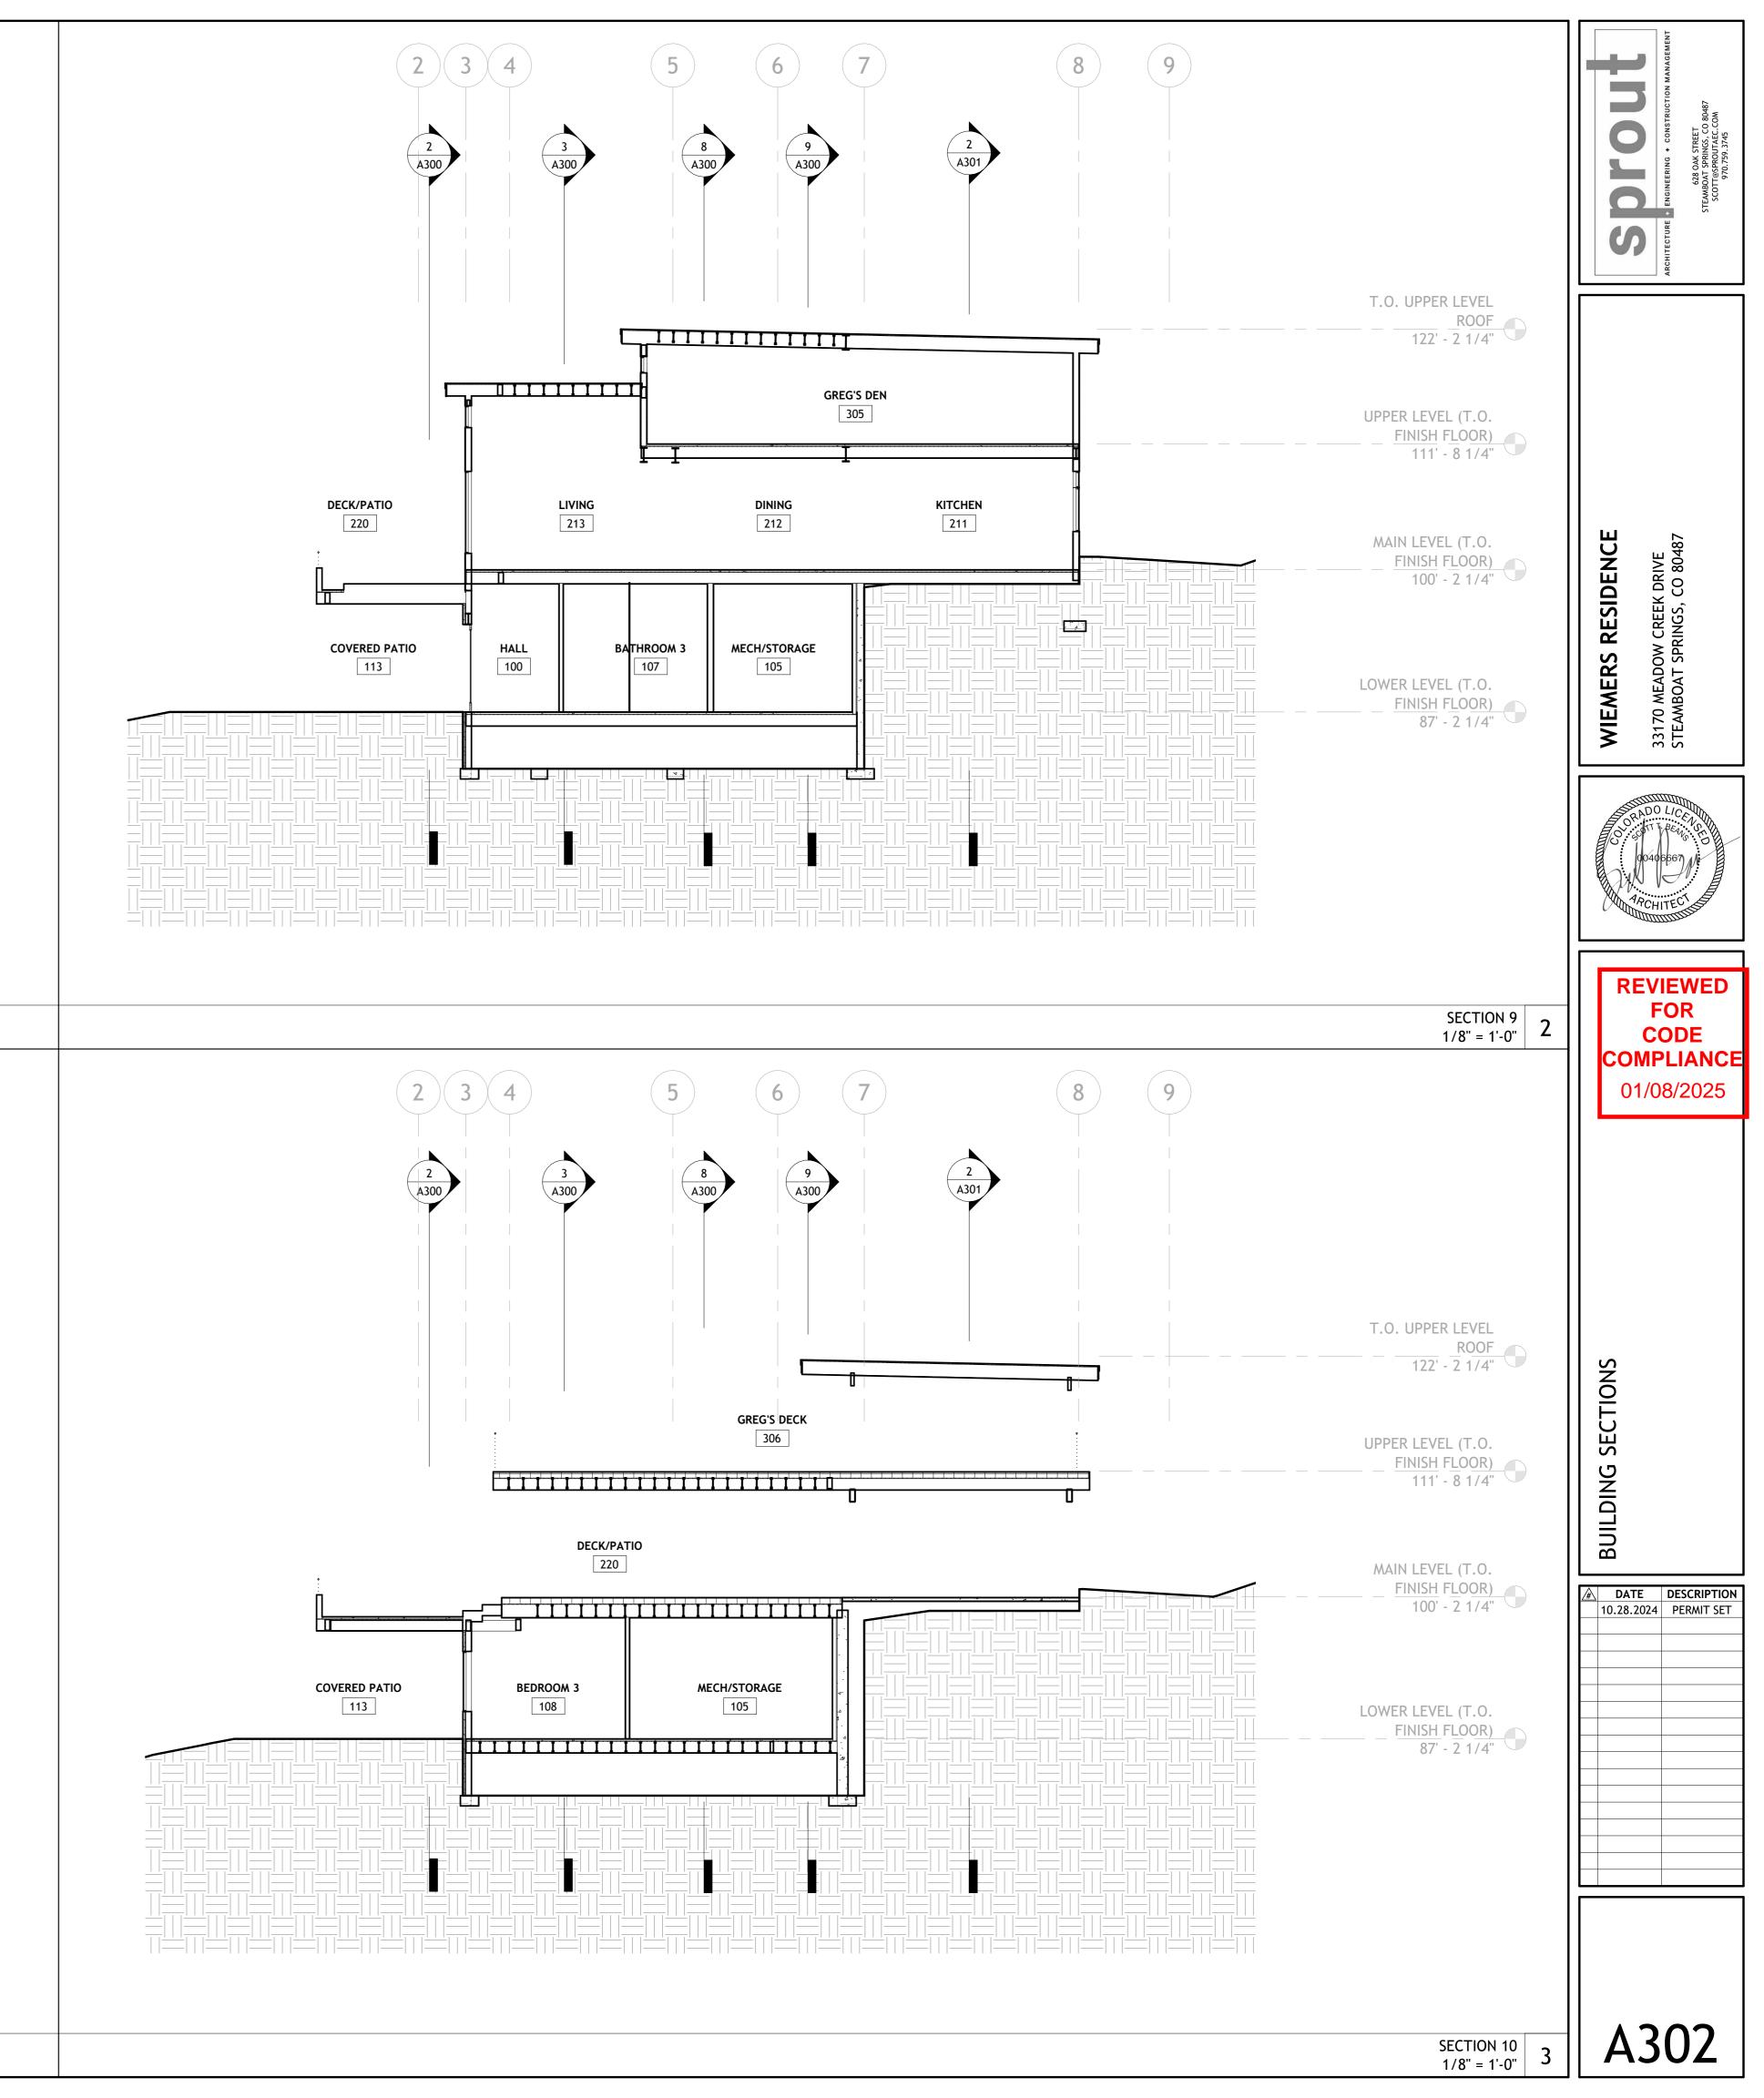

				WIND	OW SCHEDULE			DOOR SCHEDULE		EWEN
NUM	ER TYPE	WIDTH	HEIGHT HEAD HEI	GHT DESCRIPTION MAT	TERIAL FINISH COMMENTS	NUMBER TYPE WIDTH HEIGHT	DESCRIPTION	MATERIAL	FINISH COMMENTS	
108.A 108.B			5' - 6" 8' - 0" 5' - 6" 8' - 0"	CASEMENT WINDOW FIXED WINDOW	EMERGENCY ESCAPE AND RESCUE OPENING (EERO)		EXTERIOR SINGLE SWING GLASS DOOR INTERIOR SINGLE SWING DOOR			80487 INCTION
108.C	C4	5 - 6 2' - 0"	5' - 6" 8' - 0"	CASEMENT WINDOW		103.1 L1 3' - 0" 5' - 6"	INTERIOR CASED OPENING			+ consi STREET STREET STREET 9.3745
109.A 109.B	D14 C4	5' - 6" 2' - 0"	5' - 6" 8' - 0" 5' - 6" 8' - 0"	FIXED WINDOW CASEMENT WINDOW		104.1 G8 3' - 8" 6' - 8"	FLOOR ACCESS HATCH INTERIOR SINGLE SWING DOOR		CRAWLSPACE ACCESS DOOR	IEERING 628 OAK 0AT SPRING 970.755
109.C 109.D	D14	2' - 0" 5' - 6"	5' - 6" 8' - 0" 5' - 6" 8' - 0"	CASEMENT WINDOW FIXED WINDOW	EMERGENCY ESCAPE AND RESCUE OPENING (EERO)	105.2 N2 4' - 0" 3' - 0"	INTERIOR DOUBLE SWING DOOR FLOOR ACCESS HATCH		CRAWLSPACE ACCESS DOOR	
110.A 111.A	B3 C4	4' - 6" 2' - 0"	1' - 6" 8' - 0" 5' - 6" 8' - 0"	AWNING WINDOW CASEMENT WINDOW	EMERGENCY ESCAPE AND RESCUE OPENING (EERO)		SINGLE SWING DOOR INTERIOR SINGLE SWING DOOR		CRAWLSPACE ACCESS DOOR	
111.B 111.C	D14	5' - 6" 2' - 0"	5' - 6" 8' - 0" 5' - 6" 8' - 0"	FIXED WINDOW CASEMENT WINDOW			INTERIOR SINGLE SWING DOOR INTERIOR SINGLE SWING DOOR			ARCHITE
112.A 200.A	B3	4' - 6"	1' - 6" 8' - 0" 7' - 6" 9' - 0"	AWNING WINDOW FIXED WINDOW		109.1 G6 3' - 0" 6' - 8"	INTERIOR SINGLE SWING DOOR INTERIOR POCKET DOOR			
200.B	B1	2' - 6"	1' - 6" 1' - 6"	AWNING WINDOW		111.1 G6 3' - 0" 6' - 8"	INTERIOR SINGLE SWING DOOR			
200.C 200.D	B1	2' - 6" 2' - 6"	7' - 6" 9' - 0" 1' - 6" 1' - 6"	FIXED WINDOW AWNING WINDOW		112.2 G2 2' - 6" 6' - 8"	INTERIOR SINGLE SWING DOOR INTERIOR SINGLE SWING DOOR			
201.A 201.B	D7 D7	3' - 6" 3' - 6"	6' - 0" 8' - 0" 6' - 0" 8' - 0"	FIXED WINDOW FIXED WINDOW		202.1 G8 3' - 8" 6' - 8"	EXTERIOR SINGLE SWING GLASS DOOR INTERIOR SINGLE SWING DOOR			
203.A 203.B	C6 C5	3' - 6" 2' - 0"	6' - 0" 8' - 0" 6' - 0" 8' - 0"	CASEMENT WINDOW CASEMENT WINDOW			INTERIOR POCKET DOOR INTERIOR POCKET DOOR			
203.C 207.A	D17 C2	6' - 0" 2' - 0"	6' - 0" 8' - 0" 4' - 6" 8' - 0"	FIXED WINDOW CASEMENT WINDOW			INTERIOR SLIDING CLOSET DOOR INTERIOR SLIDING CLOSET DOOR			
207.B	-	2' - 0"	4' - 6" 8' - 0"	CASEMENT WINDOW AWNING WINDOW		207.1 J2 3' - 0" 6' - 8"	INTERIOR POCKET DOOR INTERIOR SINGLE SWING DOOR		DOOR AND OPENING SHALL COMPLY WITH IRC R302.5	
208.A 208.B			1' - 6" 9' - 6"	AWNING WINDOW		208.1 G7 3' - 0" 7' - 0"	INTERIOR SINGLE SWING DOOR			
208.C 208.D		4' - 6" 4' - 6"	2' - 0" 12' - 2 1/4" 2' - 0" 12' - 2 1/4"	FIXED WINDOW FIXED WINDOW			GARAGE DOOR WITH LITES GARAGE DOOR			CE
208.E 208.F			2' - 0" 12' - 2 1/4" 2' - 0" 12' - 2 1/4"	FIXED WINDOW FIXED WINDOW			INTERIOR CASED OPENING EXTERIOR SINGLE SWING GLASS DOOR			ESIDENC CREEK DRIVE NGS, CO 804
210.A 210.D			4' - 6" 8' - 0" 6' - 0" 8' - 0"	FIXED WINDOW CASEMENT WINDOW		213.1 B2 15' - 0" 9' - 0"	EXTERIOR THREE PANEL SLIDING GLASS DOOR INTERIOR SINGLE SWING DOOR		XXO	S, CO 80-
211.A	A2	2 - 0 18' - 0"	6' - 0" 9' - 0"	FOUR PANEL SLIDING WINDOW (OXXO)		215.1 G6 3' - 0" 6' - 8"	INTERIOR SINGLE SWING DOOR			CREE RES
211.B 211.C	B4	4' - 0"	4' - 0" 7' - 6" 1' - 6" 9' - 0"	FIXED WINDOW AWNING WINDOW		216.1 G2 2' - 6" 6' - 8"	EXTERIOR TWO PANEL SLIDING GLASS DOOR INTERIOR SINGLE SWING DOOR		XO, EMERGENCY ESCAPE AND RESCUE OPENING (EERO)	T SPR
211.D 211.E			4' - 0" 7' - 6" 1' - 6" 9' - 0"	FIXED WINDOW AWNING WINDOW			INTERIOR CASED OPENING INTERIOR SINGLE SWING DOOR			
211.F 211.G	D13	4' - 0"	4' - 0" 7' - 6" 1' - 6" 9' - 0"	FIXED WINDOW AWNING WINDOW		219.1 F1 5' - 0" 6' - 8"	INTERIOR DOUBLE SWING DOOR INTERIOR SINGLE SWING DOOR			<u> </u>
212.A			9' - 0" 9' - 0" 9' - 0" 9' - 0"	CASEMENT WINDOW FIXED WINDOW		302.1 H1 3' - 0" 6' - 8"	INTERIOR BARN DOOR INTERIOR SINGLE SWING DOOR			3317 VI
212.B 212.C	•		9' - 0" 9' - 0"	CASEMENT WINDOW		303.2 G1 1' - 2" 1' - 2"	INTERIOR SINGLE SWING DOOR			
212.D 212.E	D5 D5	3' - 6" 3' - 6"	2' - 0" 3' - 6" 2' - 0" 3' - 6"	FIXED WINDOW FIXED WINDOW		304.2 G2 2' - 6" 6' - 8"	INTERIOR SINGLE SWING DOOR INTERIOR SINGLE SWING DOOR			OPRADO LICENS
212.F 213.A		3' - 6" 3' - 6"	2' - 0" 3' - 6" 7' - 6" 9' - 0"	FIXED WINDOW FIXED WINDOW			EXTERIOR THREE PANEL SLIDING GLASS DOOR		ХХО	
213.B	D5	3' - 6"	2' - 0" 3' - 6"	FIXED WINDOW FIXED WINDOW						90406667 Mi
213.C 213.D	D5	3' - 6"	2' - 0" 3' - 6"	FIXED WINDOW						ARCHITEC S
215.A 215.B	C9 C9		6' - 6" 8' - 0" 6' - 6" 8' - 0"	CASEMENT WINDOW CASEMENT WINDOW						ARCHITEC'
215.D 215.E	D15 D15	5' - 0" 5' - 0"	2' - 0" 3' - 6" 2' - 0" 3' - 6"	FIXED WINDOW FIXED WINDOW						
216.A 216.B	D4		4' - 6" 8' - 0" 4' - 6" 8' - 0"	FIXED WINDOW CASEMENT WINDOW						REVIEWED
216.C	D6	3' - 6"	4' - 6" 8' - 0"	FIXED WINDOW						FOR
216.D 217.A	B2	2' - 0"	1' - 6" 8' - 0" 1' - 6" 8' - 0"	AWNING WINDOW AWNING WINDOW						CODE
217.B 217.C			1' - 6" 8' - 0" 4' - 0" 8' - 0"	AWNING WINDOW CASEMENT WINDOW		_				
217.D 217.E	D3	2' - 0"	1' - 6" 4' - 0" 4' - 0" 8' - 0"	FIXED WINDOW CASEMENT WINDOW						01/08/2025
217.F	D3	2' - 0"	1' - 6" 4' - 0"	FIXED WINDOW						
300.A 300.B	D12	4' - 0"	4' - 6" 8' - 0" 4' - 6" 8' - 0"	FIXED WINDOW FIXED WINDOW						
300.C 300.D		a	4' - 6" 8' - 0" 4' - 6" 13' - 0"	FIXED WINDOW FIXED WINDOW						
300.E 300.F			6' - 0" 8' - 0" 4' - 6" 13' - 0"	FIXED WINDOW FIXED WINDOW						
300.G 302.A	D7		6' - 0" 8' - 0" 6' - 0" 8' - 0"	FIXED WINDOW CASEMENT WINDOW	EMERGENCY ESCAPE AND RESCUE OPENING (EERO)					
302.B	C5	2' - 0"	6' - 0" 8' - 0"	CASEMENT WINDOW						
302.C 302.D	D17 C5		6' - 0" 8' - 0" 6' - 0" 8' - 0"	FIXED WINDOW CASEMENT WINDOW						
302.E 302.F	B7 B7	5' - 0" 5' - 0"	2' - 0" 8' - 0" 2' - 0" 8' - 0"	AWNING WINDOW AWNING WINDOW						
302.G 302.H	B7	5' - 0"	2' - 0" 8' - 0" 2' - 0" 8' - 0"	AWNING WINDOW AWNING WINDOW						SC
304.A	C8	3' - 0"	4' - 6" 8' - 0"	CASEMENT WINDOW						
305.A 305.B	D18	9' - 0"	1' - 6" 8' - 0" 1' - 6" 8' - 0"	FIXED WINDOW FIXED WINDOW						ğ
305.C 305.D		4' - 0" 4' - 0"	1' - 6" 8' - 0" 4' - 6" 8' - 0"	FIXED WINDOW FIXED WINDOW						
305.E 305.F			4' - 6" 8' - 0" 4' - 6" 8' - 0"	FOUR PANEL SLIDING WINDOW (OXXO) CASEMENT WINDOW						لت
305.G 305.H	C10	4' - 0"	4' - 6" 8' - 0" 4' - 6" 8' - 0"	CASEMENT WINDOW CASEMENT WINDOW						Ň
305.J	D16		4 - 6 8 - 0 4' - 6" 8' - 0"	FIXED WINDOW						8
GRAND	OTAL: 87									ATE DESCRIPTION
										Z#DATEDESCRIPTION10.28.2024PERMIT SET
					WINDOW SCHEDULE NO SCALE	9			DOOR SCHED NO SC	

	DOOR & WINDOW SCH	
/# \	DATE	DESCRIPTION
	10.28.2024	PERMIT SET
⊢		
	A5	00

