Verizon

SITE NAME: CO1 CATAMOUNT

PROJECT ID: 2061798

PROJECT: 5G L-SUB6 - CARRIER ADD

SITE ADDRESS: 31800 CR 14C

STEAMBOAT SPRINGS, CO 80487

COUNTY: ROUTT

JURISDICTION: ROUTT COUNTY

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REFERENCE DOCUMENTS

NEW SITE ELEVATION

LOCATION MAP SITE LOCATION (18) (14C) NORTH

ROM 10000 PARK MEADOWS DR (VERIZON OFFICE), HEAD NORTHWEST TOWARD PARK MEADOWS DR (128FT) HEAD NORTHWEST TOWARD PARK MEADOWS DR (0.1MI) TURN LEFT ONTO PARK MEADOWS DR (0.5MI) TURN RIGHT ONTO S YOSEMITE ST (0.3MI) USE THE LÊFT 2 LANES TO TURN LEFT TO MERGE ONTO CO-470 W (0.3MI) MERGE ONTO CO-470 W (24.7MI) USE THE RIGHT 2 LANES TO TAKE EXIT 1 TO MERGE ONTO 1-70 W TOWARD GRAND JCT (55.0MI) TAKE EXIT 205 TO MERGE ONTO CO-9 N/BLUE RIVER PKWY TOWARD SILVERTHORNE (37.6MI) TURN LEFT ONTO US-40 W/PARK AVE (44.8MI) TURN LEFT ONTO CO RD 20 (1.5MI) TURN LEFT ONTO CO-131 S (1.0MI) TURN LEFT ONTO CO RD 18 (1.6MI) TURN RIGHT ONTO CO RD 14C (0.4MI) DESTINATION WILL BE ON THE RIGHT.

SITE INFORMATION

MAP/PARCEL#:

AREA OF CONSTRUCTION: EXISTING BUILDING: ROOFTOP CUPOLA

NAD83

ATITUDE: 40° 21' 21.11" ONGITUDE 106° 49' 39.31'

CURRENT ZONING: AGRICULTURAL LAND

OCCUPANCY: STRUCTURE HEIGHT:

AT/I ONG TYPE

ADA COMPLIANCE: THIS FACILITY IS UNMANNED & NOT FOR HUMAN

APPLICABLE CODES

ALL WORK SHALL BE PERFORMED AND MATERIALS INSTALLED IN ACCORDANCE WITH THE CURRENT EDITIONS OF THE FOLLOWING CODES AS ADOPTED BY THE LOCAL GOVERNING AUTHORITIES OF EAGLE COUNTY. NOTHING IN THESE PLANS IS TO BE CONSTRUED TO PERMIT WORK NOT CONFORMING TO THESE CODES:

CODE 2021 CITY OF STEAMBOAT SPRINGS BUILDING CODE ADOPTION

2021 INTERNATIONAL BUILDING CODE (IBC) 2021 INTERNATIONAL EXISTING BUILDING CODE(IEBC)

MECHANICAL 2021 INTERNATIONAL MECHANICAL CODE (IMC) FUEL GAS 2021 INTERNATIONAL FUEL GAS CODE (IEGC) PLUMBING ELECTRICAL 2021 INTERNATIONAL PUEL GAS CODE (IPG) 2021 INTERNATIONAL PLUMBING CODE (IPC) 2023 NATIONAL ELECTRICAL CODE (NEC)

2021 INTERNATIONAL FIRE CODE (IEC) ENERGY 2021 INTERNATIONAL ENERGY CONSERVATION CODE (IECC) STEEL ANTENNA

TOWERS & SUPPORTS ANSI/TIA/EIA-222 LATEST EDITION

THE LITILITIES SHOWN HEREON ARE FOR THE CONTRACTORS CONVENIENCE ONLY. THERE MAY BE OTHER UTILITIES NOT SHOWN ON THESE PLANS. THE ENGINEER/ SURVEYOR ASSUMES NO RESPONSIBILITY FOR THE LOCATIONS SHOWN AND IT SHALL BE THE CONTRACTOR'S RESPONSIBILITY TO VERIEY ALL UTILITIES WITHIN THE LIMITS OF THE WORK, ALL DAMAGE MADE TO EXISTING UTILITIES BY THE CONTRACTOR SHALL BE THE SOLE RESPONSIBILITY OF THE CONTRACTOR TO REPAIR/REPLACE TO OWNER'S SATISFACTION





PROJECT DESCRIPTION

THIS PROJECT CONSISTS OF THE FOLLOWING:

REMOVAL

- NINE (9) EXISTING PANEL ANTENNAS
- TWELVE (12) EXISTING 7/8" COAX CABLES
- ONE (1) EXISTING RFS E105 WAVEGUIDE IRU600 RADIOS AND INUE SHELF
- TWO (2) EXISTING MOTOROLA CABINETS AND FILTERS

RELOCATE

THREE (3) EXISTING 4449 RRH UNITS

INSTALLATION

- THREE (3) NEW JMA MX12FIT465-01 PANEL ANTENNAS THREE (3) NEW ERICSSON AIR 6419 ANTENNA/RADIOS
- THREE (3) NEW 4890 RRH UNITS
- ONE (1) NEW 6627 12 POSITION MAIN OVP UNIT
- ONE (1) NEW 4520 12 POSITION MAIN OVP UNIT (RACK MOUNTED)
- ONE (1) NEW UPCONVERTER ONE (1) NEW 6651 BBU UNITS
- TWO (2) NEW 6X12 HYBRID CABLES
- TWO (2) NEW WTM 4100 RADIOS
- TWO (2) NEW HYBRID FIBER/POWER CABLES
- ONE (1) NEW CTR-8740 ROUTER
- NINE (9) NEW EHRESMANN ENGINEERING A-10-24-VSP-T-PR FANS
- ONE (1) NEW EHRESMANN ENGINEERING AERIAL FAN CONTROLLER
- TWO (2) NEW EHRESMANN ENGINEERING AERIAL TEMPERATURE MONITORS
- ONE (1) NEW EHRESMANN ENGINEERING AERIAL NOISE SENSOR NINE (9) NEW EHRESMANN ENGINEERING POWER CABLES
- NINE (9) NEW EHRESMANN ENGINEERING FAN MOUNTING BRACKETS
- THREE (3) NEW FAMCO BK10X ROOF EXHAUST VENTS
- TWO (2) NEW FRP-6 ENDURO TUFF SPAN 24"X24" STATIONARY LOUVERS

Sheet number

PROJECT TEAM

10000 PARK MEADOWS DRIVE, SUITE 300 LONE TREE, CO 80124-5453

EME REPORT BY VERIZON DATED: 03/04/2025

RFDS BY VERIZON WIRELESS DATED: 10/08/2024

STRUCTURAL ANALYSIS DATED: 10/15/2024

MOUNT ANALYSIS DATED: 10/15/2024

PCN MICROWAVE FINAL ENG. DATED: 09/09/2024

DISH MOUNT AND STRUCTURAL PE LETTER DATED: 12/02/2024

HEAT LOAD STUDY BY EE PARKER LLC DATED: 10/20/2024

SLAG RESOURCES COMPANY, LLC JOHN GRACE 970-846-0200 885 ANGLERS CT STEAMBOAT SPRINGS, CO 80487-8821

CONSTRUCTION ENGINEER: VERIZON WIRELESS ANDREW COLE 303-827-6279 10000 PARK MEADOWS DRIVE, SUITE 300 LONE TREE, CO 80124-5453

ENGINEER/DESIGNER: RETHERFORD ENTERPRISES, INC AARON ZAJICEK 720-371-3327 7093 SILVERHORN DR EVERGREEN, CO 80439 $\hbox{\tt AARON.ZAJICEK} @ {\tt RETHERFORDENTERPRISES.COM}$

SITE ACQUISITION: RETHERFORD ENTERPRISES, INC. RACHEL LONG 720-581-1940 RACHEL.LONG@RETHERFORDENTERPRISES.COM

ONE TREE, CO 80124-5453 RETHERFORD ENTERPRISES, INC.

ark meadows drive, suite 300

7093 SILVERHORN DRIVE EVERGREEN | CO | 80439 (720) 261-2064

REV	DATE	DESCRIPTION	CHK
1	03/26/25	REVISED PER COMMENT	AJZ
0	03/06/25	100% FINAL CD	AJZ

APPROVED FOR CONSTRUCTION



IT IS A VIOLATION OF LAW FOR ANY PERSON, UNLESS THEY ARE ACTING UNDER THE DIRECTION OF A LICENSED PROFESSIONAL ENGINEER,

SITE NAME **CO1 CATAMOUNT**

31800 CR 14C STEAMBOAT SPRINGS, CO 80487

5G L-SUB6 - CARRIER ADD (EXISTING COMMUNICATIONS SITE)

TITLE SHEET

T-1

GENERAL PROJECT NOTES

- CONTRACTOR IS RESPONSIBLE FOR ERECTING TEMPORARY BARRICADES AND/OR FENCING TO PROTECT THE SAFETY OF THE PUBLIC DURING CONSTRUCTION. THE CONTRACTOR SHALL REMOVE ALL TEMPORARY BARRIERS AND REPAIR ALL DAMAGE TO PROPERTY ON THE SITE CAUSED BY THIS CONSTRUCTION. THE COST OF REPAIR IS THE CONTRACTOR'S RESPONSIBILITY.
- 2. ALL WORK SHALL BE IN ACCORDANCE WITH APPLICABLE LOCAL, STATE, AND FEDERAL REQUIREMENTS
- 3. THE CONTRACTOR SHALL BE RESPONSIBLE FOR VERIFICATION OF ALL MEASUREMENTS AT THE SITE PRIOR TO ORDERING ANY MATERIALS OR CONDUCTING ANY WORK.
- 4. EXCESS SOIL MATERIAL AND DEBRIS CAUSED BY THIS CONSTRUCTION SHALL BE REMOVED FROM THE SITE AND DISPOSED OF IN A LEGAL MANNER.
- CONTRACTOR SHALL MAKE ADJUSTMENTS TO GRADING ELEVATIONS AS NECESSARY TO ENSURE A SITE FREE OF DRAINAGE PROBLEMS.
- 6. CONTRACTOR SHALL COORDINATE A CONSTRUCTION LAYDOWN AREA WITH THE PROPERTY OWNER. CONSTRUCTION LAYDOWN AREA SHALL BE FENCED-IN WITH TEMPORARY (45 DAY) CONSTRUCTION FENCE. THE TEMPORARY FENCE SHALL BE CONSTRUCTED OF 6' HIGH CHAIN LINK FABRIC AND IS TO BE REMOVED AT THE END OF CONSTRUCTION. LAYDOWN AREA IS TO BE RESTORED TO ITS ORIGINAL CONDITION AFTER FENCE REMOVAL.
- 7. SURVEY INFORMATION SHOWN WAS CREATED FROM RECORD INFORMATION AND DOES NOT CONSTITUTE A LEGAL BOUNDARY SURVEY.
- THESE PLANS DO NOT ADDRESS THE SAFETY AND STABILITY OF THE STRUCTURE DURING ASSEMBLY AND ERECTION, WHICH ARE THE RESPONSIBILITY OF THE ERECTOR, BASED ON THE MEANS AND METHODS CHOSEN BY THE ERECTOR.

GENERAL CONTRACTOR NOTES

- THE CONTRACTOR SHALL BE RESPONSIBLE FOR THE COMPLETE PROJECT SCOPE OF WORK DEFINED UNDER THE REQUEST FOR PROPOSAL (RFP) FOR THIS PROJECT AND ALL ASSOCIATED ATTACHMENTS AND DOCUMENTS PROVIDED. THE RFP AND ALL ASSOCIATED DOCUMENTS SHALL DEFINE THE COMPLETE PROJECT SCOPE OF WORK. CONTRACTOR SHALL BE RESPONSIBLE FOR COMPLIANCE WITH ALL DOCUMENTS AND IS SOLELY RESPONSIBLE FOR ALL WORK. ALL DOCUMENTS INCLUDED WITHIN THE PROJECT REQUEST FOR PROPOSAL ARE REQUIRED FOR THE COMPLETE PROJECT SCOPE O WORK. THE CONTRACTOR SHALL BE RESPONSIBLE FOR ALL WORK (EQUIPMENT, MATERIAL, INSTALLATION, TESTING, ETC.) INDICATED IN ALL DOCUMENTS. THE RFP, VERIZON NETWORK STANDARDS AND PROJECT ADDENDUMS AND CLARIFICATIONS ARE COMPLEMENTARY TO EACH OTHER. THE FORMAT OF THE SPECIFICATIONS AND DRAWING NUMBERING PER DISCIPLINE IS NOT Intended to Imply segregation of Sub Contractor Work, Contractor Shall assign all SUB CONTRACTOR WORK AND VERIZON WILL NOT ACCEPT ANY CHANGE ORDERS FOR INTERNAL CONTRACTOR WORK ASSIGNMENTS. CONTRACTOR SHALL BE RESPONSIBLE FOR DISTRIBUTING ALL RFF DOCUMENTS TO THEIR SUB CONTRACTORS. ALL RFP DOCUMENTS ARE REQUIRED TO INDICATE THE PROJECT SCOPE OF WORK. PARTIAL SUB CONTRACTOR DOCUMENT PACKAGES ARE HIGHLY DISCOURAGED. IN THE EVENT OF A CONFLICT BETWEEN THE DRAWINGS, SPECIFICATIONS, REFERENCED STANDARDS, VERIZON STANDARDS, OR AGREEMENT TERMS AND CONDITIONS THE ARCHITECT/ ENGINEER SHALL BE CONTACTED FOR FORMAL INTERPRETATION OF THE REQUIREMENTS THE CONTRACTOR SHALL BE DEEMED TO HAVE PROVIDED THE DETAILED AND EXTENSIVE INTERPRETATION. ANY WORK INSTALLED IN CONFLICT WITH THE ARCHITECT/ ENGINEER INTERPRETATIONS SHALL BE CORRECTED BY THE CONTRACTOR AT NO EXPENSE TO VERIZON
- ALL ANTENNAS MUST BE PIM TESTED WITHIN 48 HOURS OF THEM BEING RECEIVED BY THE INSTALLATION CONTRACTOR. THOSE RESULTS MUST BE SENT BACK TO THE VERIZON CONSTRUCTION ENGINEER AND EQUIPMENT ENGINEER WITHIN THE SAME 48 HOURS. IF YOU MISS THE 48HR TIMELINE AND THE ANTENNAS DO NOT PASS UPON INSTALLATION, YOUR COMPANY WILL BE CHARGED FOR THE COST OF THE ANTENNAS FOR REPLACEMENT.
- 3. ALL LOADS MUST BE SECURED PROPERLY TO THE VEHICLE OR TRAILER. VERIZON WILL PASS ALONG THE COST OF ANY REPLACEMENTS DUE TO DAMAGE OR LOSS WHETHER IT IS NEW OR USED.
- 4. GENERAL CONTRACTORS & SUBCONTRACTORS SHALL VERIFY EXISTING CONDITIONS ON THE JOB SITE ALONG WITH ALL PLANS & DIMENSIONS. NOTIFY THE ENGINEER OF RECORD OF ANY DISCREPANCIES BEFORE PROCEEDING WITH THE WORK OR BE RESPONSIBLE FOR SAME.
- 5. DRAWINGS ARE TO SCALE WHEN PLOTTED ON 11"X17" SHEET. USE DIMENSIONS SHOWN DO NOT SCALE DRAWING. CONTACT RETHERFORD ENTERPRISES, INC. FOR FURTHER INFORMATION.
- 6. CALL BEFORE YOU DIG. COLORADO LAW REQUIRES 2 WORKING DAYS NOTICE FOR CONSTRUCTION PHASE. CALL 811 OR COLORADO811.ORG SEE THE EXCAVATOR HANDBOOK FOR MORE INFORMATION
- THESE DRAWINGS MAY NOT SHOW ALL UNDERGROUND/BUILDING PIPING & UTILITIES. THE CONTRACTO
 SHALL EXERCISE EXTREME CARE DURING ALL EXCAVATION & OTHER CONSTRUCTION ACTIVITIES.

ANTENNA. MOUNTS & HARDWARE INSTALLATION NOTES

- I. CONTRACTOR TO INSTALL ANTENNAS, MOUNTS AND TOWER HARDWARE PER MANUFACTURER'S RECOMMENDATIONS (OR AS REQUIRED BY THE OWNER/PROVIDER).
- 2. ALL BOLTS SHALL BE TIGHTENED PER AISC REQUIREMENTS.
- S. ANY GALVANIZED SURFACES THAT ARE DAMAGED BY ABRASIONS, CUTS, DRILLING OR FIELD WELDING DURING SHIPPING OR ERECTION SHALL BE TOUCHED-UP WITH TWO COATS OF COLD GALVANIZING COMPOUND MEETING THE REQUIREMENTS OF ASTM A780.
- 4. ANTENNA MOUNTS SHALL NOT BE USED AS A CLIMBING DEVICE. WORKERS SHALL ALWAYS TIE OFF TO AN APPROVED CLIMBING POINT.

MAIN OVP & RRH INSTALLATION NOTES

- 1. CONTRACTOR TO INSTALL MAIN OVP, REMOTE RADIO HEADS, TOWER MOUNTED AMPLIFIERS, AND/OR DIPLEXERS PER MANUFACTURER'S RECOMMENDATIONS.
- 2. ALL BOLTS SHALL BE TIGHTENED PER AISC REQUIREMENTS.
- 8. ANY GALVANIZED SURFACES THAT ARE DAMAGED BY ABRASIONS, CUTS, DRILLING OR FIELD WELDING DURING SHIPPING OR ERECTION SHALL BE TOUCHED-UP WITH TWO COATS OF COLD GALVANIZING COMPOUND MEETING THE REQUIREMENTS OF ASTM A780.

COAX PORT NOTES

- 1. REQUIRED ADDITIONAL COAX PORTS TO BE ADDED AS NEEDED BY CONTRACTOR.
- 2. ANY ADDITIONAL COAX PORTS TO BE INSTALLED BELOW THE EXISTING, WHERE POSSIBLE.
- 3. CONTRACTOR TO INVESTIGATE INTERIOR OF SHELTER/EQUIPMENT ROOM FOR CLEAREST PENETRATION POINT
- 4. ADDITIONAL COAX PORTS TO BE INSTALLED PER INDUSTRY STANDARDS.



2 VIEW OF EXISTING ALPHA SECTOR



3 VIEW OF EXISTING BETA SECTOR



VIEW OF EXISTING GAMMA SECTOR



VIEW OF EXISTING BUILDING (LOOKING NORTHEAST)





7093 SILVERHORN DRIVE EVERGREEN | CO | 80439 (720) 261-2064

REV	DATE	DESCRIPTION	CHK
1	03/26/25	REVISED PER COMMENT	AJZ
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SITE NAME
CO1 CATAMOUNT

31800 CR 14C STEAMBOAT SPRINGS, CO 80487


5G L-SUB6 - CARRIER ADD (EXISTING COMMUNICATIONS SITE)

SHEET TITL


GENERAL NOTES & SITE IMAGES

SHEET NUMBE

G-1

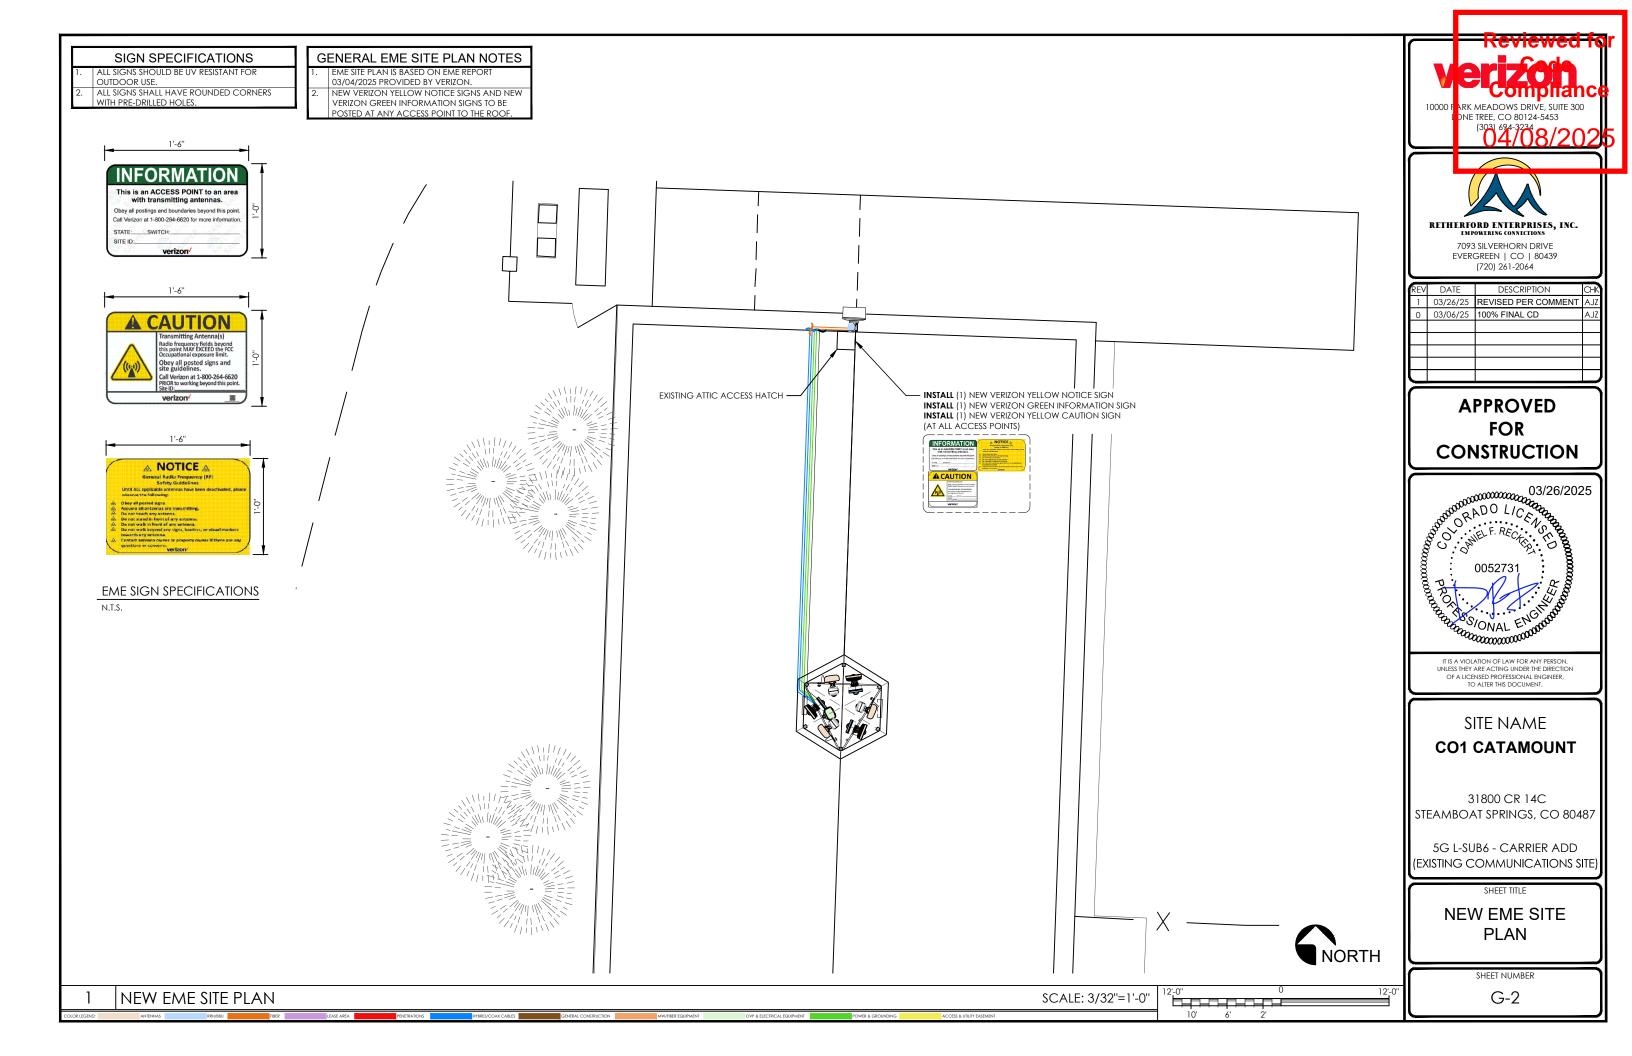

GENERAL SITE PLAN NOTES INFORMATION SHOWN BELOW FOR DEPICTION PURPOSES ONLY. ALL DATA GATHERED FROM PUBLIC RECORDS AND GENERATED FROM AERIAL IMAGES AND SITE VISITS, INFORMATION DOES NOT CONSTITUTE A LEGAL BOUNDARY SURVEY AND SHOULD NOT BE USED FOR SURVEYING OR OTHER RELATED PURPOSES. SITE PLAN DATA AS SHOWN IS BASED UPON A LIMITED SITE MAPPING OF THE SURROUNDING AREA AND ARCHIVED SURVEY DOCUMENTS. DATA AS SHOWN IS FOR REFERENCE ONLY. CONFIRMATION AND PROOF OF LEASE AREA AND/OR EASEMENTS IS BEYOND THE SCOPE OF THIS PROJECT. CARRIER CONTRACTORS SHALL BE RESPONSIBLE FOR PROTECTION OF ROOF SURFACE DURING CONSTRUCTION. PROPER ROOF PROTECTING MATERIALS SHALL BE PLACED AROUND ALL WORKING AREAS AND NO TOOLS, LADDERS, MATERIALS, OR EQUIPMENT SHALL BE PLACED DIRECTLY ON THE ROOF SURFACE. ANY DAMAGES TO ROOF SURFACE DURING CONSTRUCTION SHALL BE REPAIRED TO AS NEW

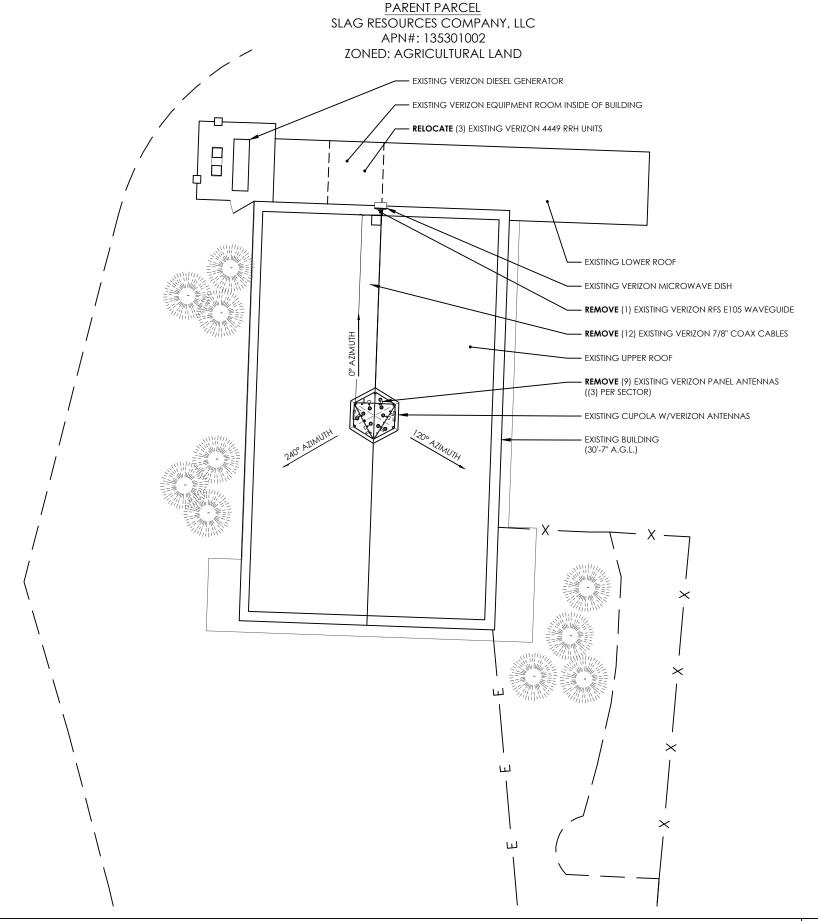





7093 SILVERHORN DRIVE

EVERGREEN | CO | 80439 (720) 261-2064

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31800 CR 14C STEAMBOAT SPRINGS, CO 80487

5G L-SUB6 - CARRIER ADD (EXISTING COMMUNICATIONS SITE)

SHEET TITL

EXISTING SITE PLAN

SHEET NUMBER

A-1

1 EXISTING SITE PLAN

SCALE: 1"=20'-0"

DLOR LEGEND:

RRH/BBU

SE AREA

HYBRID/C

RAL CONSTRUCTION

MW/FIBER EQUIPM


OVP & ELECTRICAL EQUIP

GROUNDING

ACCESS & UTILITY I

12' 4'

NORTH

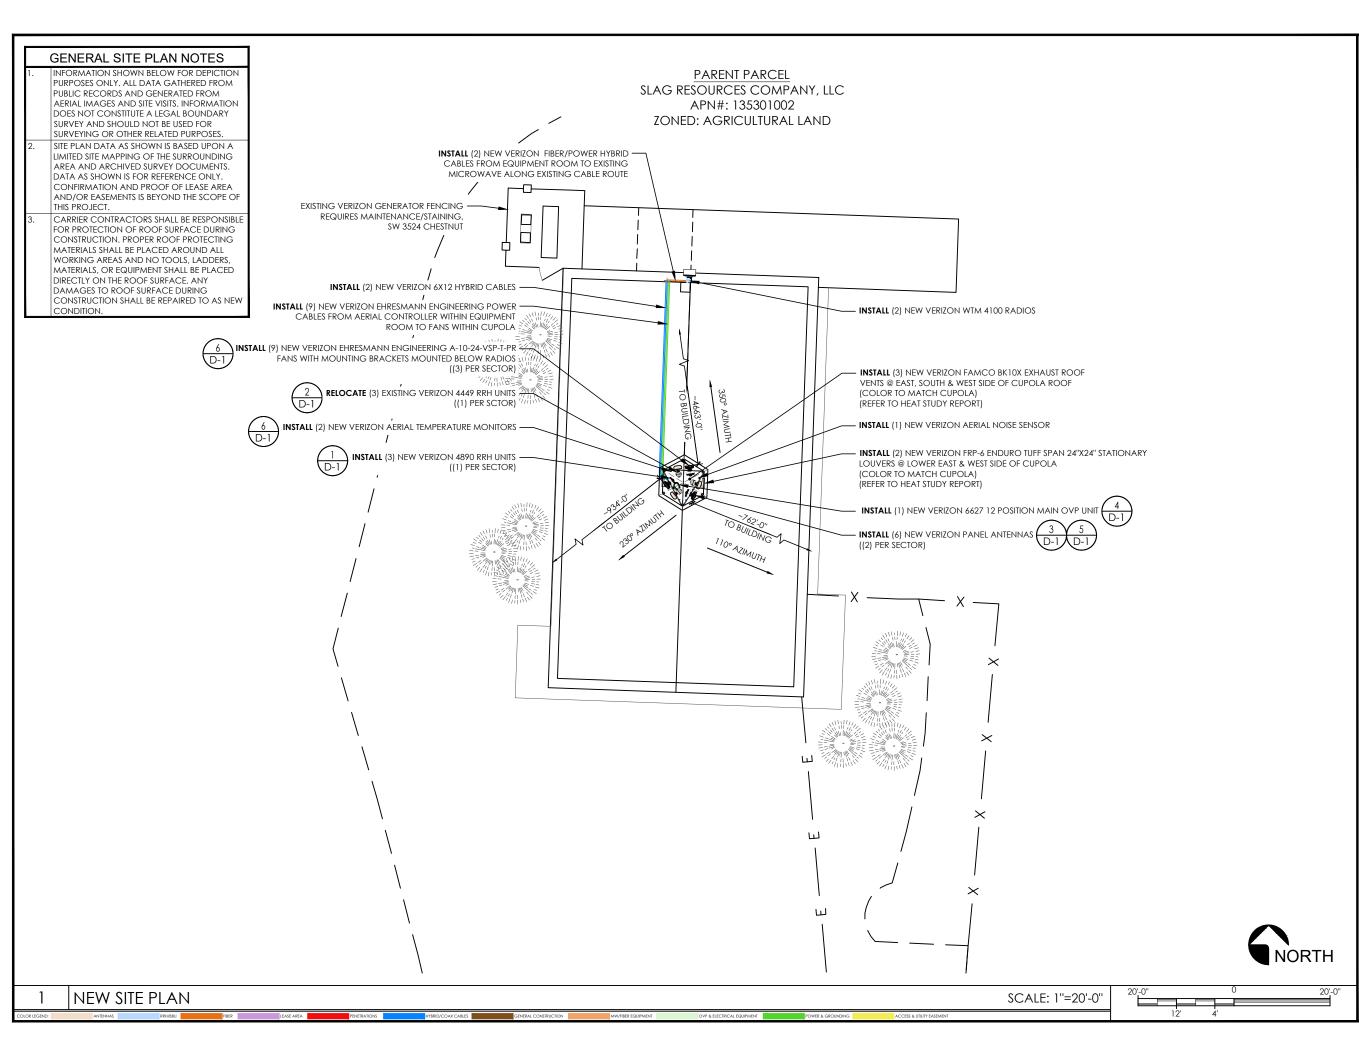

10000 FARK MEADOWS DRIVE, SUITE 300 DNE TREE, CO 80124-5453 (303) 694-3234 (304) 694-3234 (305) 694-324 (305) 694-32



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31800 CR 14C STEAMBOAT SPRINGS, CO 80487


5G L-SUB6 - CARRIER ADD (EXISTING COMMUNICATIONS SITE)

SHEET TITL

NEW SITE PLAN

Sheet number

A-2

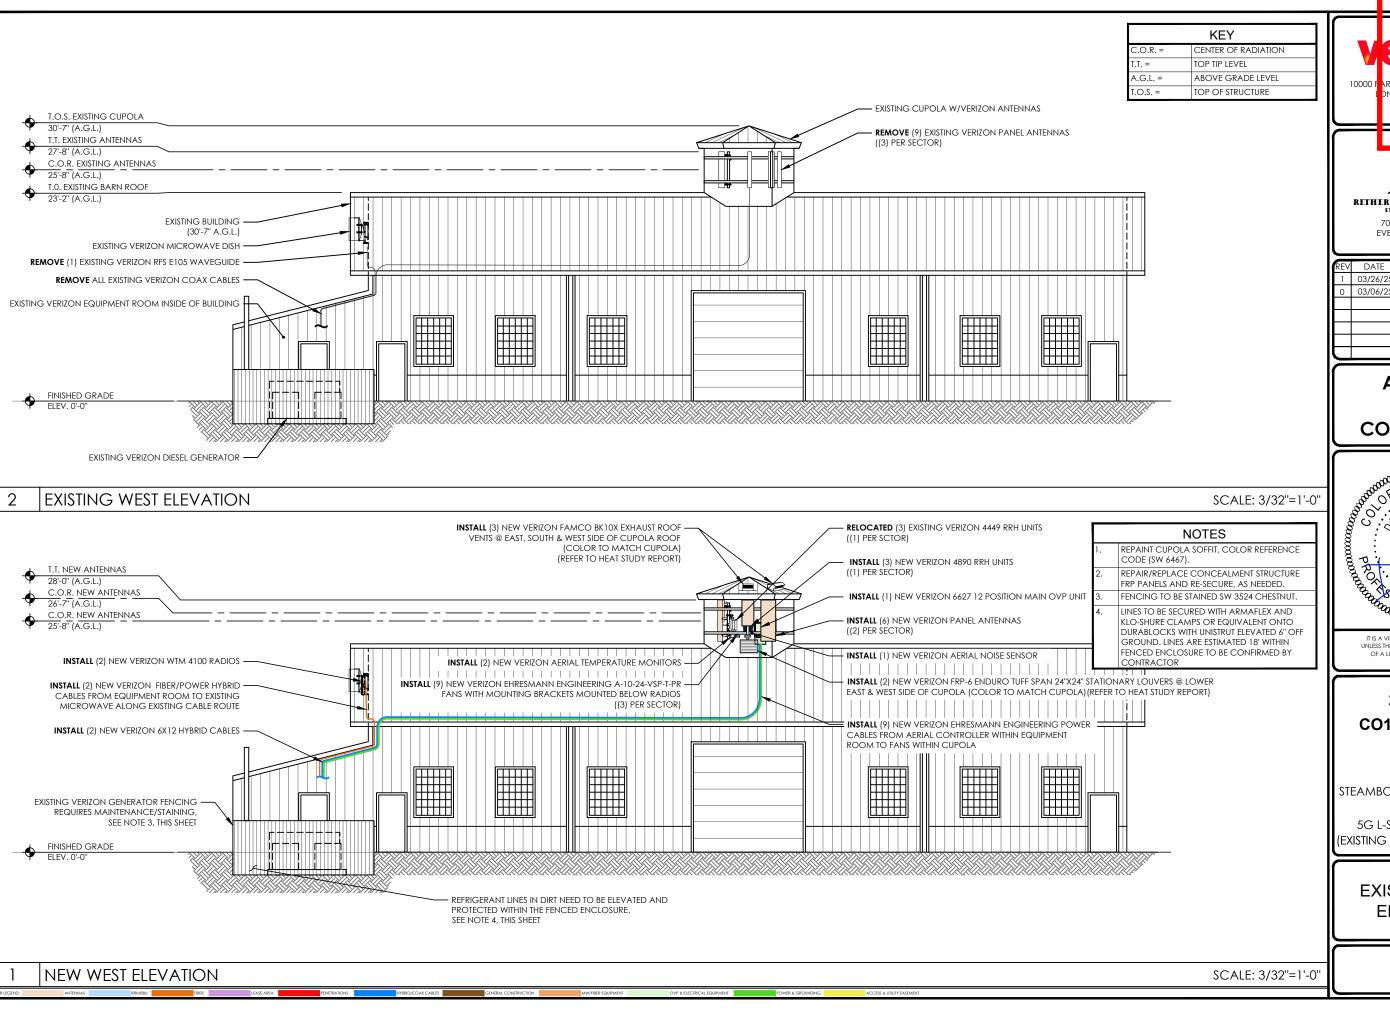


Compilanc ARK MEADOWS DRIVE, SUITE 300 DNE TREE, CO 80124-5453



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5G L-SUB6 - CARRIER ADD (EXISTING COMMUNICATIONS SITE)

EXISTING & NEW ELEVATIONS

SHEET NUMBER

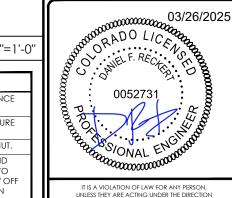A-3



NOTE

TO BE REMOVED AND DISPOSED OF IN A LEGAL



10'-11" (INTERIOR)


10












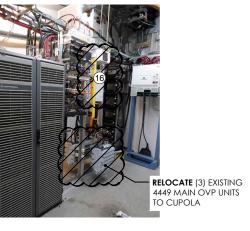


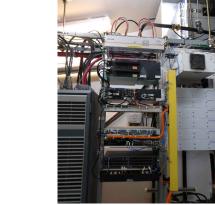

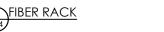

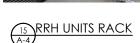



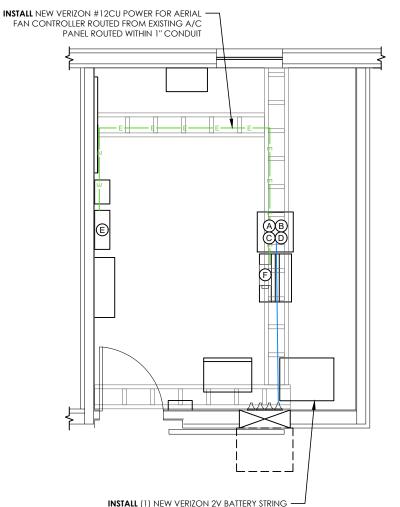



KEYED NOTES

(4) DC POWER DISTRIBUTION CENTER 5 TEMPERATURE CONTROL (6) AUTOMATIC TRANSFER SWITCH

(1) REMOVE (2) MOTOROLA CABINETS

(3) 4449 RRH UNITS (RELOCATE)

B INSTALL (1) NEW 6651 BBU UNIT

(1) NEW CTR-8740 ROUTER

A/C PANEL FOR AERIAL FAN

INSTALL (1) NEW AERIAL FAN

CONTROLLER

CONTROLLER

MANUFACTURER DEKA

TYPE

MODEL

NOMINAL VOLTAGE NOMINAL

CAPACITY STRING

MANUFACTURER GE

MANUFACTURER GE

MODEL

MODEL

(1) NEW 4520 MAIN OVP UNIT

INSTALL (1) NEW 5 AMP BREAKER TO

BATTERY SPECIFICATIONS (8) EXISTING BATTERIES

UNIGY I

2 STRINGS **RECTIFIER SPECIFICATIONS** (6) EXISTING RECTIFIERS

NEO50AC48ATEZ

CONVERTER SPECIFICATIONS (3) EXISTING CONVERTERS

NE075DC24A

12AVR170ET

170Ah (8Hr) TO 1.75 VPC

(17) REMOVE IRU RADIOS AND INUE SHELF (1) NEW UPCONVERTER

(1) ACCESS DOOR BATTERY RACK

(3) COAX PORT

7 ELECTRICAL PANEL

(10) COMPRESSOR

12 FIBER RACK

(14) AMPLINK RACK

(16) **REMOVE** FILTERS

(1) 6630 BBU UNIT

13

8 JBOX 9 TELCO BOARD



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03/06/25 100% FINAL CD



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SITE NAME **CO1 CATAMOUNT**

31800 CR 14C STEAMBOAT SPRINGS, CO 80487

5G L-SUB6 - CARRIER ADD (EXISTING COMMUNICATIONS SITE)

EXISTING & NEW EQUIPMENT PLANS

SHEET NUMBER

A-4



2


INSTALL (1) NEW VERIZON 2V BATTERY STRING -WITHIN EXISTING RACK

NEW EQUIPMENT PLAN SCALE: 1/4"=1'-0"


EXISTING EQUIPMENT PLAN

EXISTING CABLE ENCLOSURE TO CUPOLA ABOVE

JMA MX12 FIT 4/6/8 65 per sector

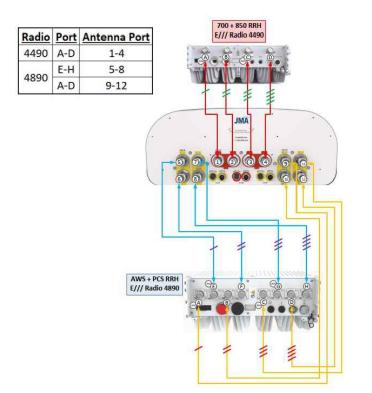

FROM	(RRH) TO (ANTENI	(2AL		
	SECTOR	CABLE/COAX SIZE (NOMINAL)	CABLE/COAX (QUANTITY)	ESTIMATED CABLE/COA LENGTH
antenna jumpers	ALPHA	½"Ø	12	15' PRE-MAD JUMPERS
TENN,	BETA	½"Ø	12	15' PRE-MAD JUMPERS
¥	GAMMA	½"Ø	12	15' PRE-MAD JUMPERS
FROM	(MAIN OVP) TO (F	RRH)		
	SECTOR	CABLE/COAX SIZE (NOMINAL)	CABLE/COAX (QUANTITY)	ESTIMATED CABLE/COA LENGTH
RRH JUMPERS	ALPHA	HYB 2X1Y	2	15'
JMF	ALITIA	HYB 1X3	1	15'
Η	BETA -	HYB 2X1Y	2	15'
RR	DEIA	HYB 1X3	1	15'
	GAMMA	HYB 2X1Y	2	15'
	GAMINIA	HYB 1X3	1	15'
FROM	(MAIN OVP) TO (I	MAIN OVP)		
MAIN TRUNK	SECTOR	CABLE/COAX SIZE (NOMINAL)	CABLE/COAX (QUANTITY)	ESTIMATED CABLE/COA LENGTH
≥∺	ALPHA, BETA & GAMMA	HYB 6X12	2	~100'
		HYBRID CABLE	ELENGTHS	
FRON	(MW RACK) TO (V	VTM 4100 RADIOS)		
MAIN TRUNK	MFG/MODEL	CABLE/COAX	CABLE/COAX (QUANTITY)	ESTIMATED CABLE/COA LENGTH
MAII	BIZLINK 037-579832-XXX	HYB FIBER/POWER	2	~35'
		POWER CABLE	E LENGTHS	
FRON	(AERIAL CONTRO	LLER) TO (AXIAL FANS)		
POWER CABLE	MFG/MODEL	CABLE/COAX	CABLE/COAX (QUANTITY)	ESTIMATED CABLE/COA LENGTH
50	EHRESMANN PROVIDED	POWER	9	100'

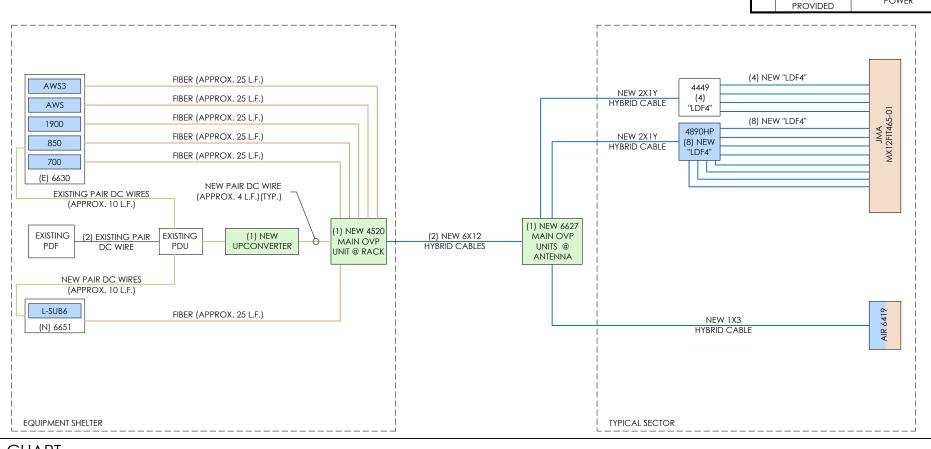

Compliance ARK MEADOWS DRIVE, SUITE 300 DNE TREE, CO 80124-5453



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0	03/06/25	100% FINAL CD	AJZ

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SITE NAME **CO1 CATAMOUNT**

31800 CR 14C STEAMBOAT SPRINGS, CO 80487

5G L-SUB6 - CARRIER ADD (EXISTING COMMUNICATIONS SITE)

NEW CABLE CHART & DIAGRAM


SHEET NUMBER

A-5

CABLE DIAGRAM & CHART

EXISTING ANTENNA SCHEDULE (QUANTITY) SIZE C.O.R. AZIMUTH QUANTITY ANTENNA MAKE/MODEL MOUNT TYPE NOTES (NOMINAL) AMPHENOL BXA-70080-4CF REMOVE 4' PANEL ANTENNA 25'-8" 0° AMPHENOL LPD-7905/4 REMOVE 4' PANEL ANTENNA REMOVE AMPHENOL BXA-70080-4CF REMOVE (12)4' PANEL ANTENNA 25'-8" 120° EXISTING PIPE MOUNTS AMPHENOL LPD-7905/4 7/8" COAX REMOVE CABLES AMPHENOL BXA-70080-4CF REMOVE 4' PANEL ANTENNA 25'-8" 240° AMPHENOL LPD-7905/4 4' PANEL ANTENNA REMOVE

- ALL EXISTING AZIMUTHS REFERENCE TRUE NORTH.
- ALL EXISTING AZIMUTHS ARE APPROXIMATE AND BASED ON THE RFDS PROVIDED BY VERIZON.
- ALL EXISTING AZIMUTHS REFERENCE DATA COLLECTED FROM A RECENT SITE VISIT AND DIFFERS FROM THE INFORMATION

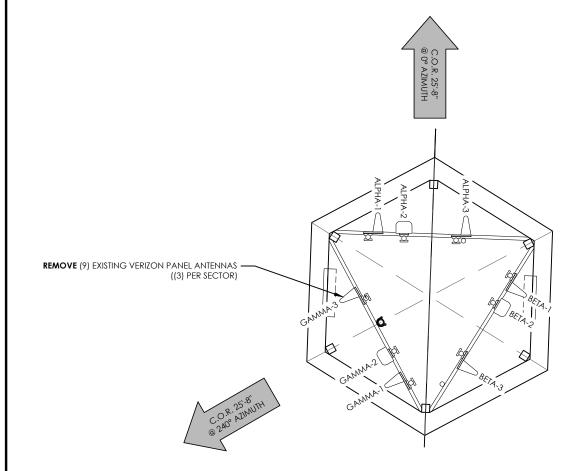



NOTICE

CONTRACTOR SHALL NOT SUBMIT BIDS OR PERFORM CONSTRUCTION WORK ON THIS PROJECT WITHOUT ACCESS TO THE CURRENT COMPLETE SET OF DRAWINGS LISTED IN THE TITLE-SHEET INDEX.





7093 SILVERHORN DRIVE EVERGREEN | CO | 80439 (720) 261-2064

REV	DATE	DESCRIPTION	CHR
1	03/26/25	REVISED PER COMMENT	AJZ
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SITE NAME **CO1 CATAMOUNT**


31800 CR 14C STEAMBOAT SPRINGS, CO 80487

5G L-SUB6 - CARRIER ADD (EXISTING COMMUNICATIONS SITE)

EXISTING ANTENNA SECTOR PLANS

SHEET NUMBER


A-6

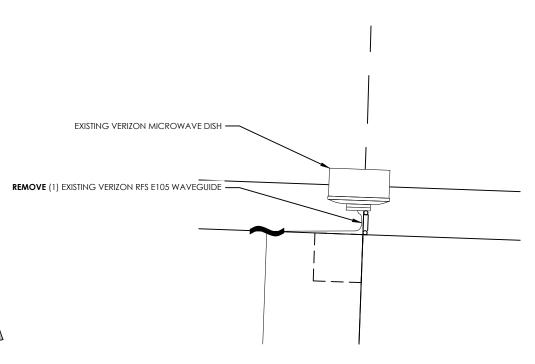

EXISTING ANTENNA PLANS @ 34'-0" (ALPHA & GAMMA) @ 46'-0" (BETA)

SCALE: 1/8" = 1'-0"

				NEW ANTENN	IA SCHEDUL	.E				
	C.O.R.	AZIMUTH	QUANTITY	ANTENNA MAKE/MODEL	MOUNT TYPE	COAX (QUANTITY) SIZE (NOMINAL)	ESTIMATED COAX CABLE LENGTH	MECHANICAL DOWNTILT		
ALPHA	26'-7"	- 350°	1 (NEW)	ERICSSON AIR 6419 2'-10.5" ANTENNA/RADIO						
ALP	25'-8"	350	1 (NEW)	JMA MX12FIT465-01 4'-7" PANEL ANTENNA						
	26'-7"	1100	1 (NEW)	ERICSSON AIR 6419 2'-10.5" ANTENNA/RADIO	SEE ANTENNA	(2) 6X12 HYBRID	SEE SHEET A-5 FOR	REFER TO		
BETA	25'-8"	- 110°	1 (NEW)	JMA MX12FIT465-01 4'-7" PANEL ANTENNA	MOUNT SCHEDULE	CABLES (NEW)	COAX DESIGN	RFDS		
IMA	26'-7"	0000	1 (NEW)	ERICSSON AIR 6419 2'-10.5" ANTENNA/RADIO	1					
GAMMA	25'-8"	230°	1 (NEW)	JMA MX12FIT465-01 4'-7" PANEL ANTENNA						
NOTE	<u>S:</u>					•	•			

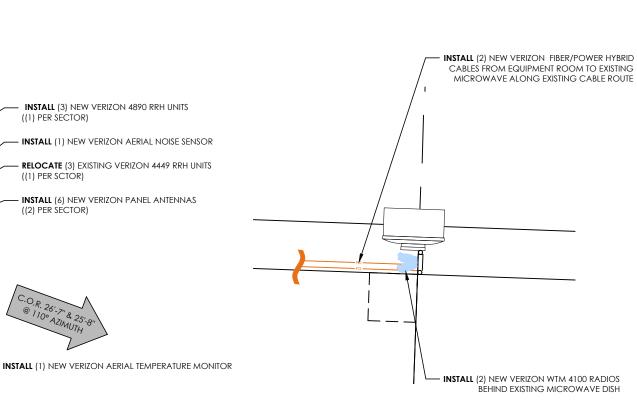

ALL AZIMUTHS REFERENCE TRUE NORTH. CONSULT REQUIRED QUADRANGLE MAP FOR NECESSARY

NOTICE CONTRACTOR SHALL NOT SUBMIT BIDS OR PERFORM CONSTRUCTION WORK ON THIS PROJECT WITHOUT ACCESS TO THE CURRENT COMPLETE SET OF DRAWINGS LISTED IN THE TITLE-SHEET INDEX. **GROUNDING NOTE** ALL NEW EQUIPMENT & COAX TO BE GROUNDED PER VERIZON GROUNDING SPECS **GENERAL ANTENNA NOTES** CONTRACTOR TO VERIFY MECHANICAL DOWNTILT WITH FINAL RFDS/RF ENGINEER. DUAL POLAR ANTENNAS REQUIRE TWO RUNS OF COAX PER ANTENNA. CONTRACTOR TO VERIFY ALL ACTUAL LENGTHS IN FIELD PRIOR TO INSTALLATION AND NOTIFY THE FIELD ENGINEER FOR VERIFICATION OF SIZES OF CABLES. CONTRACTOR TO PROVIDE AS BUILT FOR THE LENGTH OF CABLES UPON COMPLETION OF INSTALLATION. CONTRACTOR TO PROVIDE FINAL CABLE LENGTHS AND RETURN LOSSES FOR ALL CABLES.

ARK MEADOWS DRIVE, SUITE 300 DNE TREE, CO 80124-5453

DESCRIPTION DATE 03/26/25 REVISED PER COMMENT 03/06/25 100% FINAL CD

7093 SILVERHORN DRIVE EVERGREEN | CO | 80439 (720) 261-2064

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SITE NAME **CO1 CATAMOUNT**

31800 CR 14C STEAMBOAT SPRINGS, CO 80487

5G L-SUB6 - CARRIER ADD (EXISTING COMMUNICATIONS SITE)

NEW ANTENNA SECTOR PLANS

SHEET NUMBER

A-7

NORTH

NEW ANTENNA PLAN @ 26'-7" & 25'-8"

INSTALL (1) NEW VERIZON AERIAL TEMPERATURE MONITOR -

INSTALL (3) NEW VERIZON FAMCO BK10X EXHAUST ROOF -VENTS @ EAST, SOUTH & WEST SIDE OF CUPOLA ROOF

INSTALL (2) NEW VERIZON FRP-6 ENDURO TUFF SPAN 24"X24" -STATIONARY LOUVERS @ LOWER EAST & WEST SIDE OF CUPOLA (COLOR TO MATCH CUPOLA)

INSTALL (1) NEW VERIZON 6627 12 POSITION MAIN OVP UNIT -

INSTALL (9) NEW VERIZON EHRESMANN ENGINEERING A-10-24-VSP-T-PR -FANS WITH MOUNTING BRACKETS MOUNTED BELOW RADIOS

(COLOR TO MATCH CUPOLA)

((3) PER SECTOR)

(REFER TO HEAT STUDY REPORT)

(REFER TO HEAT STUDY REPORT)


SCALE: 1/4" = 1'-0"

INSTALL (3) NEW VERIZON 4890 RRH UNITS

INSTALL (6) NEW VERIZON PANEL ANTENNAS

((1) PER SECTOR)

((1) PER SCTOR)

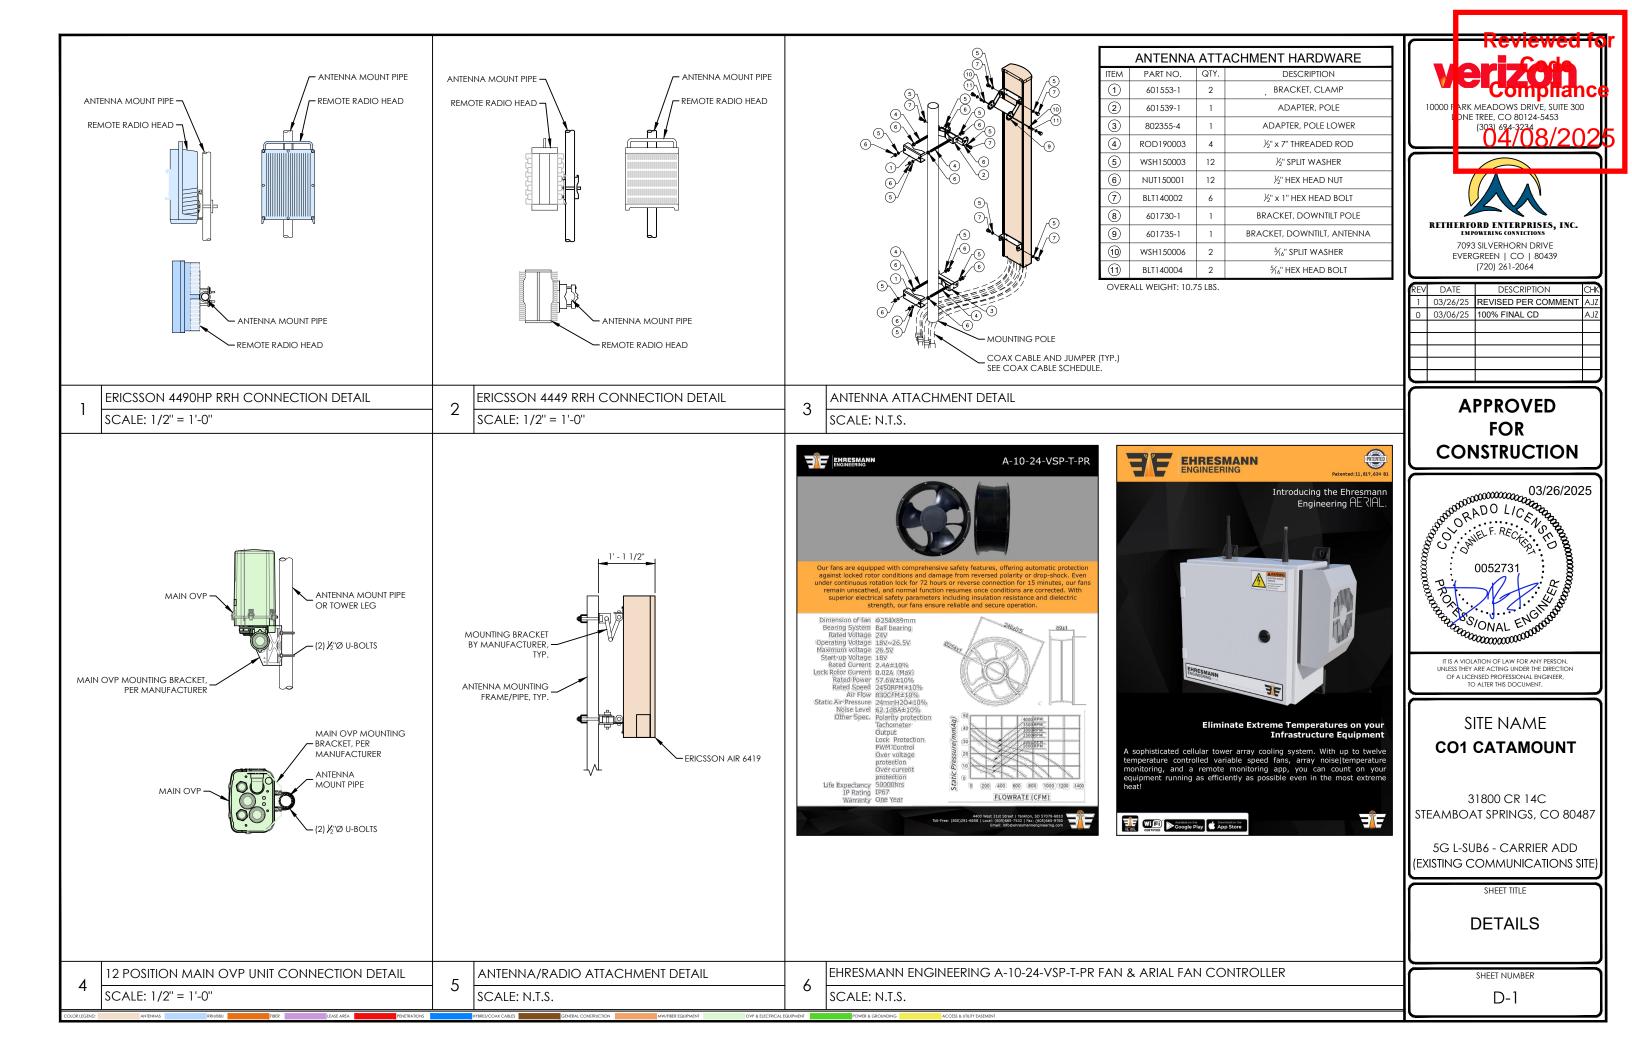



NWAV™ X-Pol 12-Port Antenna

X-Pol 12-Port 4 ft, 65° Form In Tighter, with Smart Bias Ts, 698-2690 MHz: 4 ports 698-894 MHz, 8 ports 1695-2690 MHz

- 12-Port antenna offering the same functionality as 2 Hex Port antennas in a single unit
- Full mid band arrays for maximum gain
- Fully integrated (iRETs) with independent RET control for low band and mid band
- Excellent passive intermodulation (PIM) performance reduces harmful interference.
- SON-Ready array spacing supports beamforming capabilities.
- Suitable for 3G, 4G, and 5G interface technologies
- Integrated Smart Bias-Ts reduce leasing costs
- Optimized form factor for reduced wind loading



NAV

Electrical specification (minimum/maximum)	Ports 1	, 2, 3, 4		Ports 5, 6	, 7, 8, 9, 1	0, 11, 12	
Frequency bands, MHz	698- 806	806- 894	1695- 1880	1850- 1990	1920- 2180	2300- 2360	2496- 2690
Polarization	± 4	15°			± 45°		
Average gain over all tilts, dBi	12.9	13.3	16.6	16.8	17.1	17.2	17.3
Horizontal beamwidth (HBW), degrees ¹	70	67	66	64	62	60	58
Front-to-back ratio, co-polar power @180°± 30°, dB	>25.0	>25.0	>25.0	>25.0	>25.0	>25.0	>25.0
X-Pol discrimination (CPR) at boresight, dB	>20.0	>18.0	>19	>18	>18	>18	>18
Vertical beamwidth (VBW), degrees ¹	17.5	16.0	7.8	7.1	6.9	6.7	6.5
Electrical downtilt (EDT) range, degrees	2-16 0-9						
First upper side lobe (USLS) suppression, dB ¹	≤-15.0	≤-15.0	≤-16.0	≤-16.0	≤-16.0	≤-16.0	≤-16.0
Cross-polar isolation, port-to-port, dB ¹	25	25	25	25	25	25	25
Max VSWR / return loss, dB	1.5:1	1.5:1 / -14.0 1.5:1 / -14.0					
Max passive intermodulation (PIM), 2x20W carrier, dBc	-153 -153						
Max input power per any port, watts	300 250						
Total composite power all ports, watts				1500			

¹ Typical value over frequency and tilt

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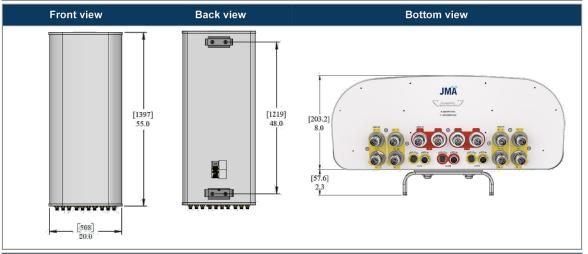
01/02/24 V6.0 Page1

JMA

MX12FIT465-01

NWAV™ X-Pol 12-Port Antenna

Mechanical specifications	
Dimensions height/width/depth, inches (mm)	55/ 20.0/ 8.0 (1397/ 508.0/ 203.2)
Shipping dimensions length/width/height, inches (mm)	60/ 26/ 15 (1524/ 600/ 381)
No. of RF input ports, connector type, and location	12 x 4.3-10 female, bottom
RF connector torque	96 lbf·in (10.85 N·m or 8 lbf·ft)
Net antenna weight, lb (kg)	49 (22.2)
Shipping weight, lb (kg)	90.2 (40.9)
Antenna mounting and downtilt kit included with antenna	91900318
Net weight of the mounting and downtilt kit, lb (kg)	18 (8.2)
Range of mechanical up/down tilt	-2° to 12°
Rated wind survival speed, mph (km/h)	150 (241)
Frontal and lateral wind loading @ 150 km/h, lbf (N)	98.7 (439.0), 45.7 (203.3)
EPA frontal and lateral, ft ² , (m ²)	4.4 (0.41), 2.1 (0.20)



Ordering information							
Antenna model	Description						
MX12FIT465-01	4F X- Pol 12 PORT FIT 65° 2-16°/ 0-9° RET, 4.3-10 & SBT						
Optional accessories							
AISG cables	M/F cables for AISG connections						
PCU-1000 RET controller	Stand-alone controller for RET control and configurations						
91900314-02	Dual Mount Bracket (see 91900314 bracket document for details)						

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01/02/24 V6.0 Page 2 Reviewed is

VELZOFI
Compliance

10000 FARK MEADOWS DRIVE, SUITE 300
DNE TREE, CO 80124-5453



7093 SILVERHORN DRIVE EVERGREEN | CO | 80439 (720) 261-2064

I۷	DATE	DESCRIPTION	CHK
1	03/26/25	REVISED PER COMMENT	AJZ
)	03/06/25	100% FINAL CD	AJZ

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SITE NAME

CO1 CATAMOUNT

31800 CR 14C STEAMBOAT SPRINGS, CO 80487

5G L-SUB6 - CARRIER ADD (EXISTING COMMUNICATIONS SITE)

SHEET TITL

ANTENNA SPECIFICATIONS

SHEET NUMBER

D-2

ANTENNA SPECIFICATIONS

R LEGEND:

RRH/

RRH/BBU

LEASE ARE

PEN

HYBRID/CO

GENERAL CONSTRUCTION

IW/EIRED EOLIIDMENT

OVD & ELECTRICAL EQUIRAGAN

VER & GROUNDING

ACCESS & UTILITY EASE



AIR 6419 B41



AIR 6419, an Advanced Antenna System (AAS) with 64 transmitters and 64 receivers, improves upon previous generations of product with respect to energy efficiency and deployment capabilities. An Advanced Antenna System (AAS) such as AIR 6419 together with the Massive MIMO and Multi-User MIMO software features enables greater spectral efficiency. Enhanced bitrate per user achieved through interference suppression by applying beamforming capabilities in the downlink and the uplink.

Capacity increased by scheduling users in the cell on different layers supporting both Single User MIMO (SU-MIMO) and Multiuser MIMO (MU-MIMO). Application coverage is improved through beamforming in both the vertical and horizontal dimensions.

To support cost efficient site deployments, AIR 6419 includes Layer 1 beamforming enabling enhanced

Common Public Radio Interface (eCPRI) to be used between the AIR 6419 and RAN Compute portfolio products. The increasing capacity demands in operator's networks create needs for new spectrum efficient solutions.

Like its predecessor AIR 6449, AIR 6419 supports different cell or broadcast beam shapes, to meet different user distribution scenarios. The flexibility to steer the transmitted energy for control signaling in both azimuth and elevation enables improved efficiency in various deployments scenarios including Macro, Hotspot and High-rise.

The improved design of AIR 6419 enables faster roll out with minimal site impact, improved mid-band coverage and capacity boost for both existing and new bands compared to the use of traditional radio and antenna systems.

TECHNICAL SPECIFICATIONS AIR 6419 B41

PRODUCT NUMBER: KRD 901 212/11

ADVANCED ANTENNA SYSTEM

3GPP Band 41, 2496 - 2690 MHz (full band) Operating frequency band:

Instantaneous bandwidth: 194 MHz Output Power 320 W EIRP max. 79 dBm Antenna configuration $(3x1) \times (4x8)$

64T64R connected to an array of dual polarized antenna elements. Architecture:

Modulation: Downlink Up to 256 QAM. Uplink Up to 64 QAM.

Multi-antenna beamforming

functionality*: Downlink SU-MIMO

> Downlink MU-MIMO Up to 16 layers per carrier.

Uplink SU-MIMO

Uplink MU-MIMO Up to 16 layers per carrier. Cell shaping

Pre-defined cell or broadcast beam shapes*:

Macro, Hotspot and High-rise.

Digital down-tilt Continuously adjustable for macro scenario, fixed for Hotspot and High-rise scenario.

Mechanical specifications*

Weight:

31 kg (68.5 lbs) excluding installation kit

876 x 506 x 203 mm (34.5" x 20.0" x 8.0") (including protrusions) Size $(H \times W \times D)$: 852 x 506 x 160 mm (33.6" x 20.0" x 6.3") (excluding protrusions)

Operational specifications*

Wind Load Maximum 653 N (front), 110 N (side) @ 42 m/s wind speed (pole installed)

- 40° to + 55° C Operating Temperature Range: Solar radiation: ≤ 1,120 W/m² 2% to 100% Relative humidity Absolute humidity: 0.26 to 40 g/m3 IP65

IP Classification:

Main Interfaces

Two eCPRI interfaces using 25G SFP+ ports with link capacity 25 Gb/s each. Baseband:

One 25 Gb/s eCPRI interface is sufficient for up to 100 MHz carrier bandwidth and 16 layers.

-48 V DC (3-wire or 2-wire) via a connector. Power Supply:

Maximum fuse rating is 50 A.

Optional mechanical tilt and swivel installation kit for wall and pole mounting. Mounting:

Handling: Handle for lifting and hoisting.

* Additional scenarios, cells or broadcast beam shapes possible with future software releases. Refer detailed description for more details on NR and EIRP for specific scenarios

Telefonaktiebolaget LM Ericsson SE-164 80 Stockholm, Sweden

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ark meadows drive, suite 300 DNE TREE, CO 80124-5453



7093 SILVERHORN DRIVE EVERGREEN | CO | 80439 (720) 261-2064

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REV	DATE	DESCRIPTION	CHR
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SITE NAME **CO1 CATAMOUNT**

31800 CR 14C STEAMBOAT SPRINGS, CO 80487

5G L-SUB6 - CARRIER ADD (EXISTING COMMUNICATIONS SITE)

ANTENNA SPECIFICATIONS

SHEET NUMBER

D-3



Radio 4890HP 48B2 48B66 S

- 8 RF ports, 4T8R per band (S for TX)
- B2: 4x60W
- B66: 4x60W
- Up to 480W in total RF power
- L, NR, NB-IoT
- 2x 2.5/4.9/9.8/10.1/24.3 Gbps CPRI/eCPRI

Radio 4890HP 48B2 48B66 S	Height	Width	Depth	Weight
wo protruding items	17.5 ln (444 mm)	15.2 In (384 mm)	7.0 In (176 mm)	~69.5 lbs
w protruding items	20.6 In (522 mm)	15.7 In (397 mm)	7.2 In (182 mm)	(~31.5 Kg)

- -48 VDC 2-wire (single DC-connector),
- AISG v3.0 TMA & RET support via RS-485 or RF connectors
- Type 4.3-10 RF + connectors
- 2 external alarm
- Convectional cooling
 - Optional fan for increased site flexibility
- IP 65, -40 to +55 $^{\circ}$ C

Pending Commercial Agreements





B2/B25 TX: 4 ports B66 TX: 4 ports B2/B25 & B66 RX: 8 ports



Same order as Radio 8843

Now confirmed max measurements/ will not exceed





7093 SILVERHORN DRIVE EVERGREEN | CO | 80439 (720) 261-2064

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SITE NAME

CO1 CATAMOUNT

31800 CR 14C STEAMBOAT SPRINGS, CO 80487


5G L-SUB6 - CARRIER ADD (EXISTING COMMUNICATIONS SITE)

SHEET TITL

RADIO SPECIFICATIONS

SHEET NUMBER

D-4

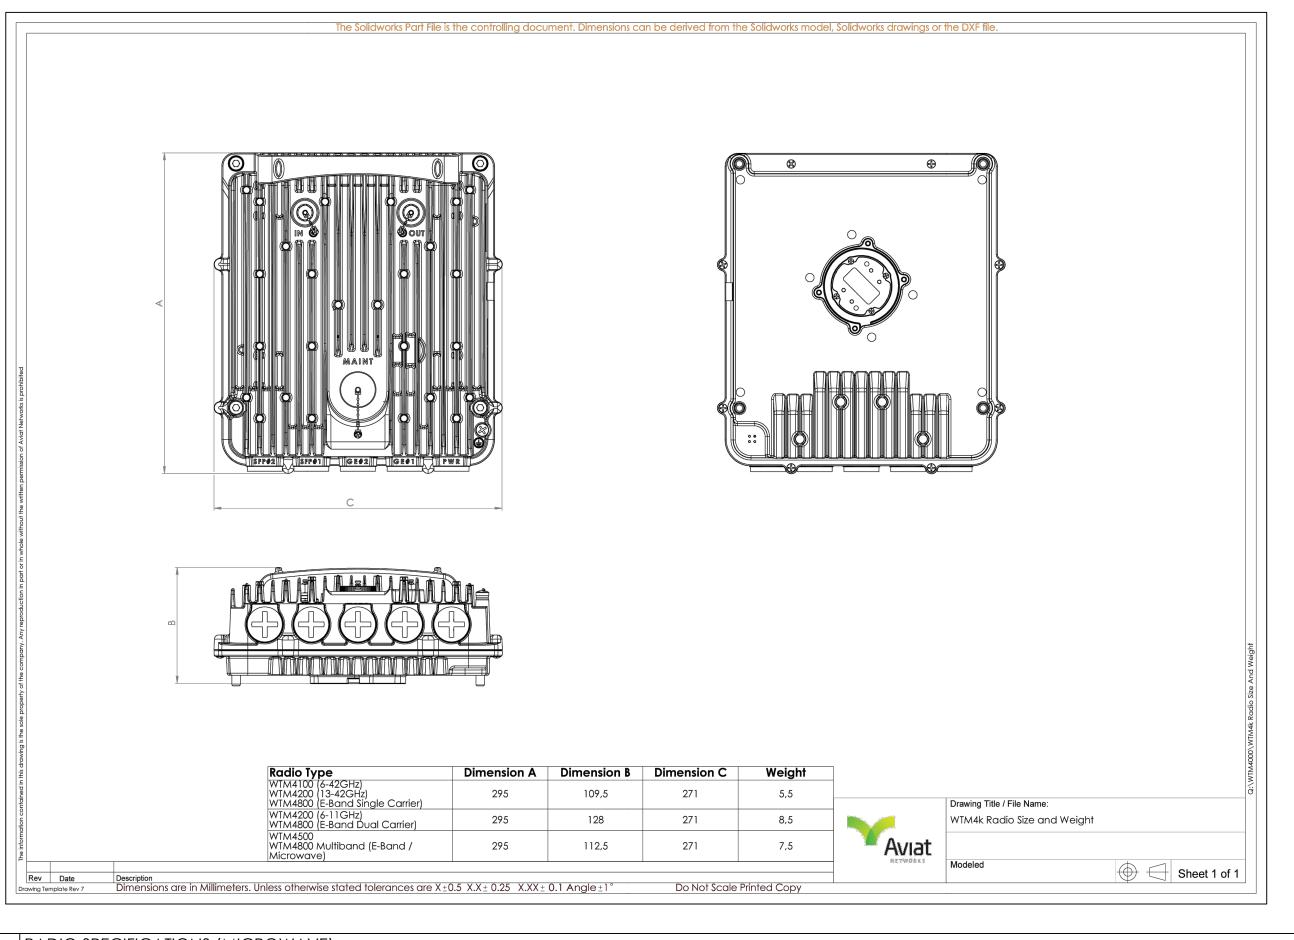

10000 F ARK MEADOWS DRIVE, SUITE 300
DNE TREE, CO 80124-5453
(303) 694-3734
0 44/08/2025



7093 SILVERHORN DRIVE

EVERGREEN | CO | 80439 (720) 261-2064

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SITE NAME CO1 CATAMOUNT


31800 CR 14C STEAMBOAT SPRINGS, CO 80487


5G L-SUB6 - CARRIER ADD (EXISTING COMMUNICATIONS SITE)


RADIO
SPECIFICATIONS
(MICROWAVE)

SHEET NUMBER

D-5

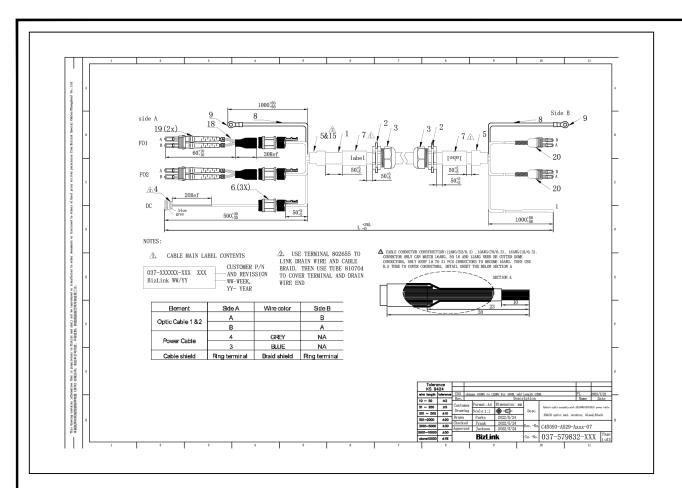

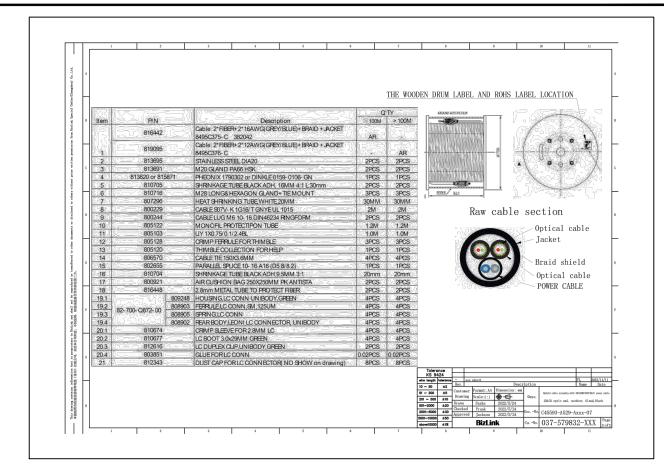

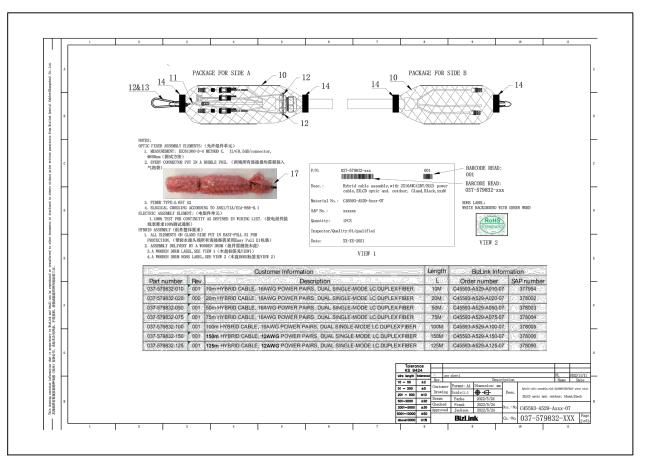

Compilance 10000 PARK MEADOWS DRIVE, SUITE 300 DNE TREE, CO 80124-5453 RETHERFORD ENTERPRISES, INC.

7093 SILVERHORN DRIVE EVERGREEN | CO | 80439 (720) 261-2064

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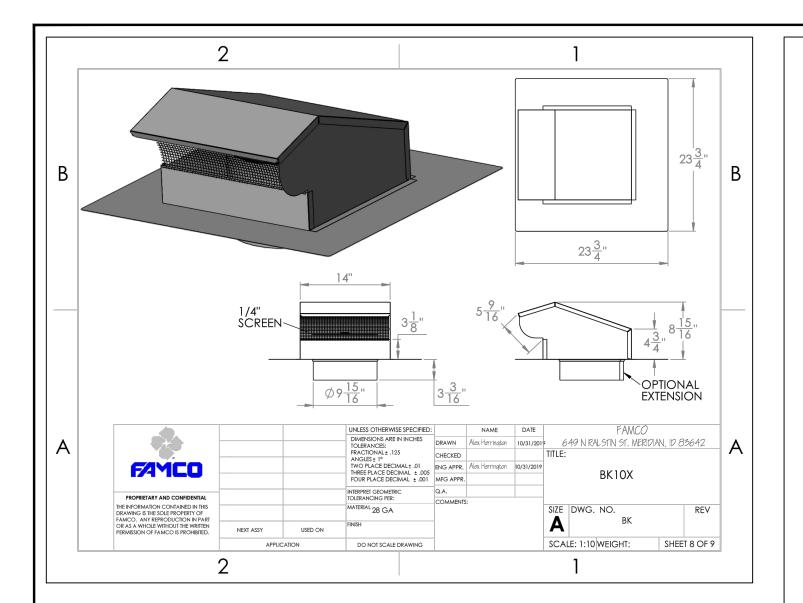
31800 CR 14C STEAMBOAT SPRINGS, CO 80487

5G L-SUB6 - CARRIER ADD (EXISTING COMMUNICATIONS SITE)

HYBRID CABLE SPECIFICATIONS (MICROWAVE)

D-6

HYBRID CABLE SPECIFICATIONS (MICROWAVE)



Tuff Span FRP Louvers

FRP-6 Stationary Louver


Louvers must be sized to

allow 1/8" gap between

outer edges of the unit(s)

and louver opening.


FRP-6 Adjustable Louver

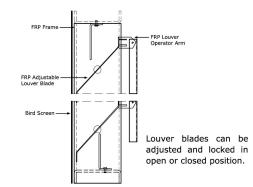

Free Area Guide in SF:

	24	30	36	42	48	54	60	66	72	78	84	90	
24	1.10	1.42	1.73	2.05	2.37	2.69	3.00	3.32	3.64	3.96	4.28	4.59	Т
30	1.65	2.12	2.60	3.08	3.55	4.03	4.51	4.98	5.46	5.94	6.41	6.89	Т
36	2.20	2.83	3.47	4.10	4.74	5.37	6.01	6.65	7.28	7.92	8.55	9.19	
42	2.75	3.54	4.34	5.13	5.92	6.72	7.51	8.31	9.10	9.90	10.69	11.48	Г
48	3.30	4.25	5.20	6.16	7.11	8.06	9.01	9.97	10.92	11.87	12.83	13.78	Г
54	3.85	4.96	6.07	7.18	8.29	9.41	10.52	11.63	12.74	13.85	14.97	16.08	Т
60	3.85	4.96	6.07	7.18	8.29	9.41	10.52	11.63	12.74	13.85	14.97	16.08	Т
66	4.39	5.67	6.94	8.21	9.48	10.75	12.02	13.29	14.56	15.83	17.10	18.37	Г
72	4.94	6.37	7.80	9.23	10.66	12.09	13.52	14.95	16.38	17.81	19.24	20.67	Г
78	5.49	7.08	8.67	10.26	11.85	13.44	15.02						Г
84	6.04	7.79	9.54	11.29	13.03	14.78	16.53						Г
90	6.59	8.50	10.40	12.31	14.22	16.12	18.03						Г
96	7.14	9.21	11.27	13.34	15.40	17.47	19.53						Т
102	7.14	9.21	11.27	13.34	15.40	17.47	19.53						Г
108	7.69	9.92	12.14	14.36	16.59	18.81	21.03						T
114	8.24	10.62	13.01	15.39	17.77	20.15	22.54						Г
120	8.79	11.33	13.87	16.41	18.96	21.50	24.04						Т

Free Air Velocity Chart

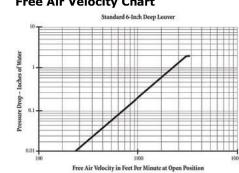

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RETHERFORD ENTERPRISES, INC. 7093 SILVERHORN DRIVE EVERGREEN | CO | 80439 (720) 261-2064

ARK MEADOWS DRIVE, SUITE 300

DNE TREE, CO 80124-5453

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SITE NAME CO1 CATAMOUNT

31800 CR 14C STEAMBOAT SPRINGS, CO 80487

5G L-SUB6 - CARRIER ADD (EXISTING COMMUNICATIONS SITE)

LOUVER & VENT DETAILS

SHEET NUMBER

D-7

LOUVER AND VENT DETAILS