






COLUMN SCHEDULE		
PLAN	TAG	DESCRIPTION
	C1	BUILT-UP (2) 2X6
	C2	BUILT-UP (3) 2X6
	C3	BUILT-UP @ 2 SMALL CORBEL POST
	C4	BUILT-UP @ CORNER 2 SMALL CORBEL POST
	C5	BUILT-UP @ CORNER 4 LARGE CORBEL POST
	C6	BUILT-UP @ BEAM POCKET POST

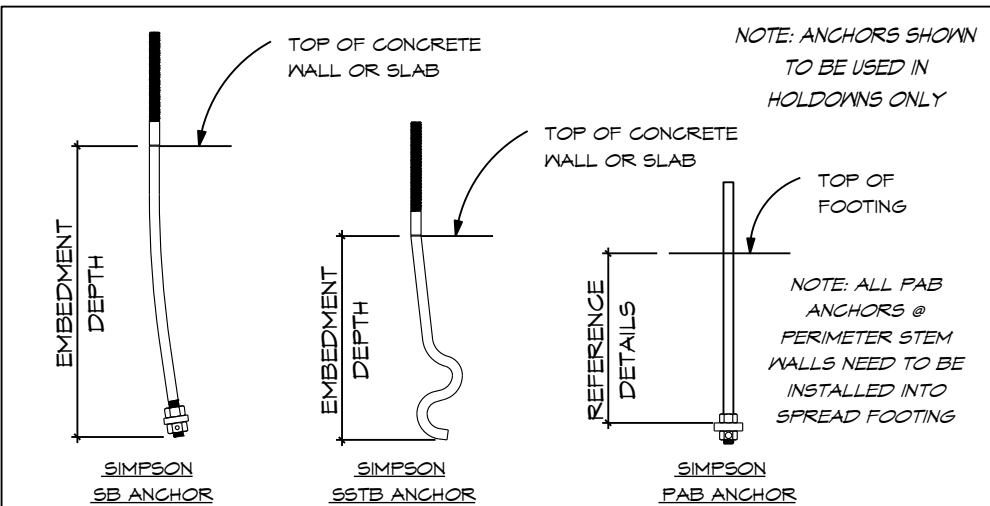

HOLD DOWN SCHEDULE		
HOLDOWN	ANCHOR BOLT / NAILS	MINIMUM WOOD MEMBER
HSTA, AND CMST STRAPS	PER MANUFACTURER'S SPECIFICATIONS	(2) 2x STUD
HDUB-SDS25	SB5/8X24 1/8" EMBED.	(2) 2x STUD
HDUB-SDS25	SB1/8X24 1/8" EMBED.	(3) 2x STUD
HDU11-SDS25	PAB9 1/11" EMBED.	(3) 2x STUD

NOTE: ALL ANCHOR BOLTS TO BE CAST IN PLACE  
REF. DETAILS ON S-106 FOR FOUNDATION  
SECTION DETAILS @ HOLDOWN LOCATIONS

NOTE: HOLDOWN ANCHOR BOLT LOCATIONS ON  
PLANS ARE APPROXIMATE ONLY. REFER TO  
FINAL HOLDOWN PLACEMENT PLAN PROVIDED BY  
DC STRUCTURES FOR FINAL DIMENSIONS AND  
LOCATIONS OF HOLDOWNS AND ANCHORS.

FOUNDATION SCHEDULE		
TYPE MARK	COUNT	TYPE
---	---	6" SLAB
F2.O	4	24"X24"X12"
F3.O	7	36"X36"X12"
F4.O	4	48"X48"X12"
P1	1	18"X10" CONT. FOOTING
P2	1	8" STEM WALL
P3	1	16"X12" CONT. FOOTING
F4	1	12"X12" GRADE BEAM
P5	1	6" STEM WALL
		REINFORCEMENT
		#3 @ 18" O.C. EACH WAY
		(3) #4 EACH WAY, BTM.
		(4) #4 EACH WAY, BTM.
		(6) #4 EACH WAY, BTM.
		(2) #4 CONT., BTM.
		#4 VERT. @ 24" O.C. & #4 HORIZ. @ 12" O.C.
		(2) #4 CONT., BTM.
		(2) #5 BARS, TOP & BTM.
		#4 VERT. @ 24" O.C. & #4 HORIZ. @ 12" O.C.

#### FRAMING LEGEND


	DENOTES POST ABOVE AND/OR CONTINUOUS BELOW
	DENOTES EXTERIOR WALL
	DENOTES INTERIOR WALL
	DENOTES BEARING WALL
	DENOTES BLOCKOUT IN FOUNDATION WALL
	DENOTES CONCRETE WALL
	DENOTES CONCRETE FOOTING
	DENOTES EXTERIOR CONCRETE SLABS

#### FOUNDATION PLAN GENERAL NOTES

NOTES APPLY TO SHEETS S-101 ONLY.

1. ITEMS LISTED ARE TO BE PROVIDED BY OTHERS, CONTACT OWNER FOR SPECIFICATIONS, DCS IS NOT RESPONSIBLE U.N.O.

-FOUNDATION: CONCRETE, ANCHOR BOLTS, FIBER MESH, WATER PROOF MEMBRANE, REBAR, INSULATION  
-ROOFING: ROOFING MATERIAL, MOISTURE BARRIER, VENTING, GUTTERS, FLASHING, NAILS, WATER PROOFING.  
-GENERAL: INSULATION, STONE MASONRY, NAILS & SCREWS, PLUMBING & FIXTURES, ELECTRICAL & FIXTURES,  
-MECHANICAL & FIXTURES, CASEWORK, FLOOR FINISH, WALL FINISH, & CEILING FINISH

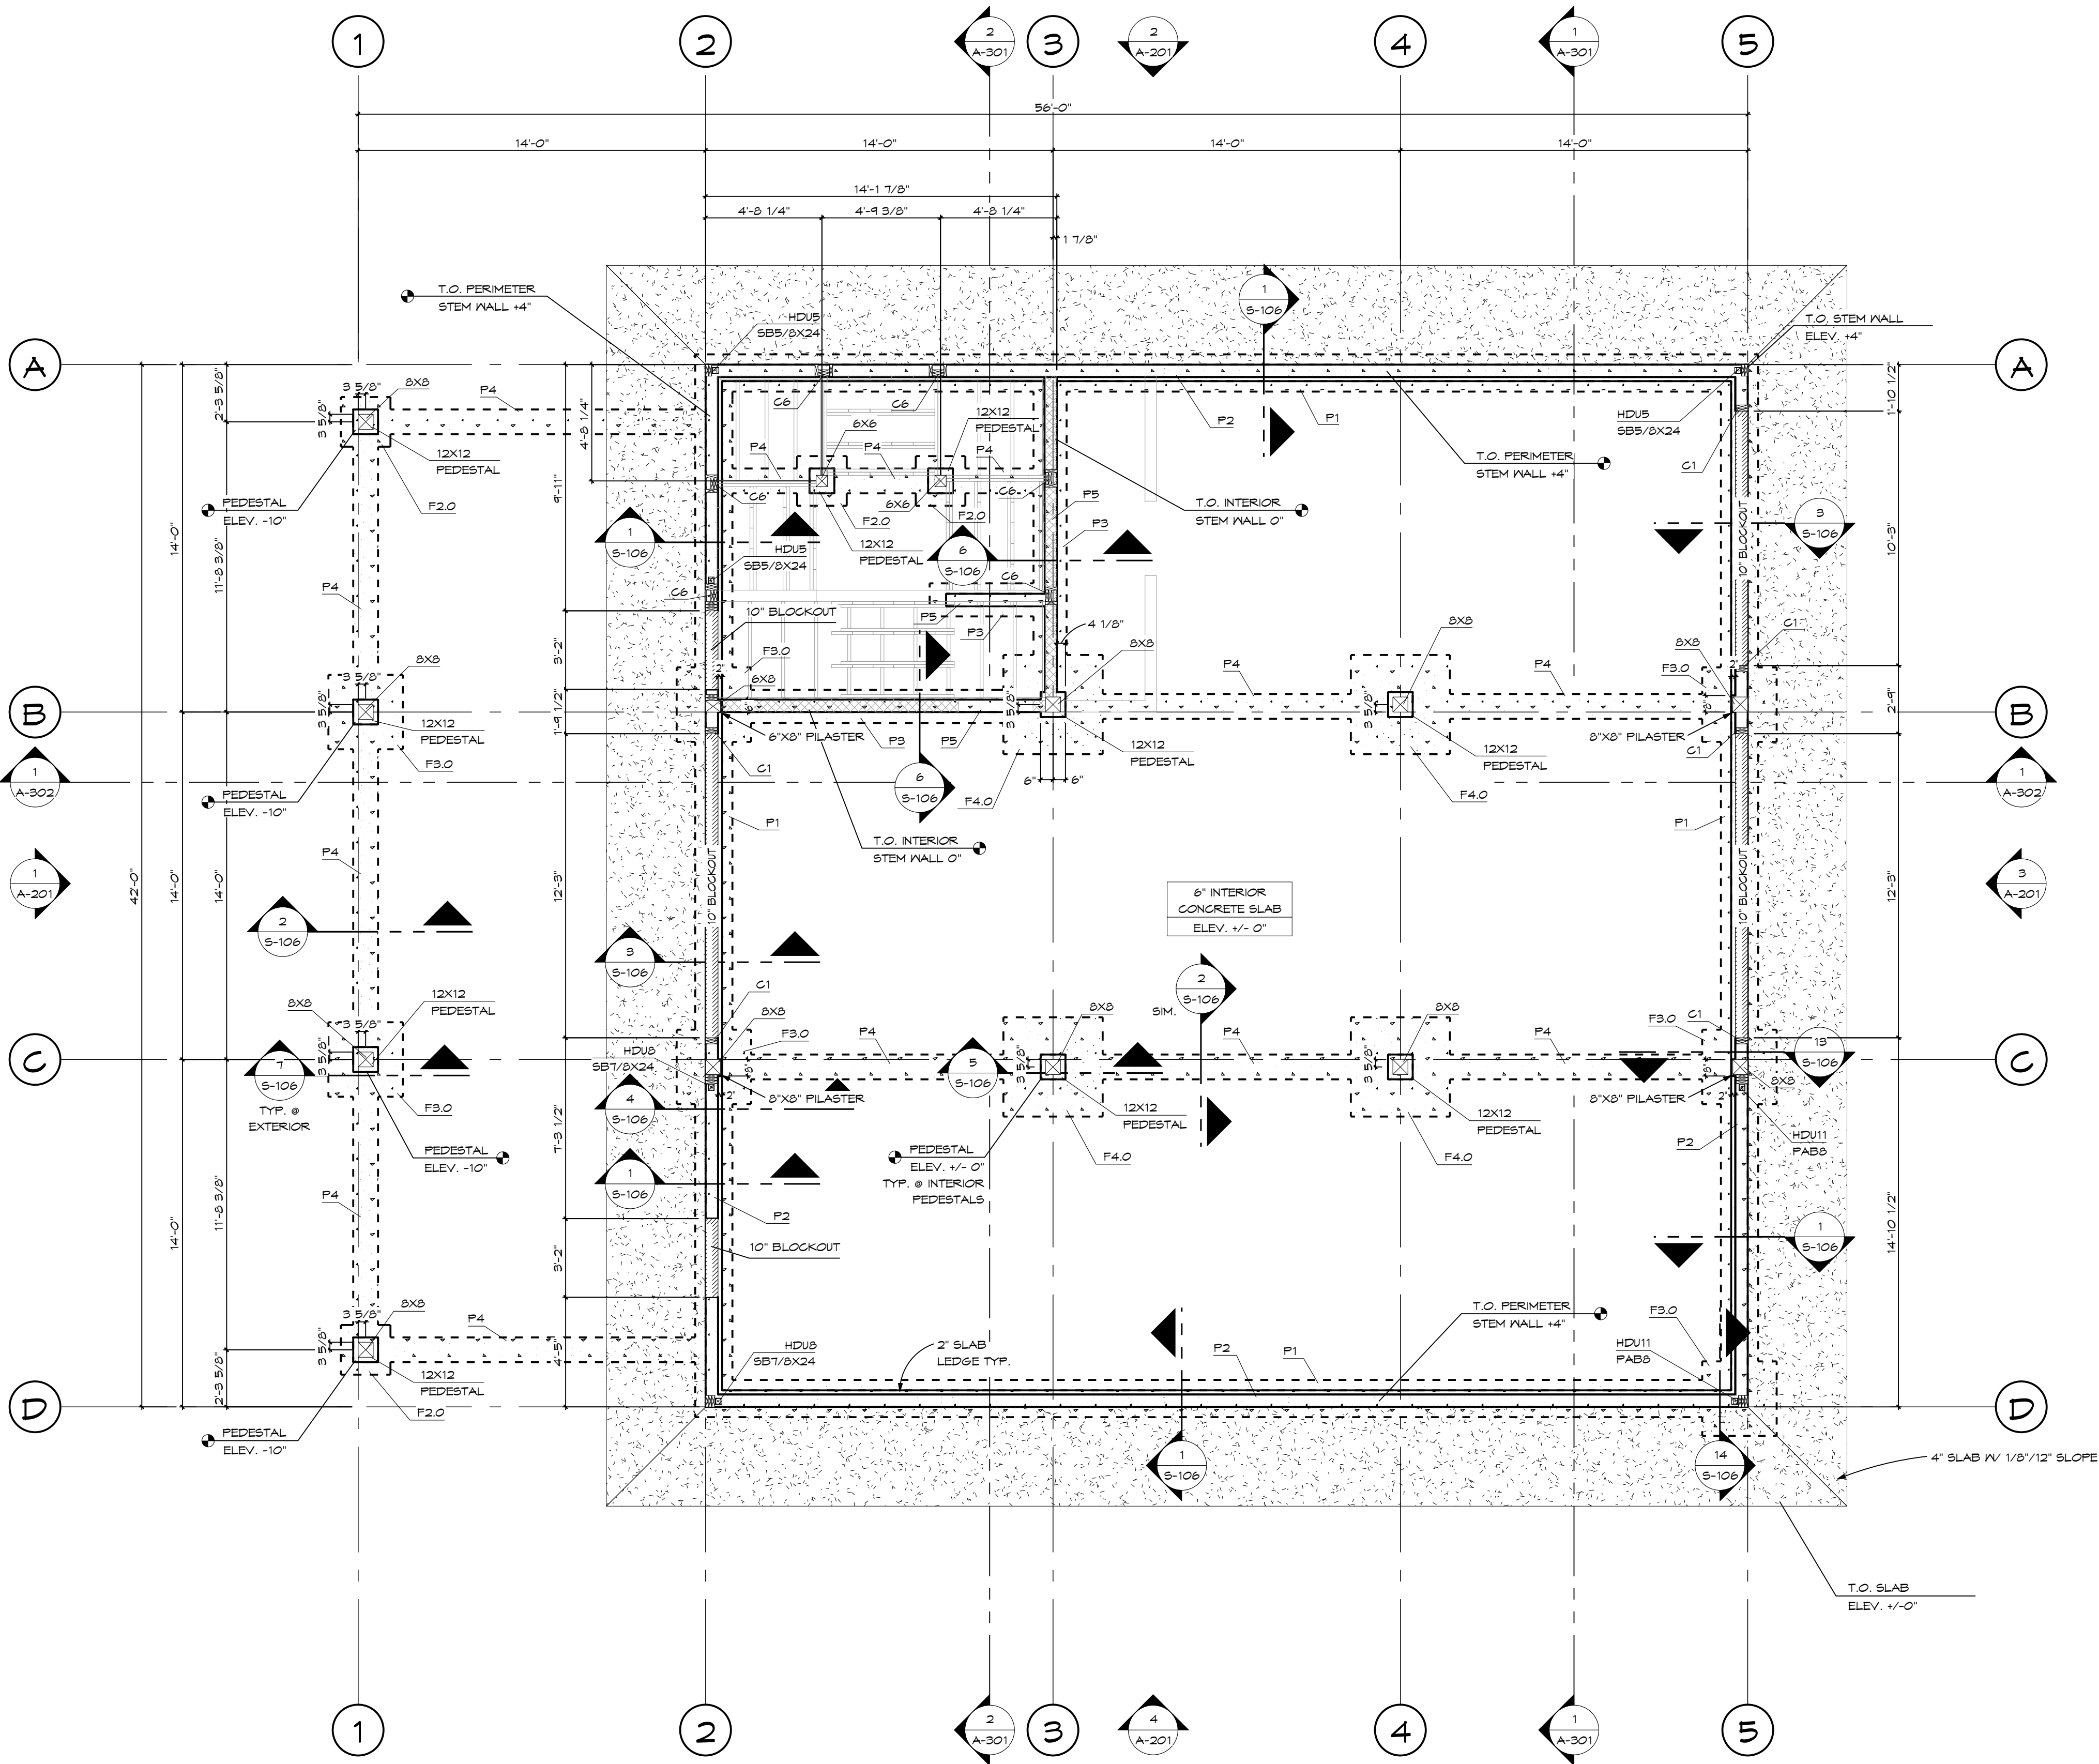

1 FOUNDATION PLAN  
Scale 1/4" = 1'-0"

Drawing Index		
No.	Date	Description
1	03.14.25	REV 1

OWNER INFORMATION  
LUKE & CARISSA  
BERLET

BERLET  
'SHASTA'


38980 MAIN STREET  
MILNER, CO 80477

FOUNDATION  
PLAN

S-101



REVIEWED  
FOR  
CODE  
COMPLIANCE  
04/28/2025

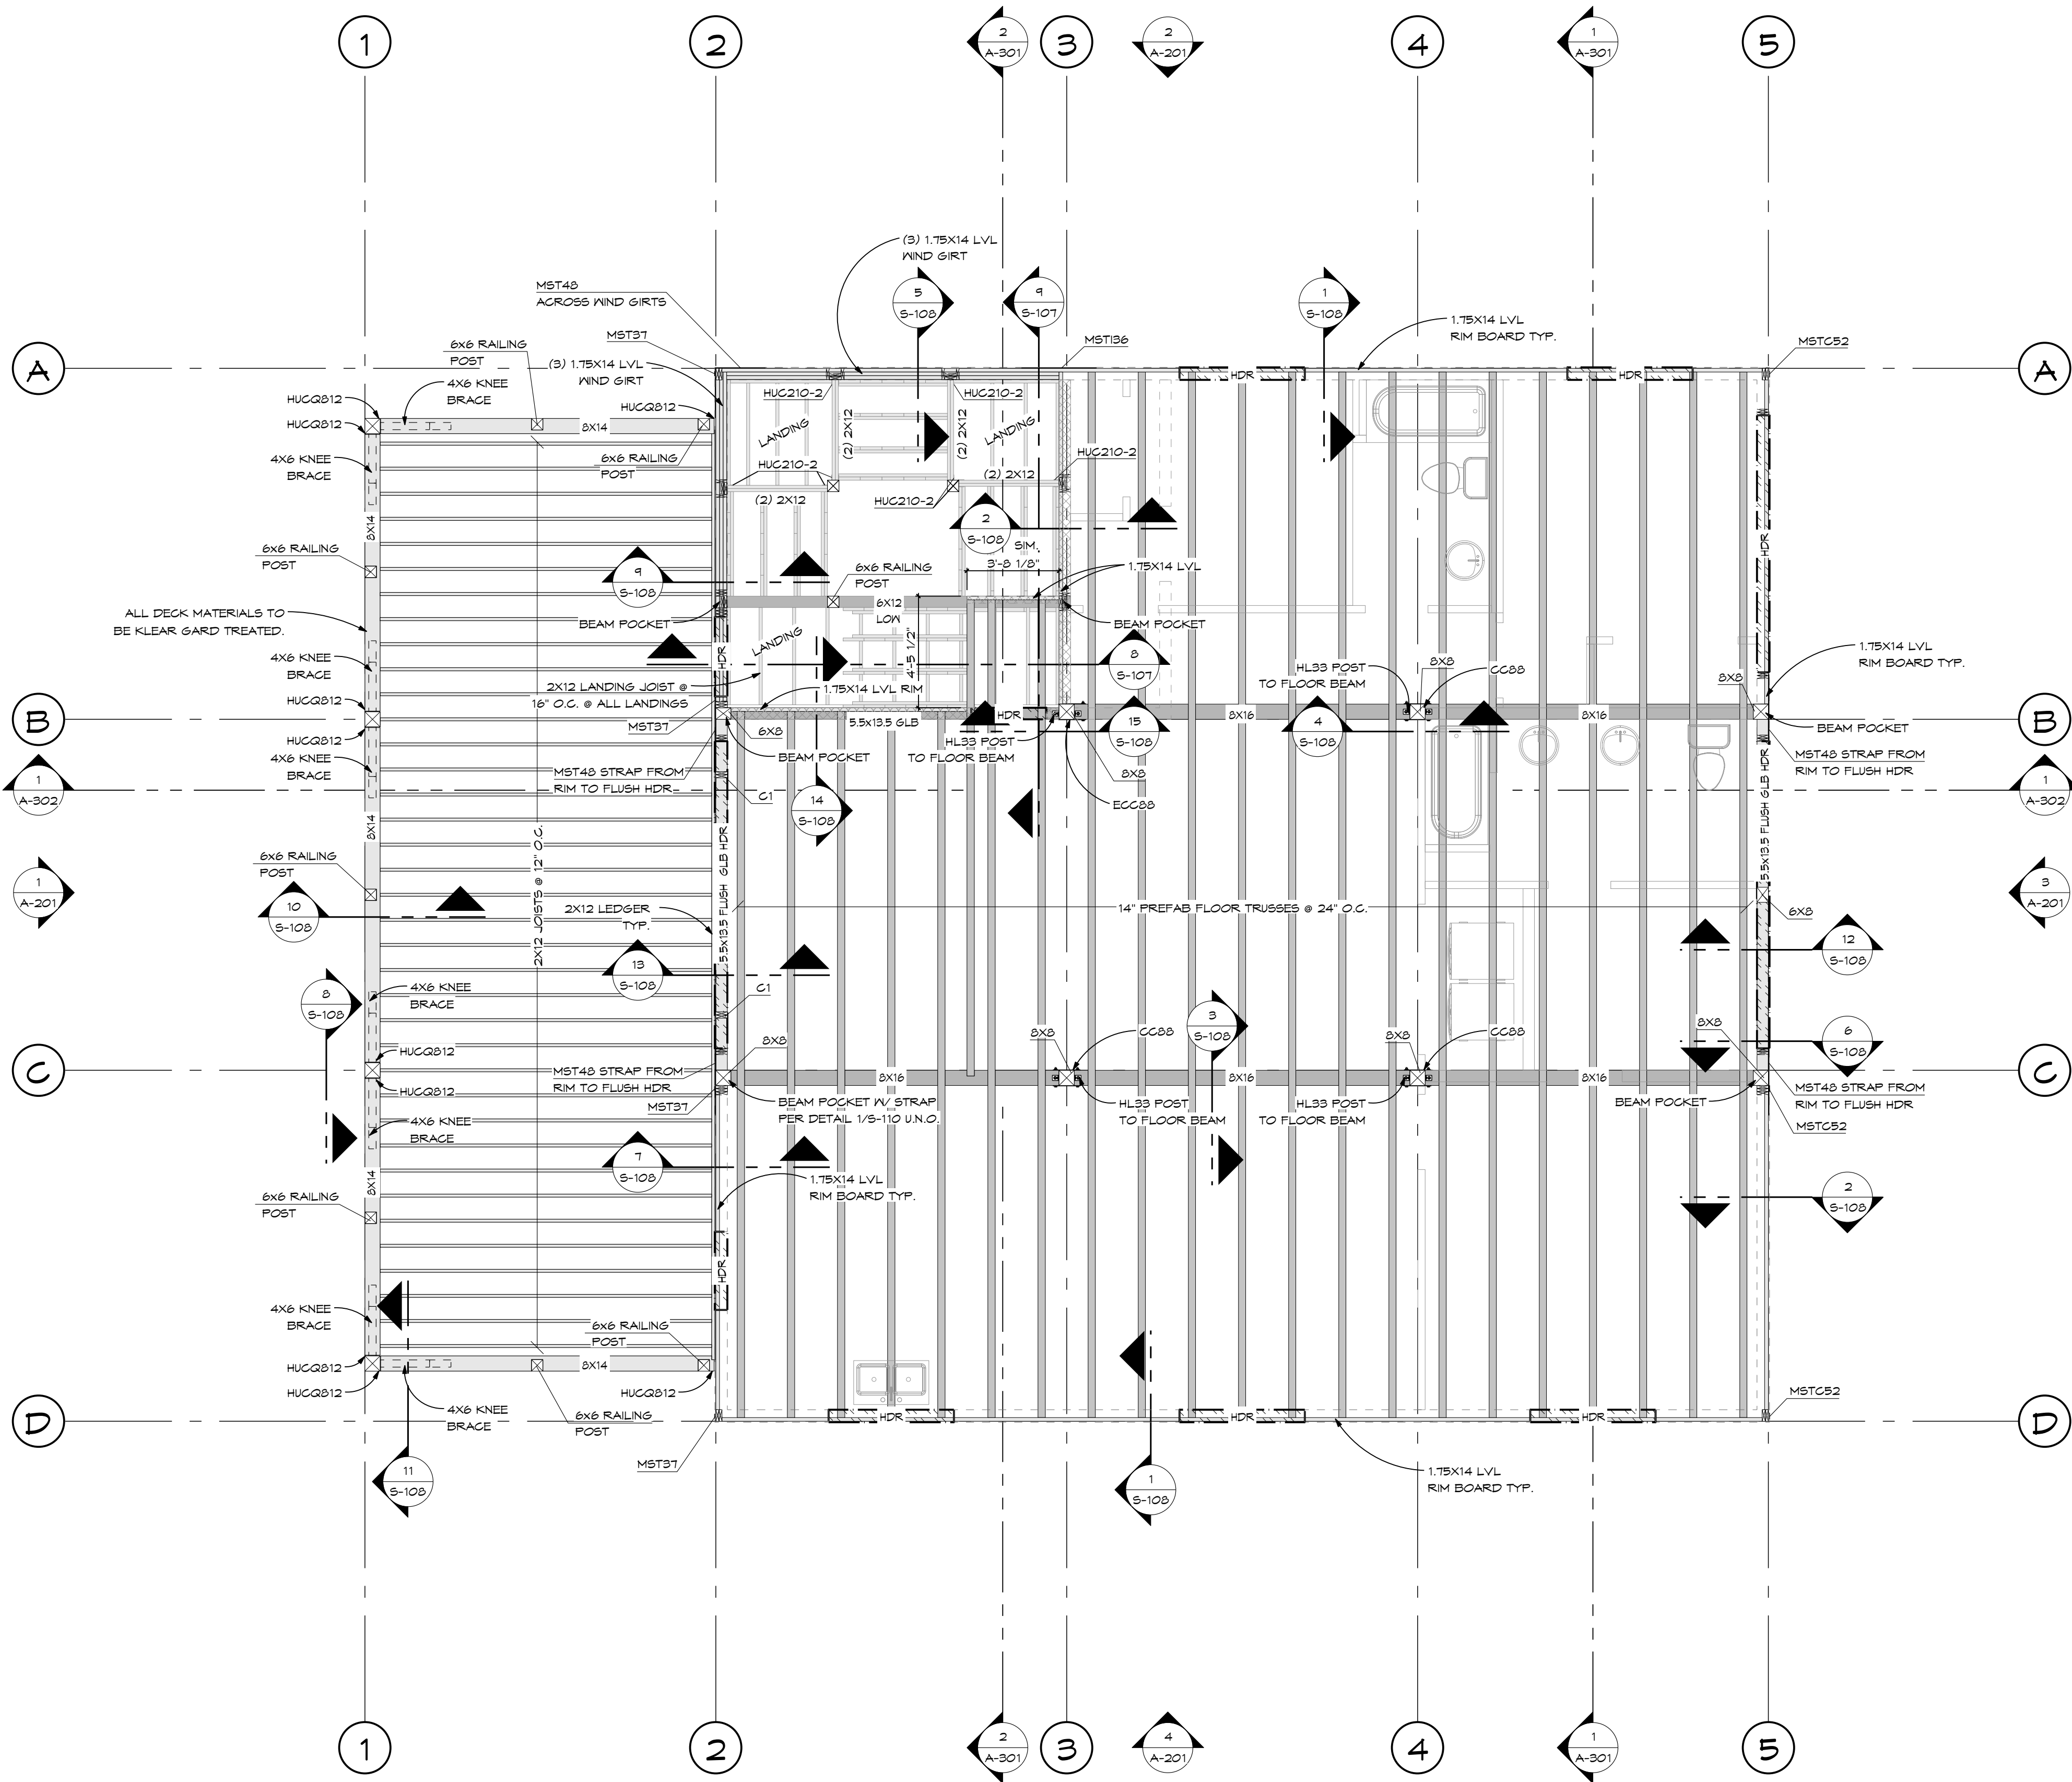

1 UPPER FLOOR FRAMING PLAN  
Scale 1/4" = 1'-0"

COLUMN SCHEDULE		
PLAN	TAG	DESCRIPTION
	C1	BUILT-UP (2) 2x6
	C2	BUILT-UP (3) 2x6
	C3	BUILT-UP @ 2' SMALL CORBEL POST
	C4	BUILT-UP @ CORNER 2' SMALL CORBEL POST
	C5	BUILT-UP @ CORNER 4' LARGE CORBEL POST
	C6	BUILT-UP @ BEAM POCKET POST

KING STUD SCHEDULE NUMBER OF STUDS		STUD HEIGHT					
ROUGH OPENING WIDTH		6" WALL					
		≤ 6'-0"	≤ 8'-0"	≤ 10'-0"	≤ 12'-0"	≤ 14'-0"	≤ 16'-0"
LESS THAN 4'-0"		1	1	1	1	2	2
4'-0" - 5'-11"		1	1	1	2	2	3
6'-0" - 7'-11"		1	1	1	2	3	4
8'-0" - 9'-11"		1	1	1	2	3	4
10'-0" - 11'-11"		1	1	2	2	3	5
12'-0" - 13'-11"		1	1	2	3	4	6

FRAMING LEGEND

	DENOTES POST BELOW
	DENOTES POST ABOVE AND/OR CONTINUOUS BELOW
	DENOTES LAYON OVER-FRAMING
	DENOTES WALL BELOW
	DENOTES BEARING WALL BELOW
	DENOTES WALL ABOVE
	DENOTES HEADER BELOW
	DENOTES ROOF BELOW

FRAMING PLAN GENERAL NOTES  
NOTES APPLY TO SHEETS S-102, S-103 ONLY

- ALL HEADERS TO BE 5.5 X 6 GLB U.N.O.
- PROVIDE (2) 2X6 STUDS @ 16" O.C. FOR STUDS TALLER THAN 14'
- VERIFY VENTILATION DESIGN REQUIREMENTS PER INSULATION TYPE.

Drawing Index		
No.	Date	Description
1	03.14.25	REV 1

OWNER INFORMATION  
LUKE & CARISSA  
BERLET


BERLET  
'SHASTA'

38980 MAIN STREET  
MILNER, CO 80477

UPPER  
FLOOR  
FRAMING  
PLAN

S-102

DRAWN BY  
R.J.F.  
04/15/2025

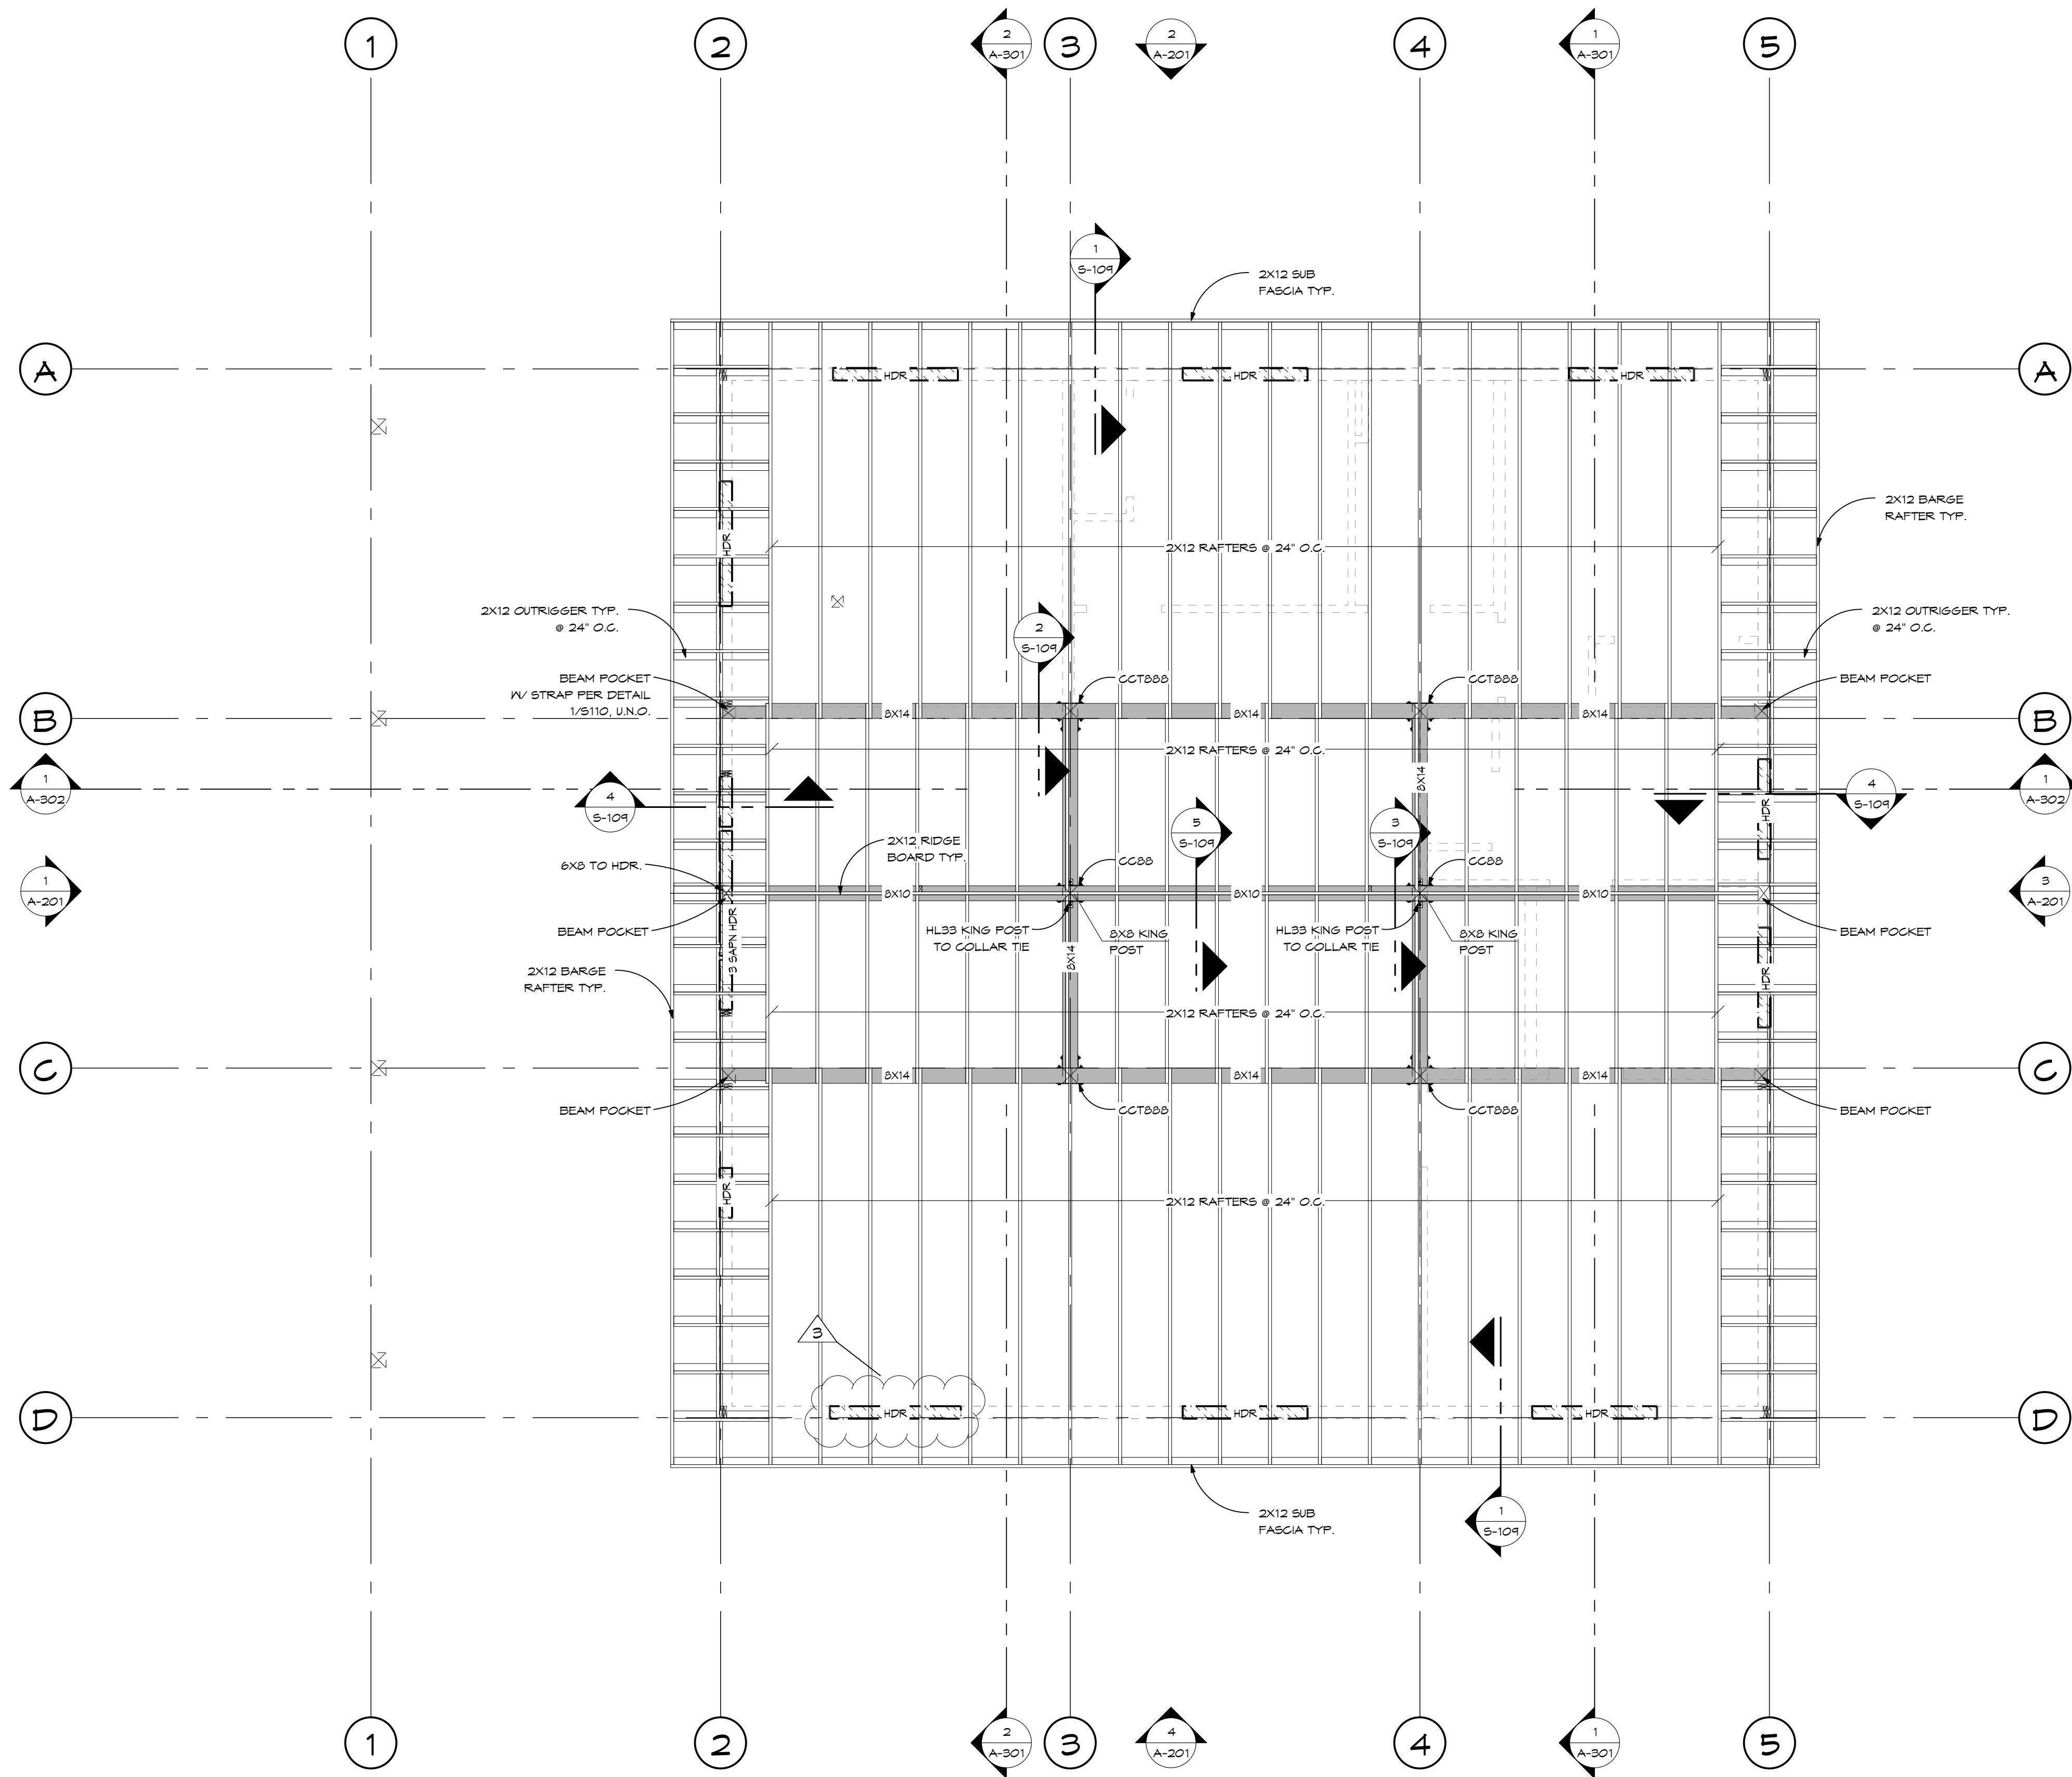

1 UPPER ROOF FRAMING PLAN  
Scale 1/4" = 1'-0"

COLUMN SCHEDULE		
PLAN	TAG	DESCRIPTION
	C1	BUILT-UP (2) 2X6
	C2	BUILT-UP (3) 2X6
	C3	BUILT-UP @ 2' SMALL CORBEL POST
	C4	BUILT-UP @ CORNER 2 SMALL CORBEL POST
	C5	BUILT-UP @ CORNER 4 LARGE CORBEL POST
	C6	BUILT-UP @ BEAM POCKET POST

KING STUD SCHEDULE NUMBER OF STUDS						
ROUGH OPENING WIDTH	STUD HEIGHT					
	6" WALL					
	≤ 6'-0"	≤ 8'-0"	≤ 10'-0"	≤ 12'-0"	≤ 14'-0"	≤ 16'-0"
LESS THAN 4'-0"	1	1	1	1	2	2
4'-0" - 5'-11"	1	1	1	2	2	3
6'-0" - 7'-11"	1	1	1	2	3	4
8'-0" - 9'-11"	1	1	1	2	3	4
10'-0" - 11'-11"	1	1	2	2	3	5
12'-0" - 15'-11"	1	1	2	3	4	6

#### FRAMING LEGEND

	DENOTES POST BELOW
	DENOTES POST ABOVE AND/OR CONTINUOUS BELOW
	DENOTES LAYON OVER-FRAMING
	DENOTES WALL BELOW
	DENOTES BEARING WALL BELOW
	DENOTES WALL ABOVE
	DENOTES HEADER BELOW
	DENOTES ROOF BELOW

#### FRAMING PLAN GENERAL NOTES

NOTES APPLY TO SHEETS S-102, S-103 ONLY

- ALL HEADERS TO BE 5.5 X 6 GLB U.N.O.
- PROVIDE (2) 2X6 STUDS @ 16" O.C. FOR STUDS TALLER THAN 14'
- VERIFY VENTILATION DESIGN REQUIREMENTS PER INSULATION TYPE.

Drawing Index		
No.	Date	Description
1	03.14.25	REV 1
2	04.16.25	REV 3

OWNER INFORMATION  
LUKE & CARISSA  
BERLET

BERLET  
'SHASTA'


38980 MAIN STREET  
MILNER, CO 80477

UPPER  
ROOF  
FRAMING  
PLAN


S-103




04/16/2025



A circular professional engineer seal for the State of Colorado. The outer ring contains the text "COLORADO LICENSED" at the top and "PROFESSIONAL ENGINEER" at the bottom. Inside the ring, the name "SCOTT MICHAEL RATTIERMAN" is written in a circle around the license number "53862". A handwritten signature "S. Rattierman" is written across the seal. The expiration date "04/16/2025" is printed at the top left of the seal.



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A CUSHING TERRELL COMPANY  
2140 SW JEFFERSON ST., SUITE 200  
PORTLAND, OR 97201  
ECLIPSE-ENGINEERING.COM (503) 366-1229

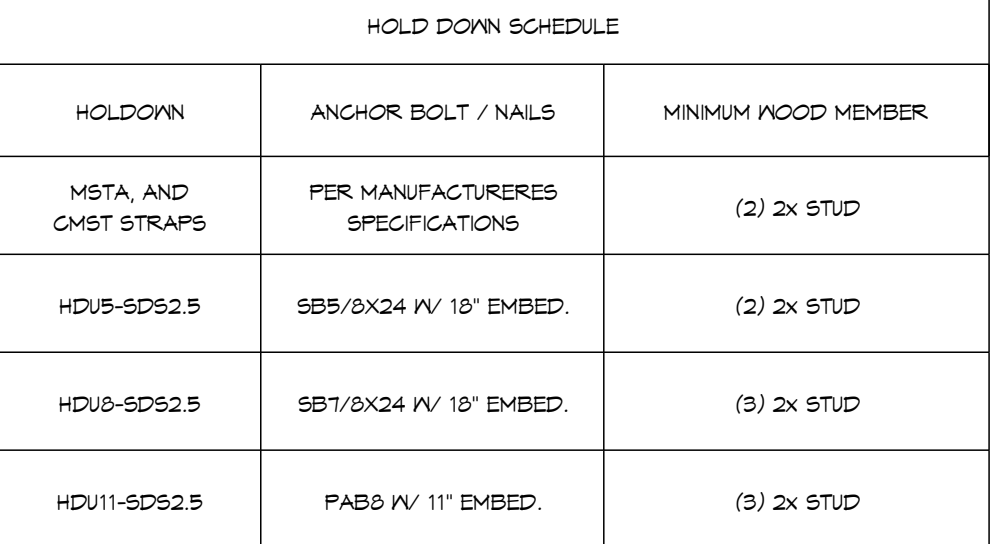



NOTE: HOLDDOWN ANCHOR BOLT LOCATIONS ON PLANS ARE APPROXIMATE ONLY. REFER TO FINAL HOLDDOWN PLACEMENT PLAN PROVIDED BY DC STRUCTURES FOR FINAL DIMENSIONS AND LOCATIONS OF HOLDDOWNS AND ANCHORS.

SHEAR WALL SCHEDULE					
			BILL ANCHORS		
WALL TYPE	MATERIAL	NAIL SPACING (IN) AT PANEL EDGES	CONCRETE ATTACHMENT	WOOD ATTACHMENT	RM OR BULK FRAMING CLIP
U	7/16 OSB (UNBLOCKED)	8d @ 6"	5/8" @ 48"	1/2" SDS @ 16"	F.C. @ 24"
A	7/16 OSB	8d @ 6"	5/8" @ 48"	1/2" SDS @ 12"	F.C. @ 14"
B	7/16 OSB	8d @ 4"	5/8" @ 36"	1/2" SDS @ 9"	F.C. @ 10"
C a,b	7/16 OSB	8d @ 3"	5/8" @ 24"	1/2" SDS @ 6"	F.C. @ 8"
D a,b	7/16" OSB	8d @ 2"	5/8" @ 12"	1/2" SDS @ 4"	F.C. @ 6"
BB a,b,c	7/16 OSB - BOTH SIDES	8d @ 4"	5/8" @ 36"	1/2" SDS @ 3"	A35 @ 6"
CC a,b,c	7/16 OSB - BOTH SIDES	8d @ 3"	5/8" @ 12"	(2) ROWS 1/2" SDS @ 6"	A35 @ 6"
DD a,b,c	7/16 OSB - BOTH SIDES	8d @ 2"	5/8" @ 8"	(2) ROWS 1/2" SDS @ 6"	A35 @ 6"

NOTES APPLY TO SHEET S-104 & S-105 ONLY.

1. HOLD-DOWNS PER PLAN
2. STUDS SHALL BE SPACED AT 16" O.C. MAXIMUM (PLYWOOD MAY BE INSTALLED HORIZONTALLY OR VERTICALLY).
3. FOR DF-L STUDS ONLY.
4. MINIMUM THICKNESS OF SHEATHING SHALL BE 1/16". THICKER SHEATHING MAY BE USED. OSB OR CDX PLYWOOD ARE ACCEPTABLE.
5. FRAMING CLIP (F.C.) CAN BE A35, LTP4, REG OR L550, UNLESS NOTED OTHERWISE.
6. SPACE NAILS AT 12" O.C. ALONG INTERCLOST FRAMING MEMBERS.
7. ALL UNSUPPORTED PANEL EDGES SHALL BE BLOCKED AND EDGE-NAILED (EN), U.N.O.
8. USE ONLY COMMON OR BOX NAILS (GALVANIZED) FOR ALL PANEL AND SILL PANEL NAILING (GALVANIZED NAILS SHALL BE HOT-DIPPED OR DUMBED).
9. ALL SHEAR PANELS ARE TO BE CONTINUOUS BETWEEN HORIZONTAL DIAPHRAGMS (ROOF TO FLOOR, FLOOR TO FLOOR, FLOOR TO FOUNDATION).
10. ANCHOR BOLTS IN CONCRETE SHALL HAVE A 1" MINIMUM EMBEDMENT INTO CONCRETE AND LOCATED NOT MORE THAN 12" OR LESS THAN 4" FROM EACH END. PROVIDE 3" SQ. X 1/4" THICK PLATE WASHER AT ANCHOR BOLTS.
11. 3X MEMBERS MAY BE SUBSTITUTED WITH (2) 2X MEMBERS NAILED TOGETHER WITH 10d NAILS @ 4" O.C.
12. FOOTNOTES:
  - a. STUDS AND/OR BLOCKING AT ADJOINING PANEL EDGES SHALL BE A 3X MINIMUM AND NAILS SHALL BE STAGGERED
  - b. SILL PANELS SHALL BE 3X MINIMUM
  - c. WHERE PANELS ARE APPLIED ON BOTH FACES OF A WALL AND NAIL SPACING IS 6" O.C. OR LESS, PANEL JOINTS SHALL BE OFFSET TO FALL ON DIFFERENT FRAMING MEMBERS.
13. ALL WALLS NOT LABELED ARE TO BE FRAMED PER TYPE "U".

Scale 1/4" = 1'-0"

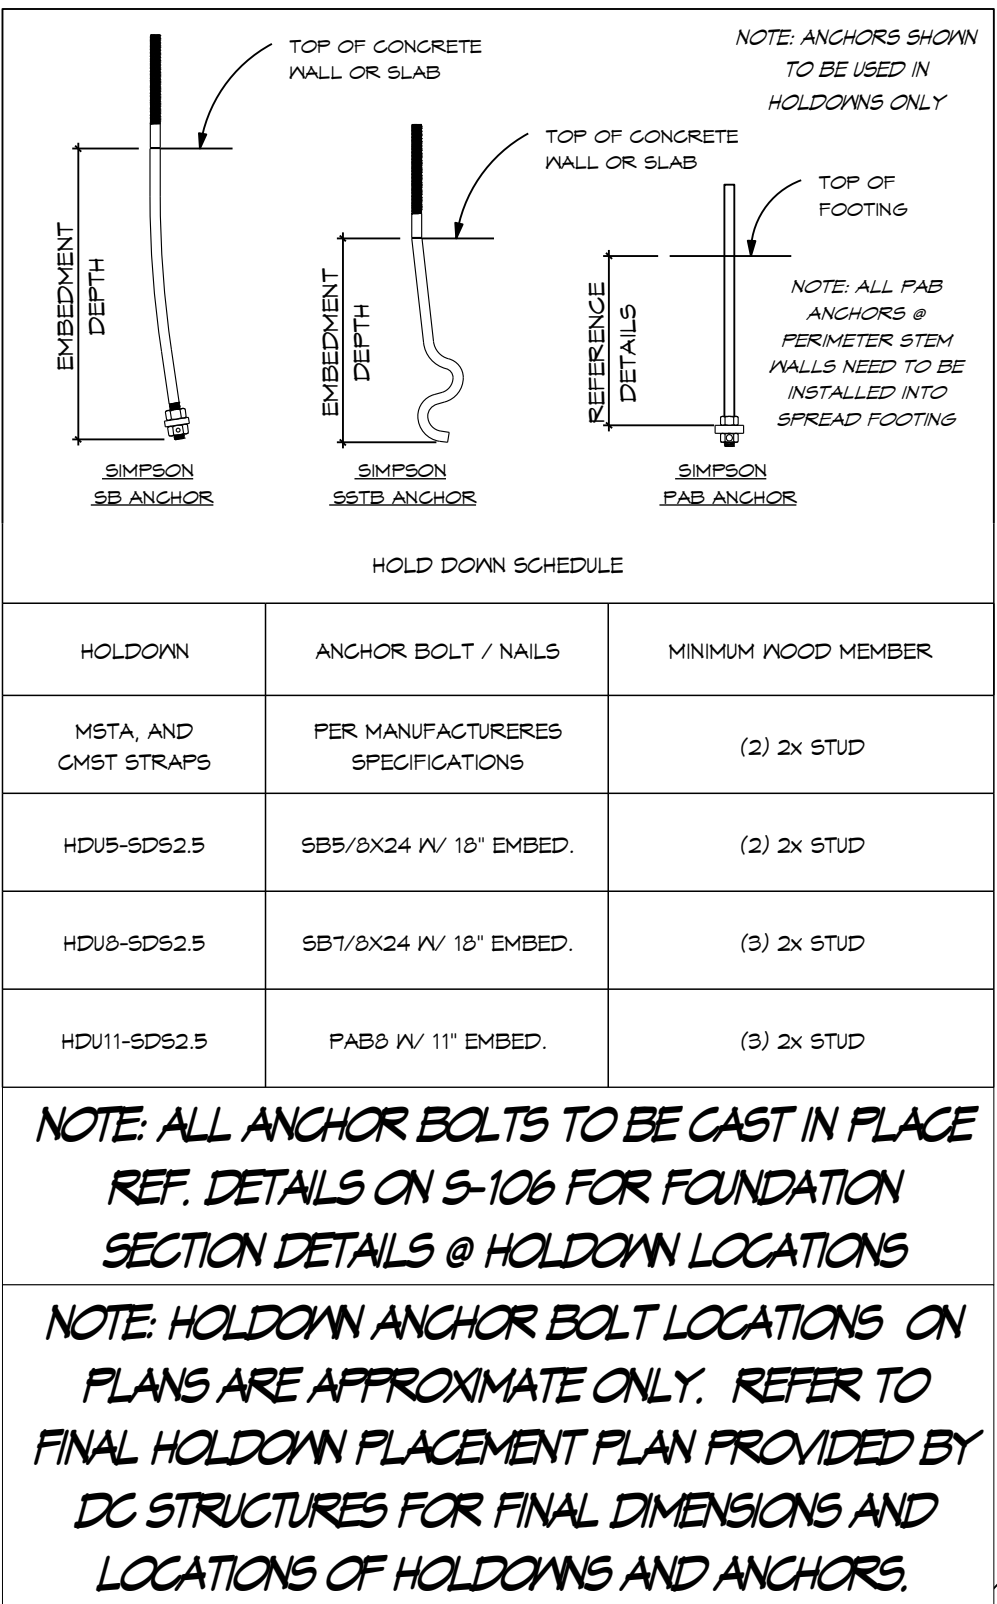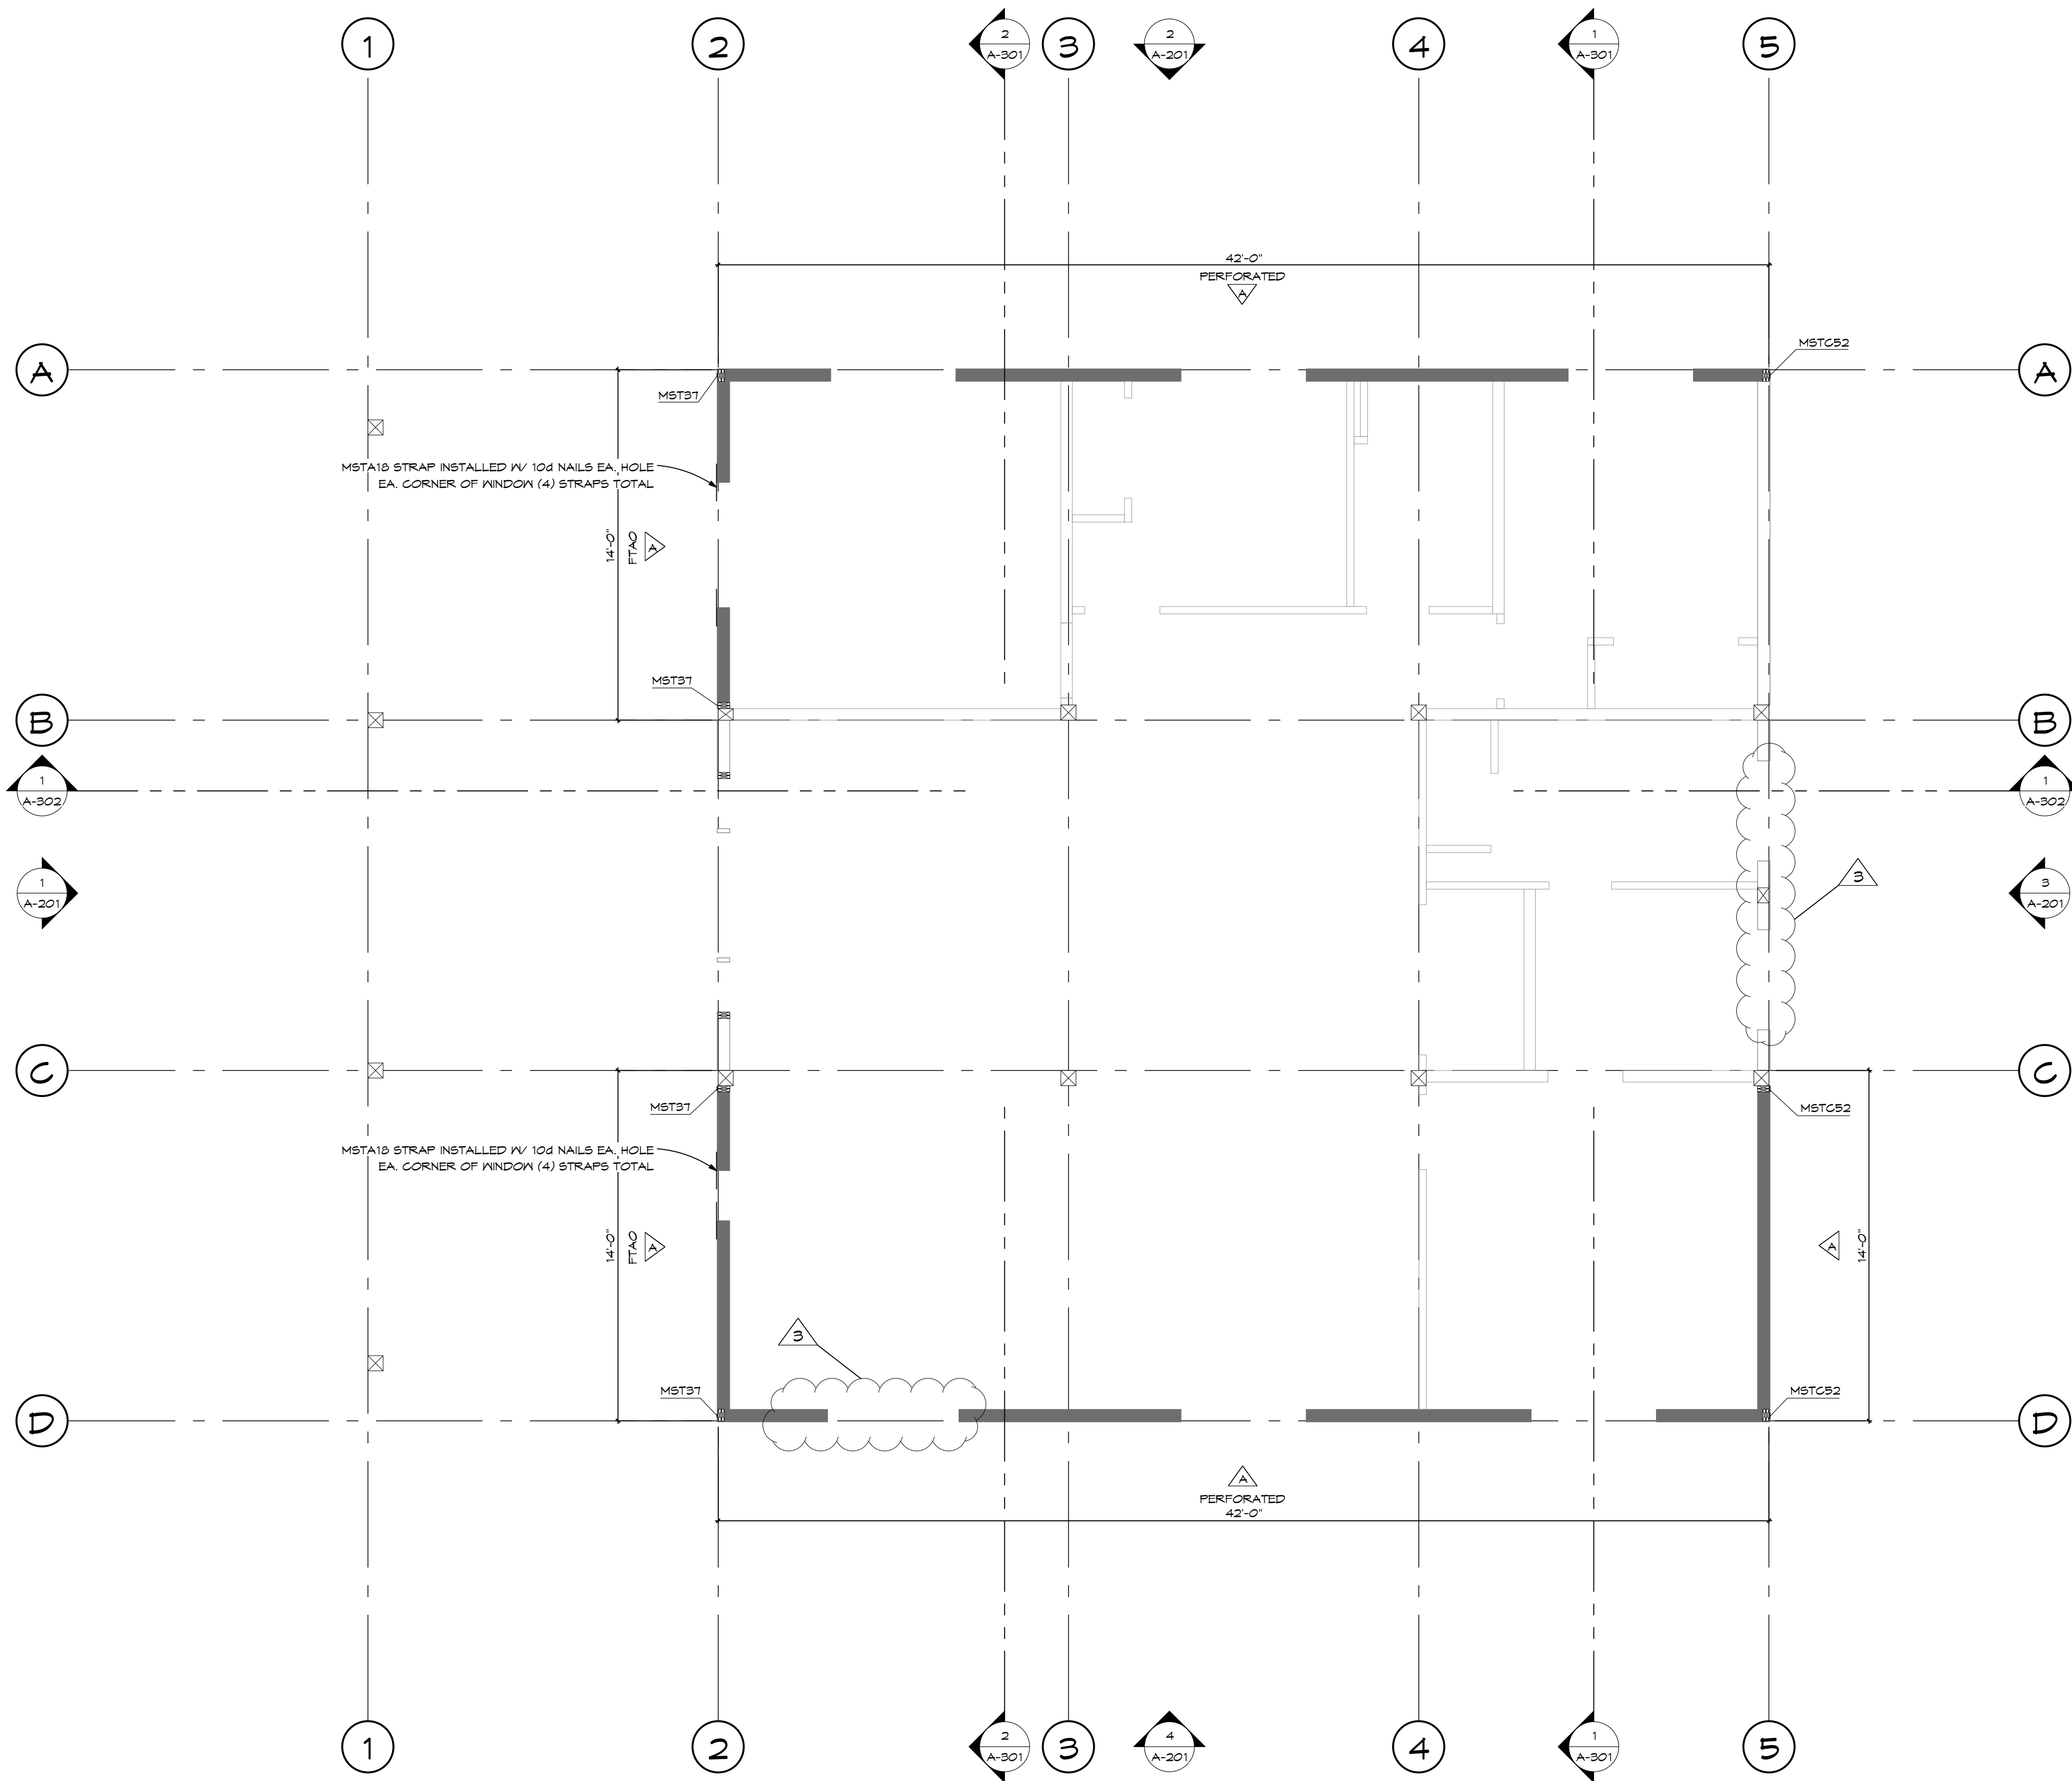

SHEAR WALL SCHEDULE					
WALL TYPE	MATERIAL	NAIL SPACING (EN) AT PANEL EDGES	SILL ANCHORS		
			CONCRETE ATTACHMENT	WOOD ATTACHMENT	RM OR BULK FRAMING CLIP
U	7/16 OSB (UNBLOCKED)	8d @ 6"	5/8" @ 48"	1/2" SD5 @ 16"	F.C. @ 24"
A	7/16 OSB	8d @ 6"	5/8" @ 48"	1/2" SD5 @ 12"	F.C. @ 14"
B	7/16 OSB	8d @ 4"	5/8" @ 36"	1/2" SD5 @ 9"	F.C. @ 10"
C a, b	7/16 OSB	8d @ 3"	5/8" @ 24"	1/2" SD5 @ 6"	F.C. @ 8"
D a, b	7/16 OSB	8d @ 2"	5/8" @ 12"	1/2" SD5 @ 4"	F.C. @ 6"
BB a,b,c	7/16 OSB - BOTH SIDES	8d @ 4"	5/8" @ 16"	1/2" SD5 @ 3"	A35 @ 6"
CC a,b,c	7/16 OSB - BOTH SIDES	8d @ 3"	5/8" @ 12"	(2) ROWS 1/2" SD5 @ 6"	A35 @ 6"
DD a,b,c	7/16 OSB - BOTH SIDES	8d @ 2"	5/8" @ 8"	(2) ROWS 1/2" SD5 @ 6"	A35 @ 6"

**SHEAR WALL PLAN GENERAL NOTES**

NOTES APPLY TO SHEET S-104 & S-105 ONLY.

- HOLD-DOWNS PER PLAN
- STUDS SHALL BE SPACED AT 16" O.C. MAXIMUM (PLYWOOD MAY BE INSTALLED HORIZONTALLY OR VERTICALLY).
- FOR DF-L STUDS ONLY.
- MINIMUM THICKNESS OF SHEATHING SHALL BE 7/16". THICKER SHEATHING MAY BE USED. OSB OR CDX PLYWOOD ARE ACCEPTABLE.
- FRAMING CLIP (F.C.) CAN BE A35, LTP4, RBG OR L550, UNLESS NOTED OTHERWISE.
- SPACE NAILS AT 12" O.C. ALONG INTERMEDIATE FRAMING MEMBERS.
- ALL UNSUPPORTED PANEL EDGES SHALL BE BLOCKED AND EDGE-NAILED (EN), U.N.O.
- USE ONLY COMMON OR BOX NAILS (GALVANIZED) FOR ALL PANEL AND SILL PLATE NAILING (GALVANIZED NAILS SHALL BE HOT-DIPPED OR DUMBED).
- ALL SHEAR PANELS ARE TO BE CONTINUOUS BETWEEN HORIZONTAL DIAPHRAGMS (ROOF TO FLOOR, FLOOR TO FLOOR, FLOOR TO FOUNDATION).
- SILL ANCHOR BOLTS SHALL BE CAST-IN-PLACE AND SHALL HAVE A 7" MINIMUM EMBEDMENT INTO CONCRETE AND LOCATED NOT MORE THAN 12" OR LESS THAN 4" FROM EACH END. PROVIDE 3" SQ. X 1/4" THICK PLATE WASHER AT ANCHOR BOLTS.
- 3X MEMBERS MAY BE SUBSTITUTED WITH (2) 2X MEMBERS NAILED TOGETHER WITH 10d NAILS @ 4" O.C.
- FOOTNOTES:
  - STUDS AND/OR BLOCKING AT ADJOINING PANEL EDGES SHALL BE A 3X MINIMUM AND NAILS SHALL BE STAGGERED
  - SILL PLATES SHALL BE 3X MINIMUM
  - WHERE PANELS ARE APPLIED ON BOTH FACES OF A WALL AND NAIL SPACING IS 6" O.C. OR LESS, PANEL JOINTS SHALL BE OFFSET TO FALL ON DIFFERENT FRAMING MEMBERS.
- ALL WALLS NOT LABELED ARE TO BE FRAMED PER TYPE 'U'.

**1 UPPER LEVEL SHEAR WALL PLAN**  
Scale 1/4" = 1'-0"

Drawing Index		
No.	Date	Description
1	03.14.25	REV 1
2	04.16.25	REV 2

OWNER INFORMATION  
LUKE & CARISSA  
BERLET


BERLET  
'SHASTA'

38980 MAIN STREET  
MILNER, CO 80477


UPPER  
LEVEL  
SHEAR WALL  
PLAN

**S-105**




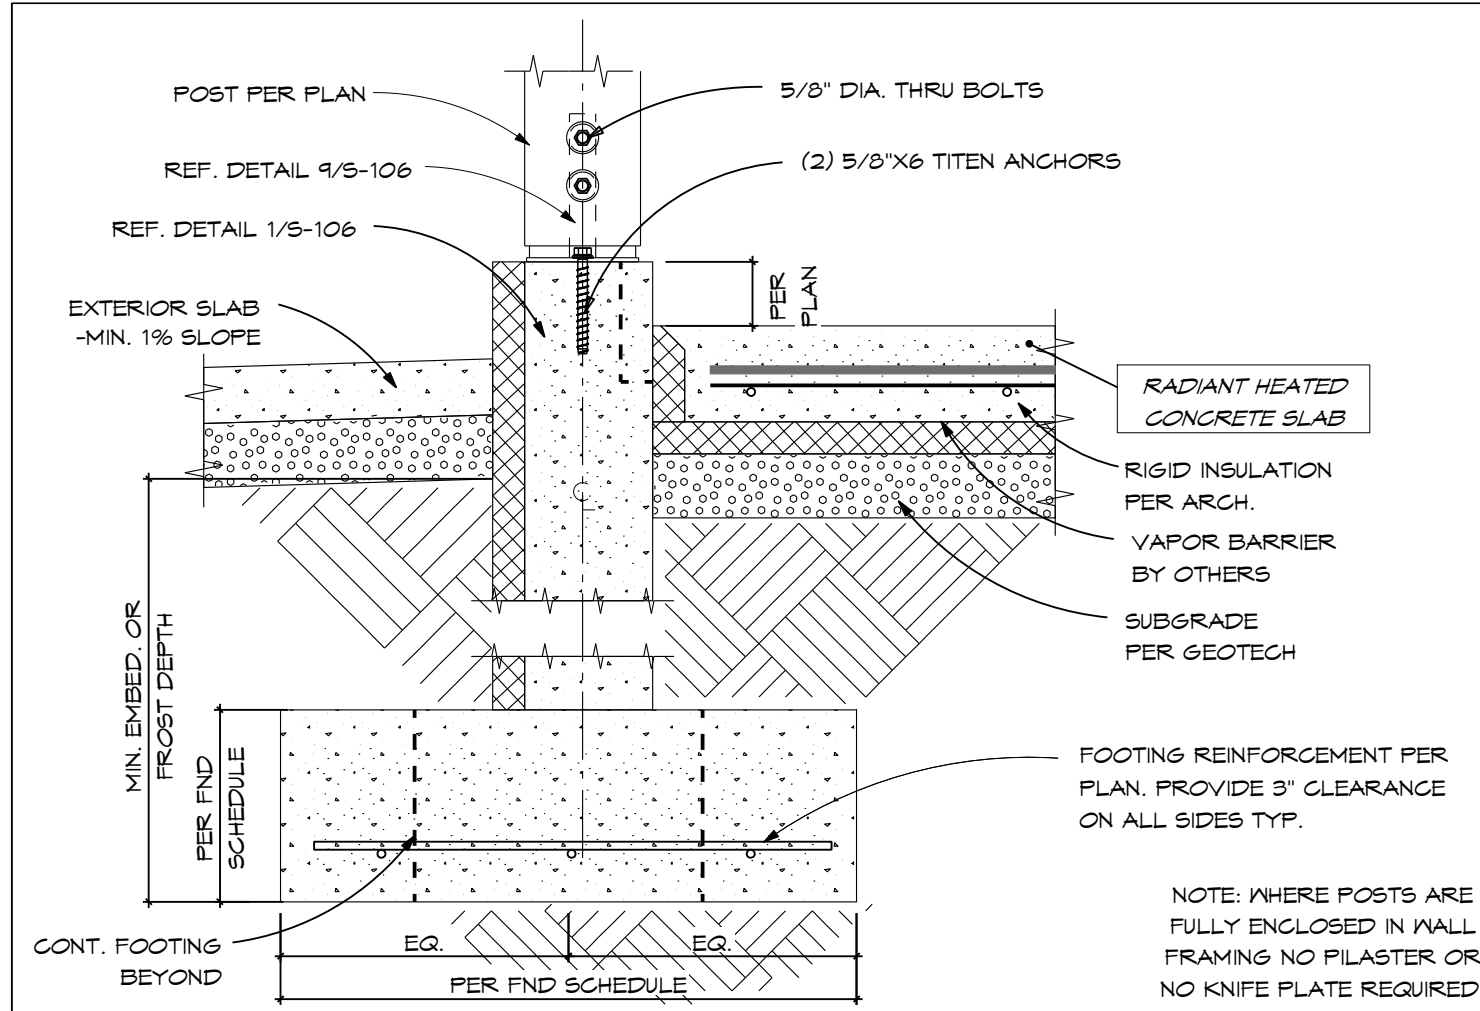


**13** PAD FOOTING UNDER PERIMETER FOOTING / POST  
Scale 1" = 1'-0"

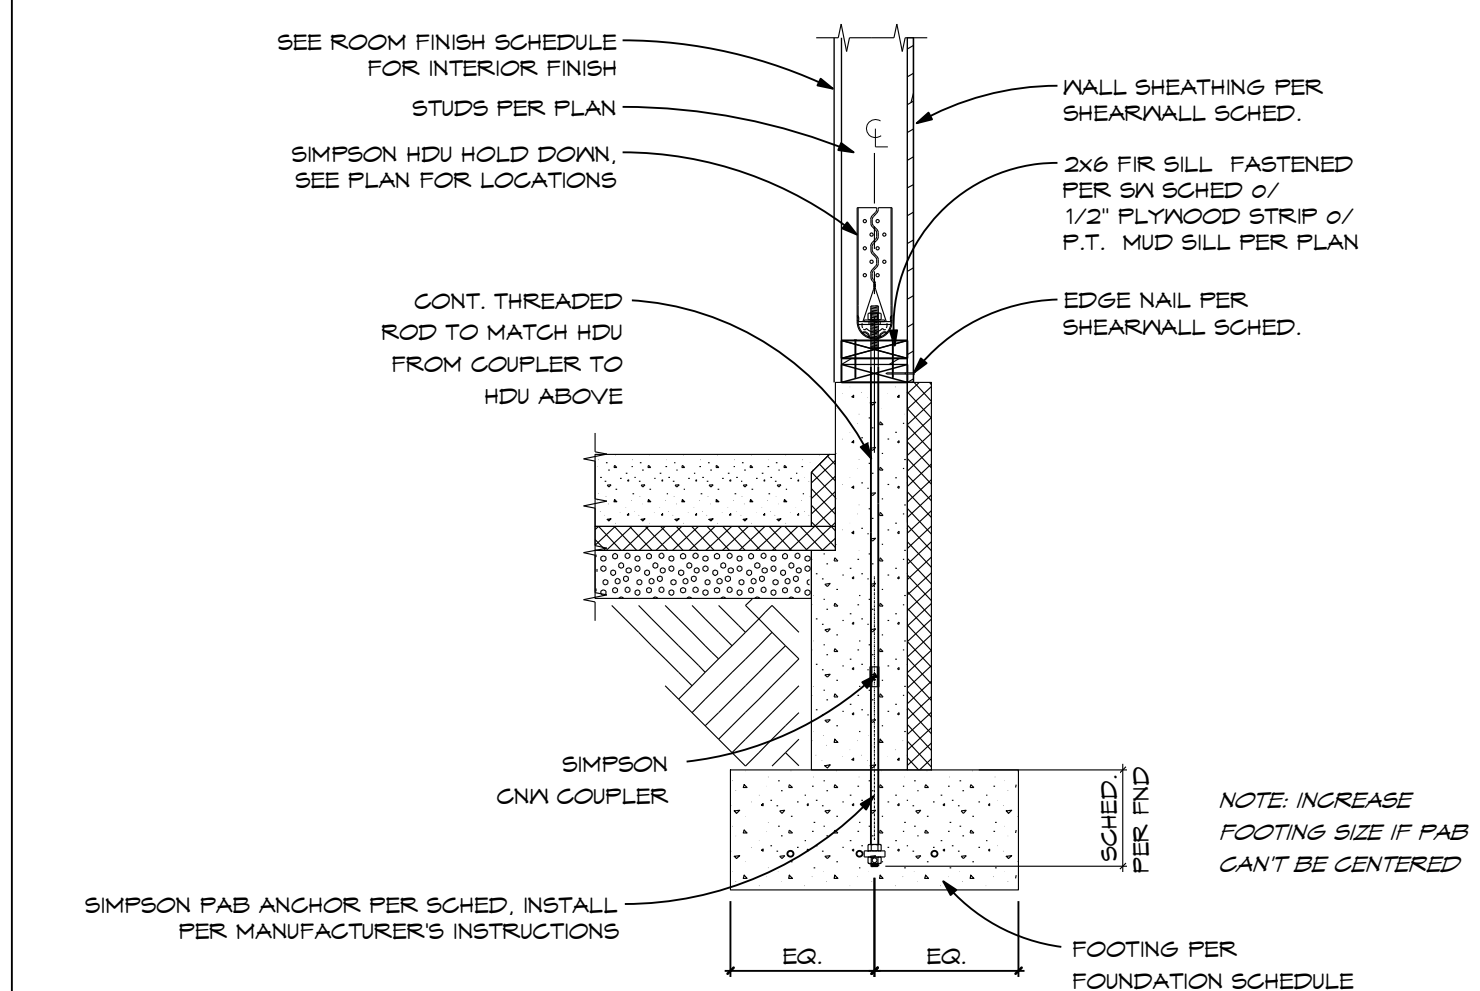


**14** SW HOLD DOWN DETAIL W/ PAB TO FOOTING  
Scale 3/4" = 1'-0"

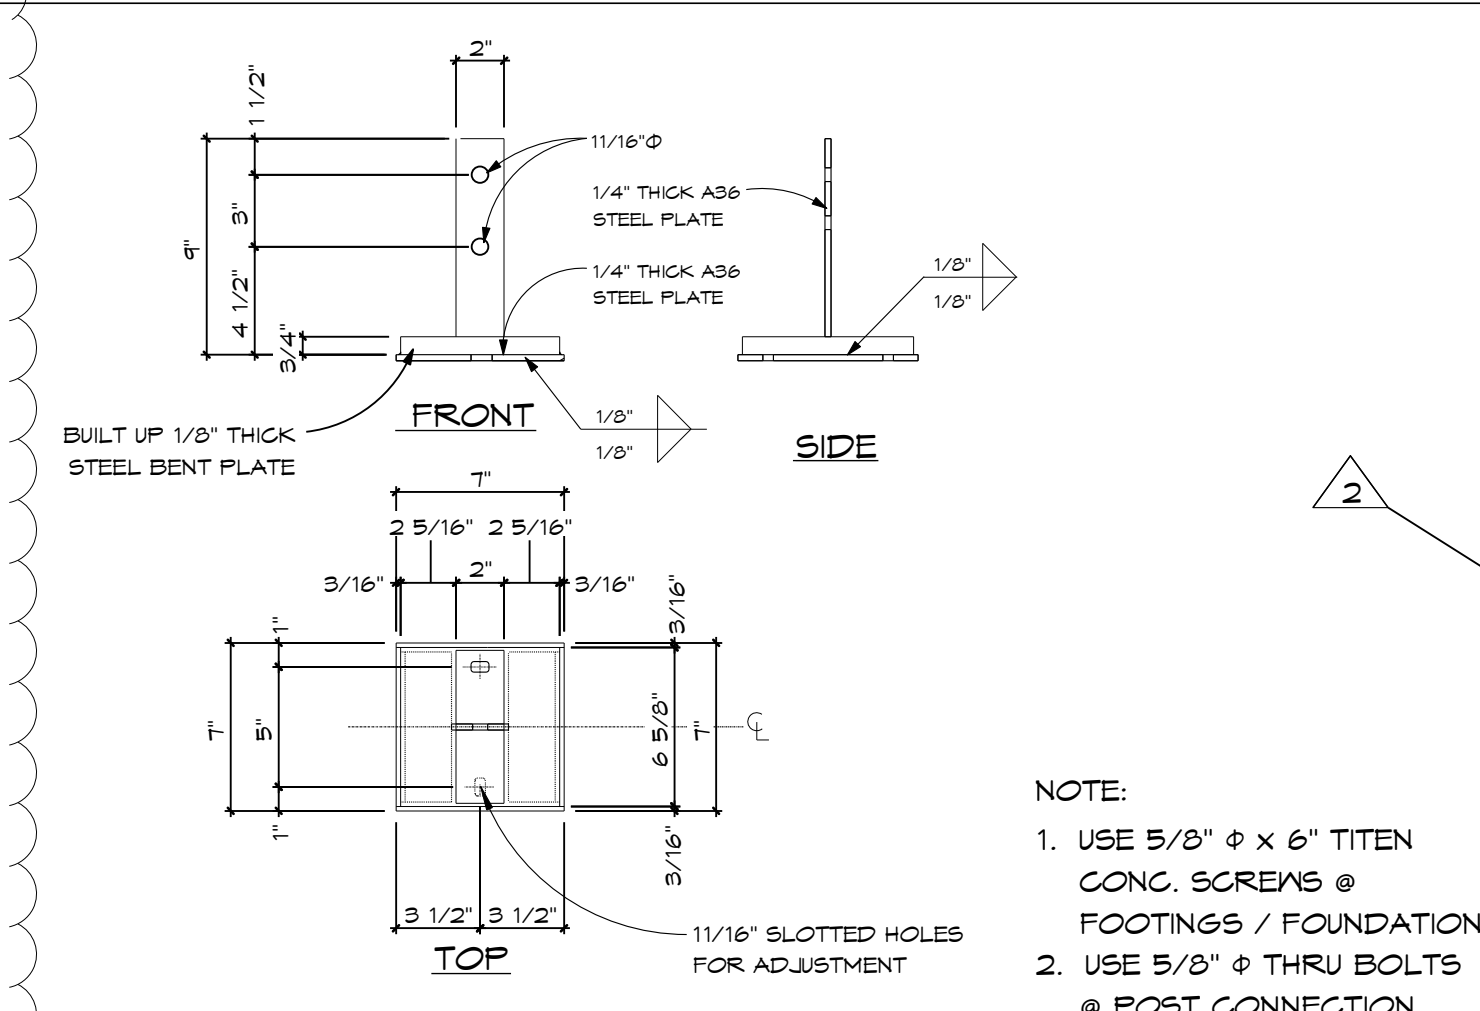


**9** POST BASE KNIFE PLATE 8x8 (KP77)  
Scale 1 1/2" = 1'-0"

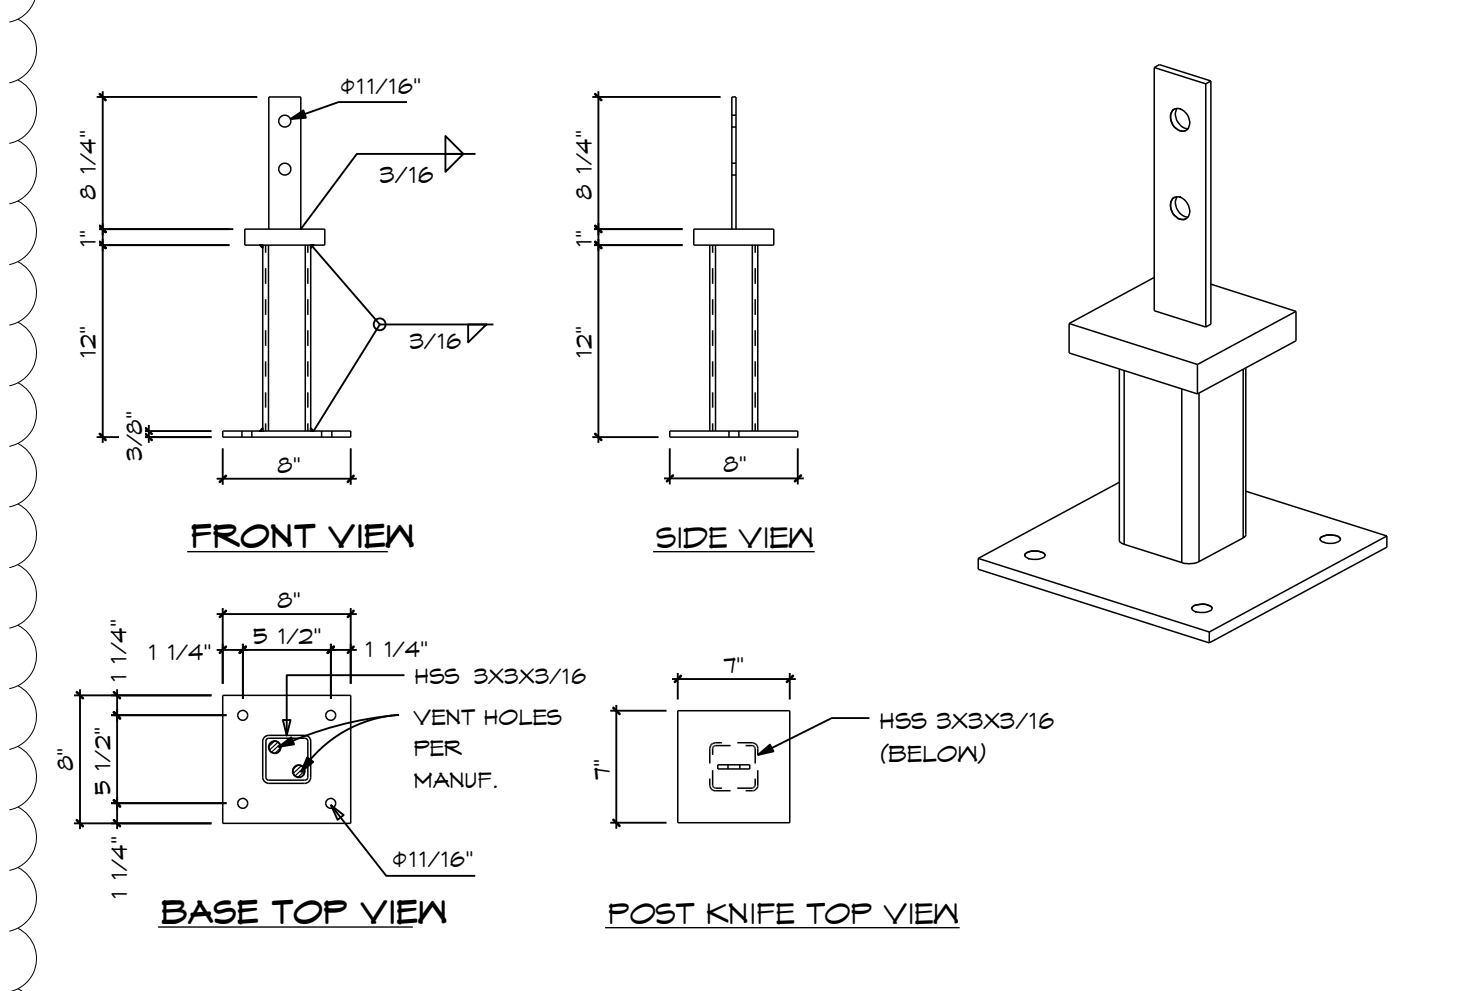


**10** HSS ELEVATED POST BASE - KP77  
Scale 1" = 1'-0"

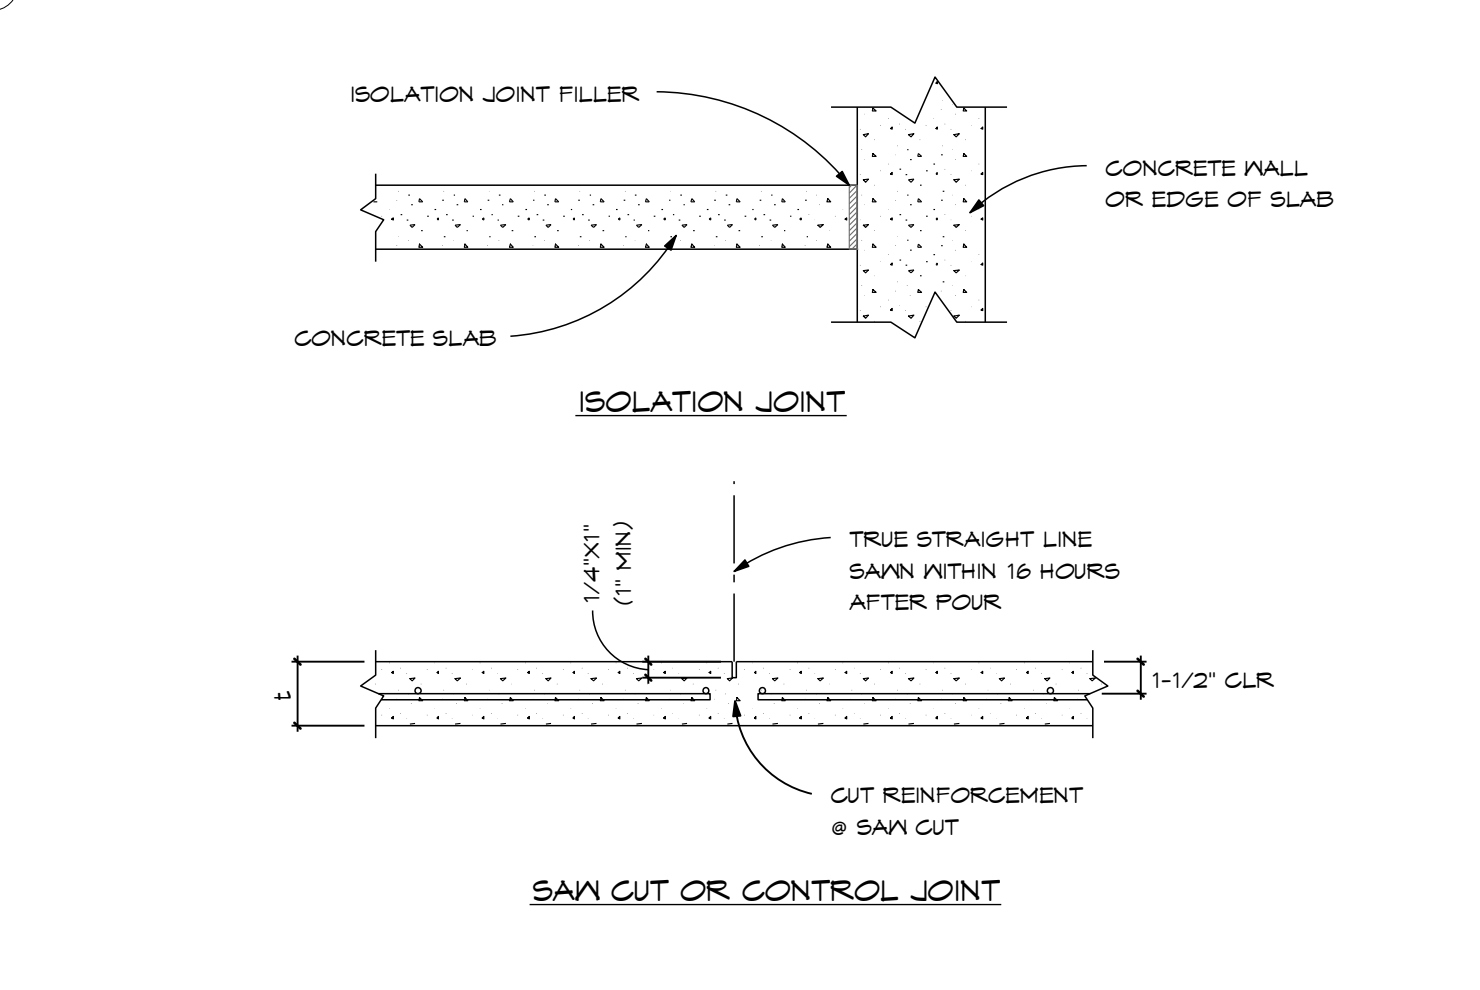


**11** TYP. CONTROL JOINT DETAIL  
Scale 1" = 1'-0"

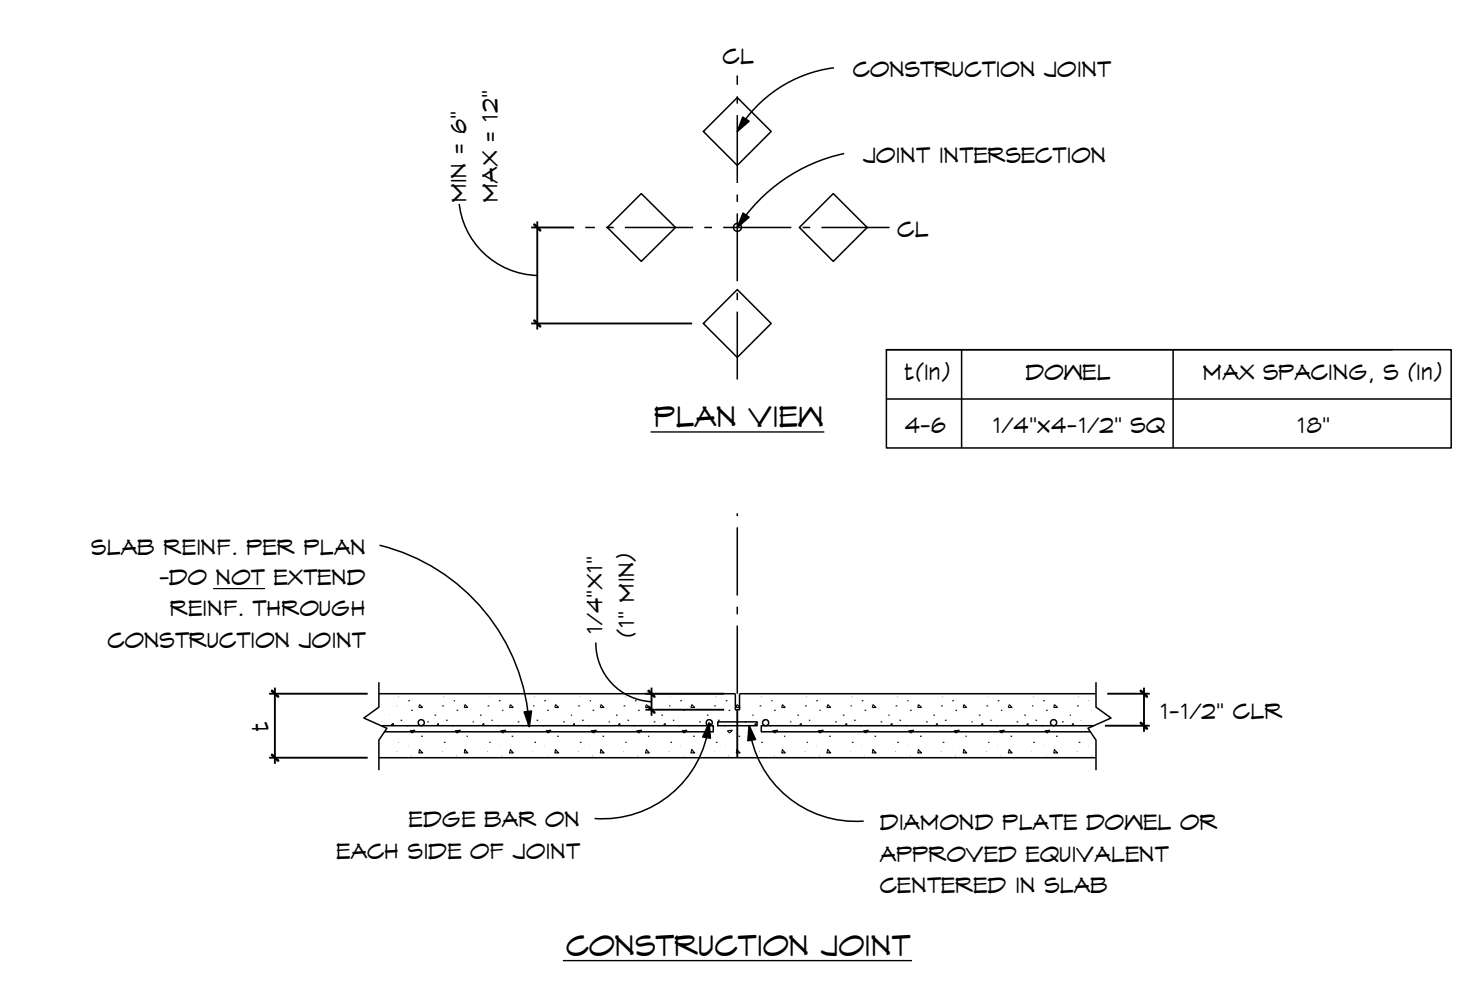


**12** TYP. CONSTRUCTION JOINT DETAIL  
Scale 1" = 1'-0"

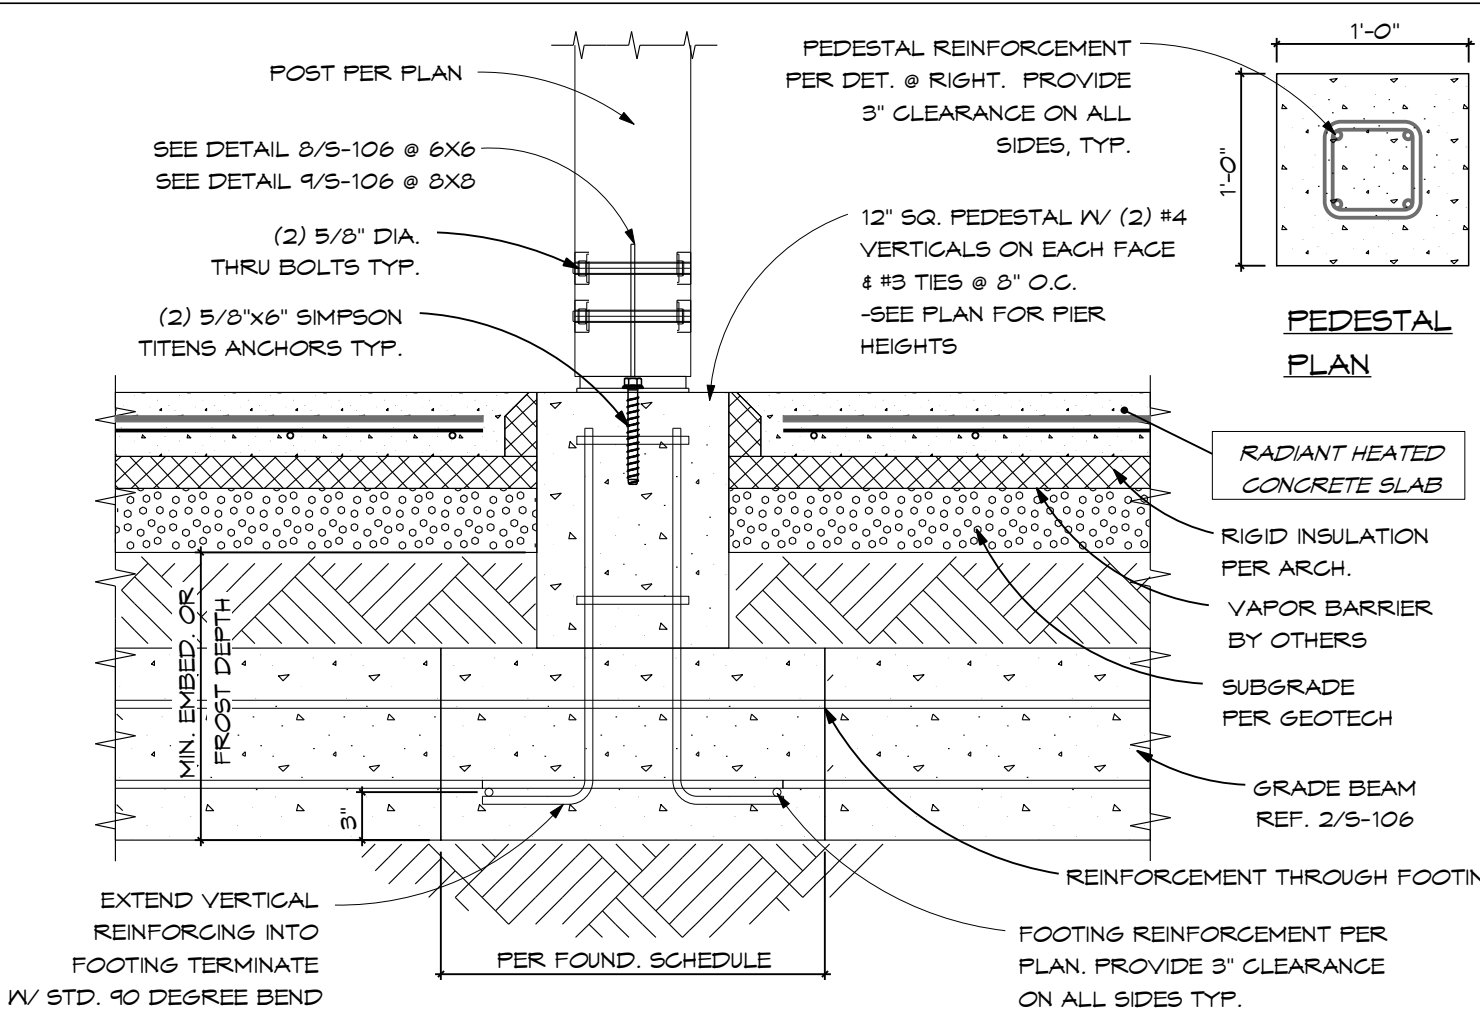


**5** PEDESTAL DETAIL W/ SLAB @ GRADE BEAM  
Scale 1" = 1'-0"

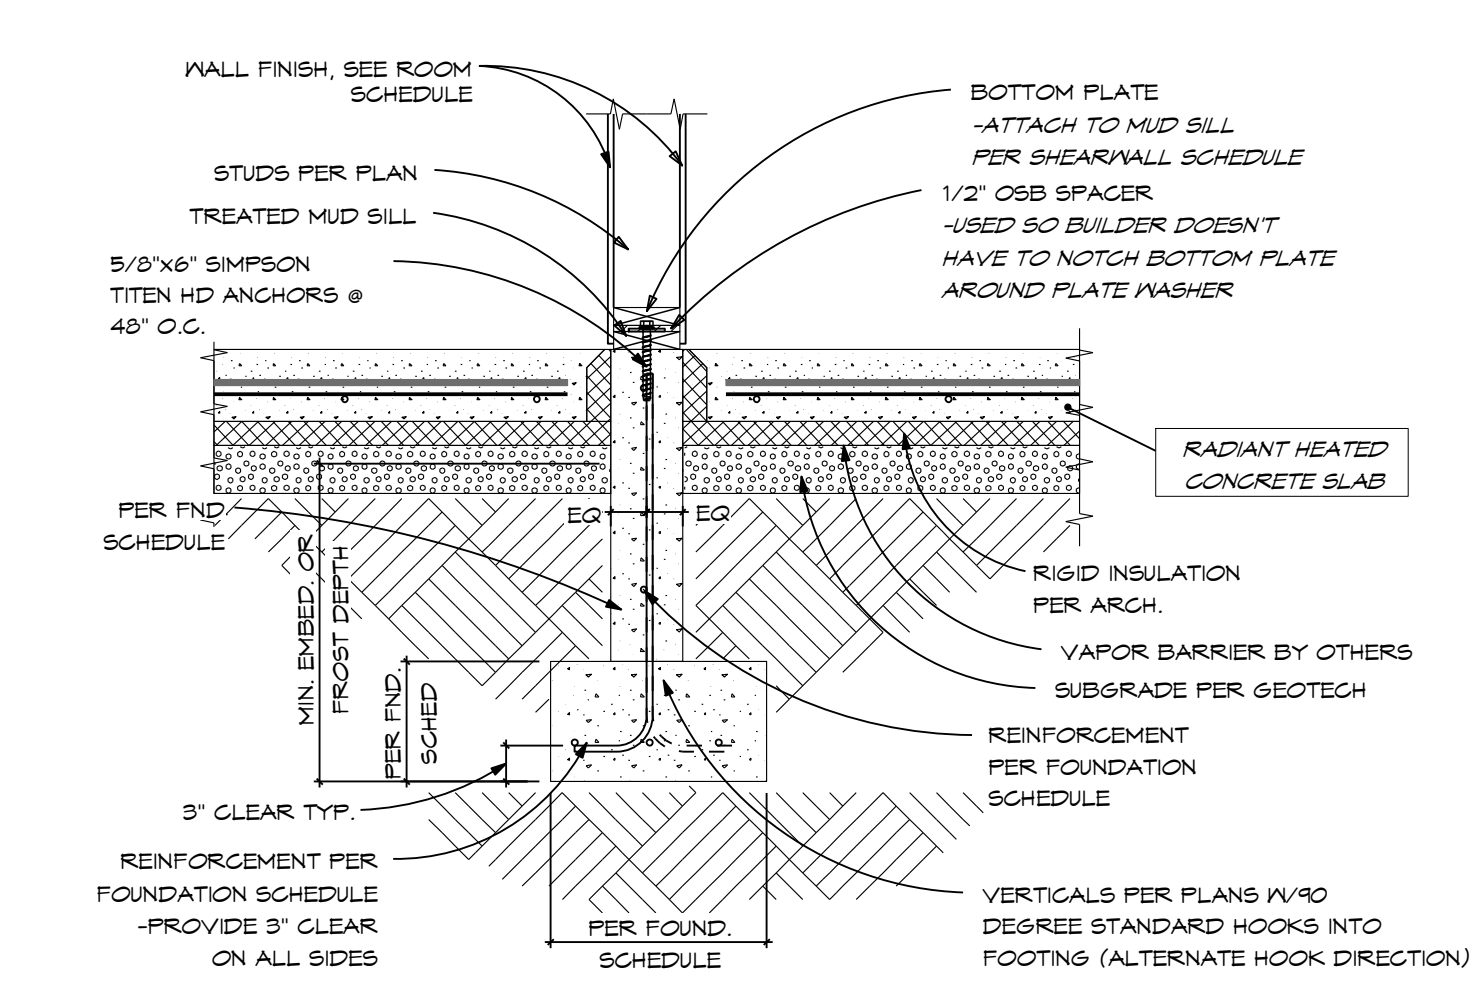


**6** INTERIOR FOOTING DETAIL  
Scale 1" = 1'-0"

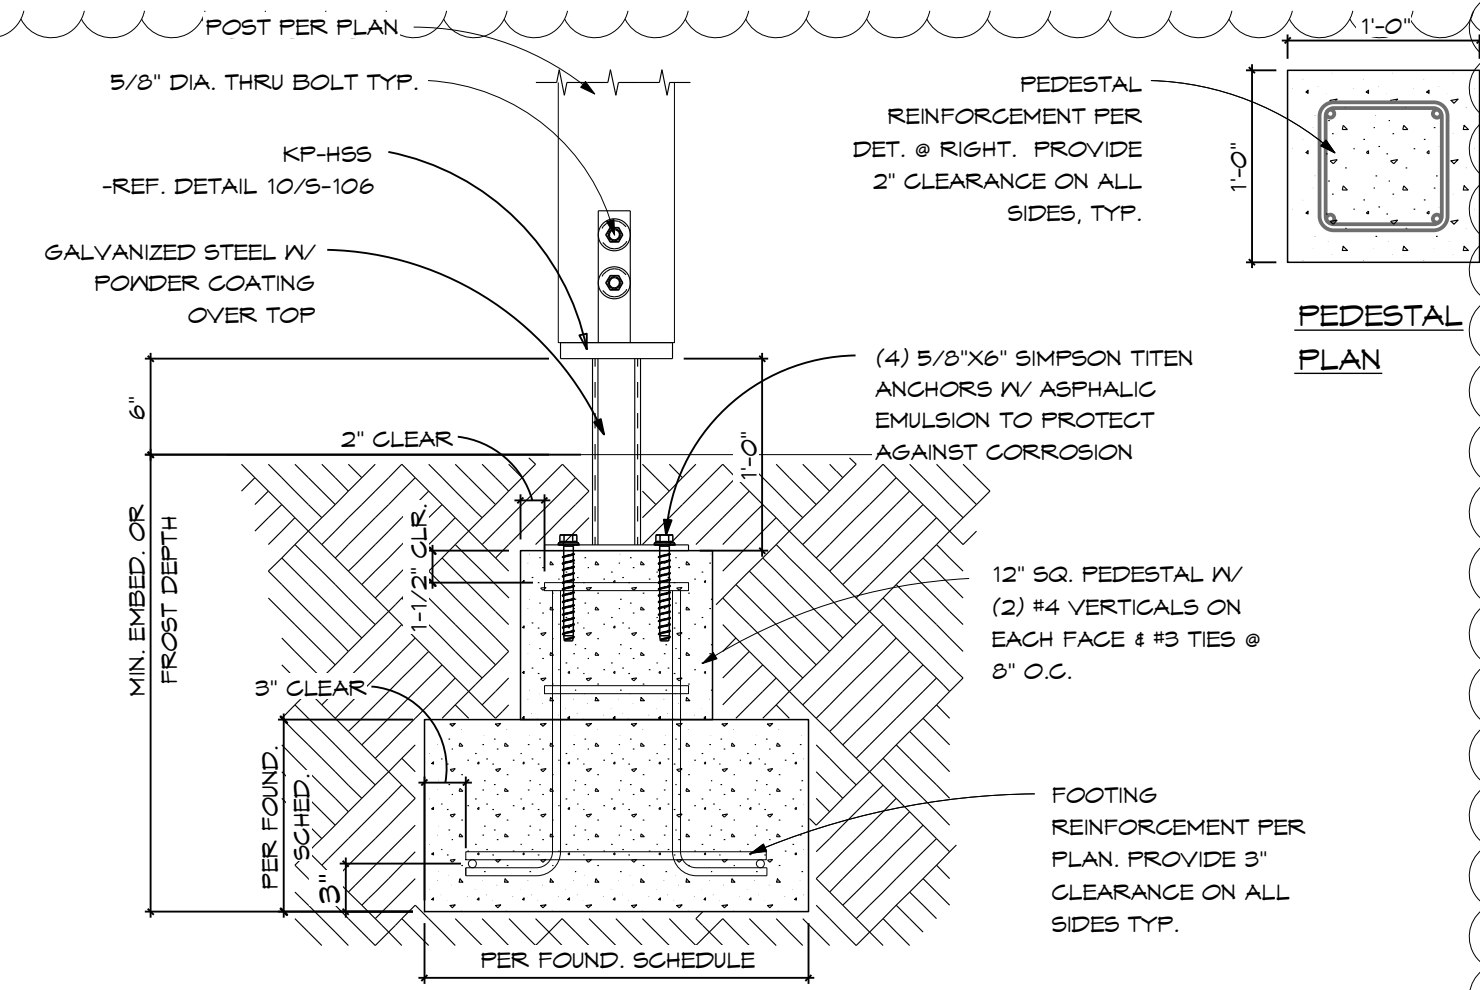


**7** HSS PEDESTAL DETAIL W/OUT SLAB  
Scale 1" = 1'-0"

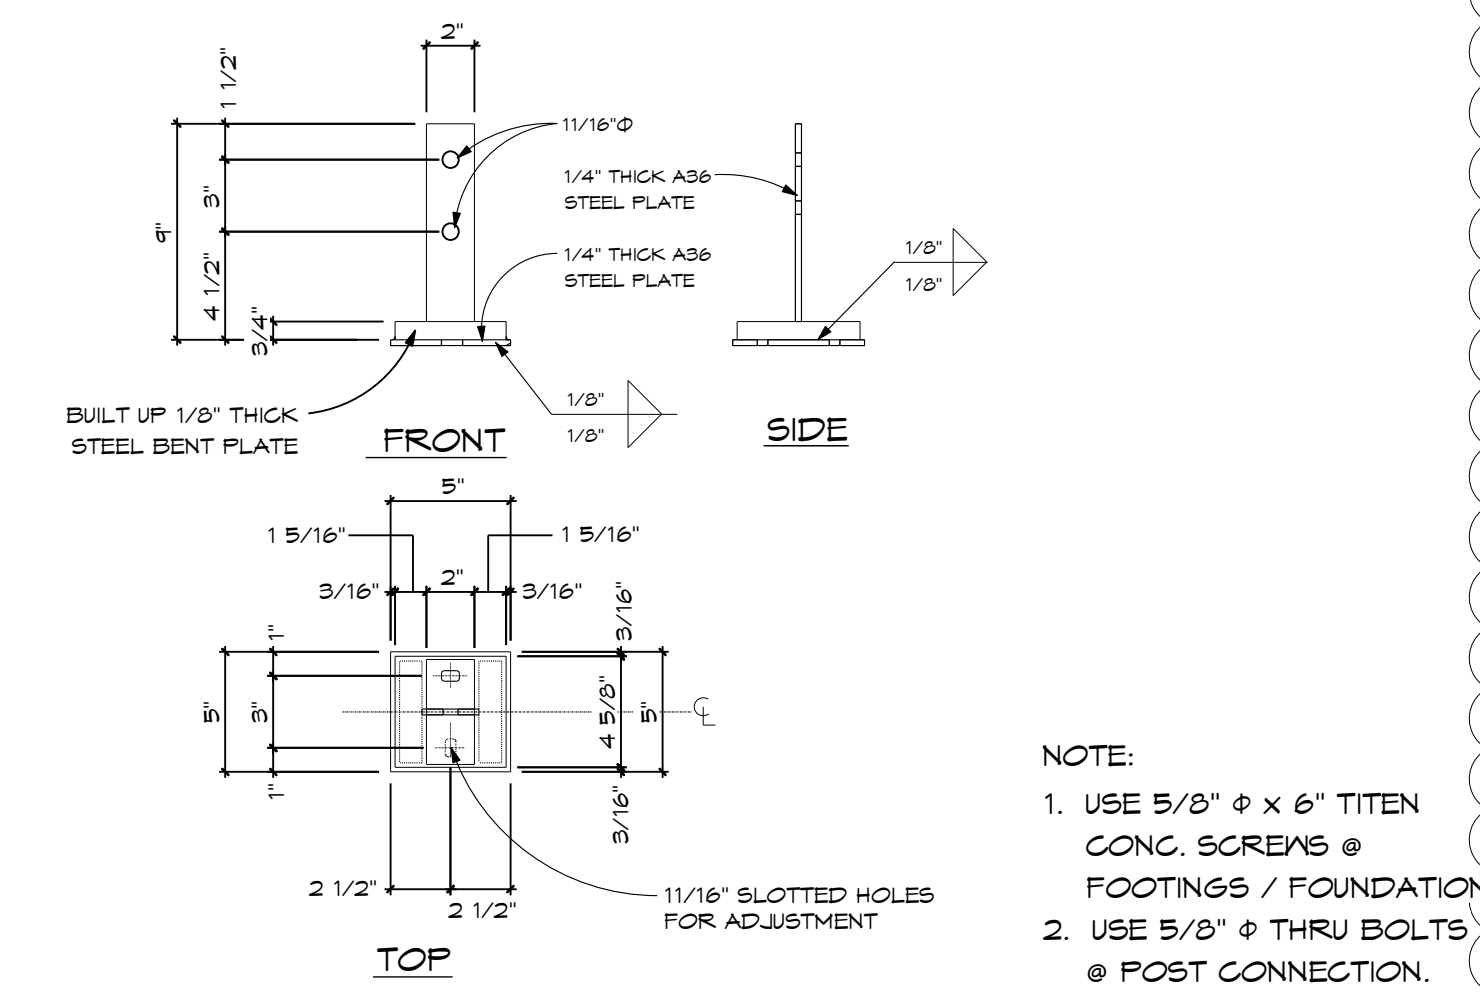


**8** POST BASE KNIFE PLATE 6x6 (KP55)  
Scale 1 1/2" = 1'-0"

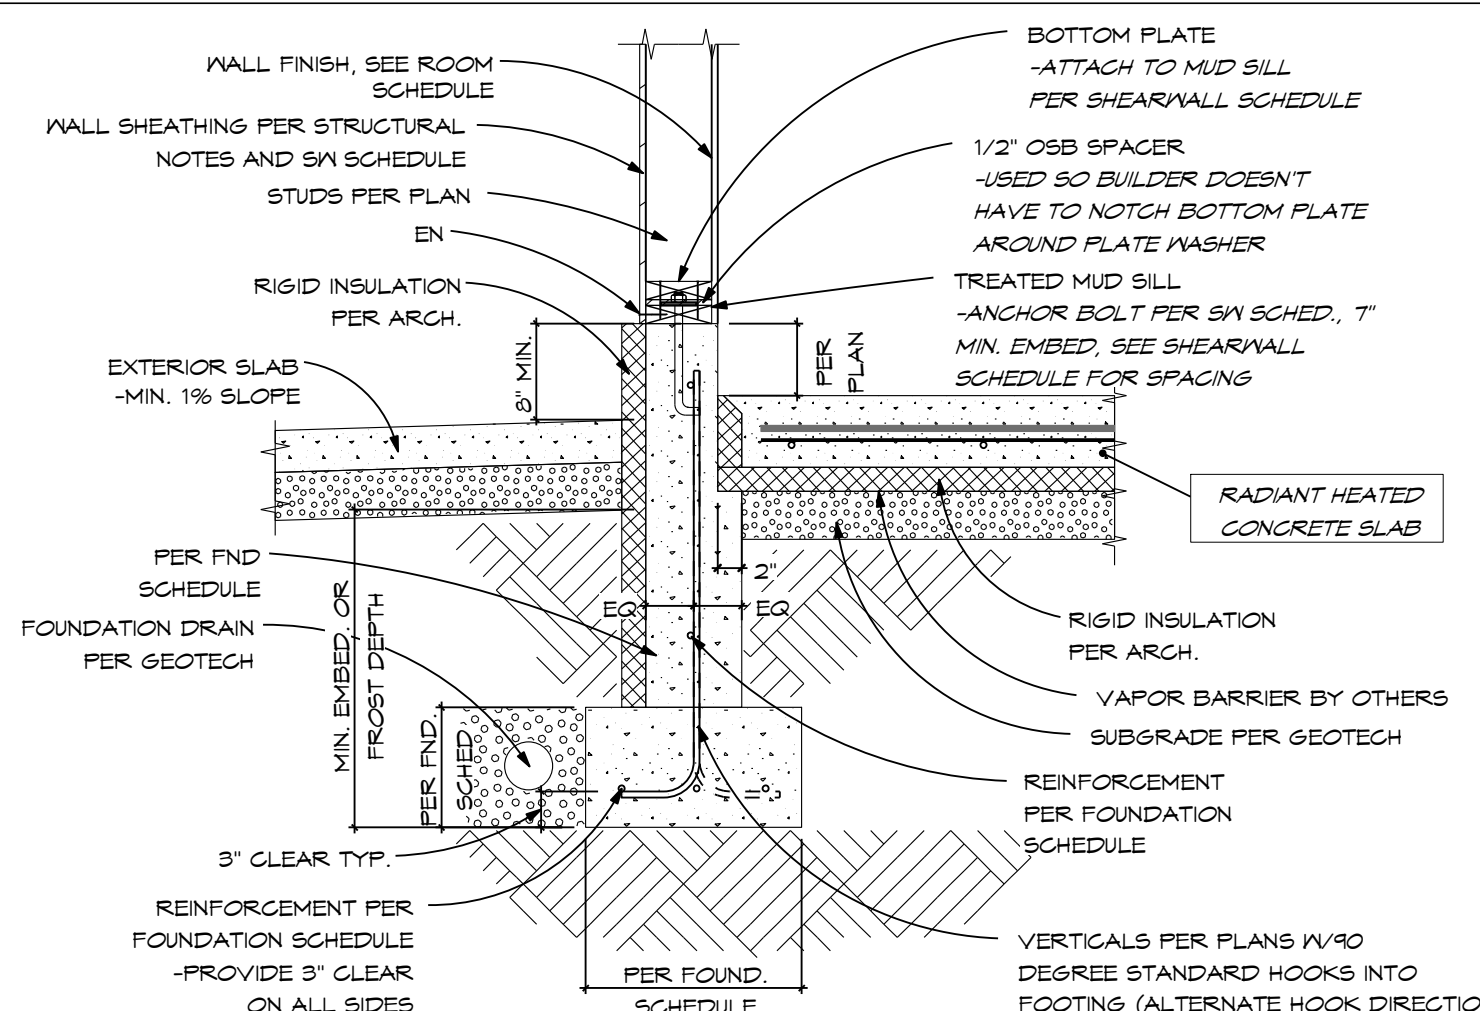


**1** SPREAD FOOTING W/ POURED WALL  
Scale 3/4" = 1'-0"

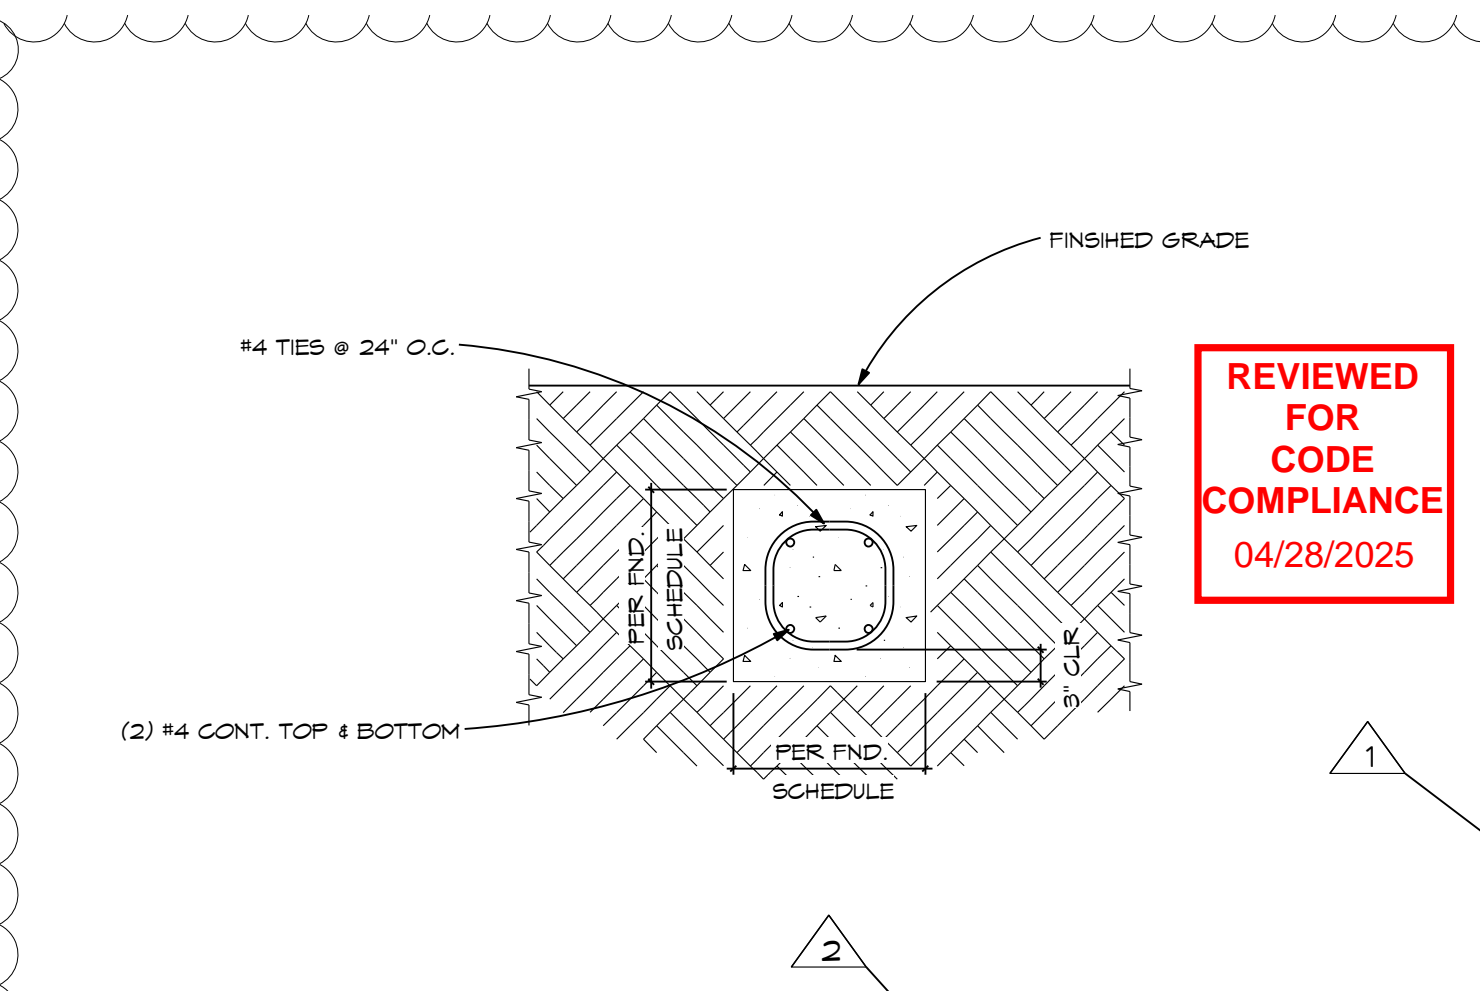

**2** TYP. GRADE BEAM  
Scale 1 1/4" = 1'-0"

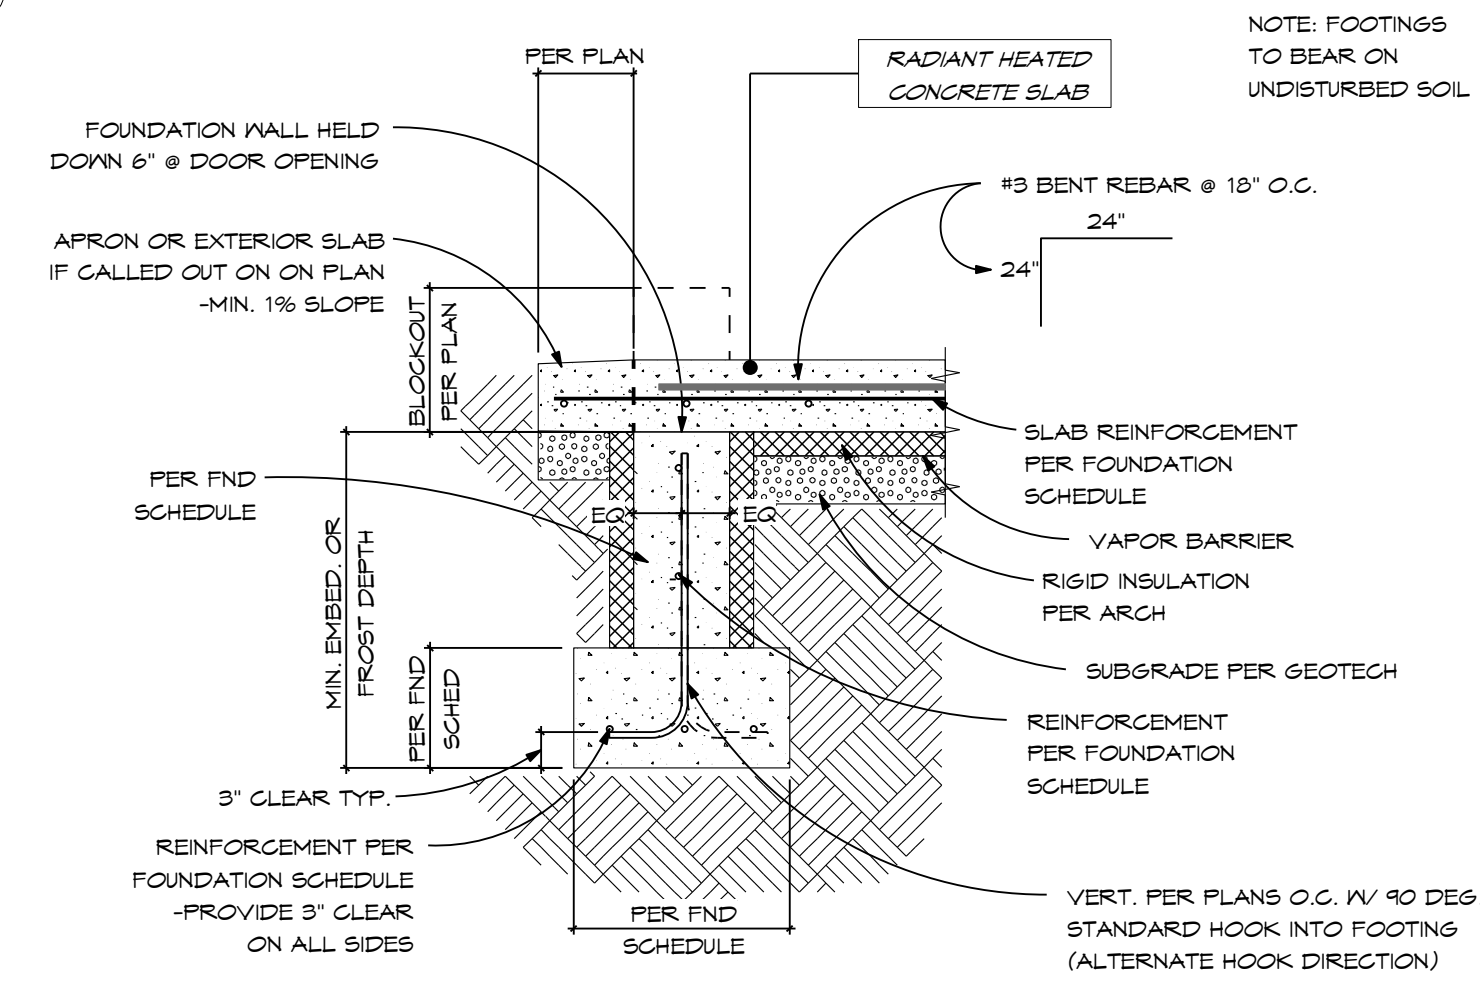

**3** SPREAD FOOTING W/ POURED WALL @ APRON/EXT. SLAB  
Scale 3/4" = 1'-0"

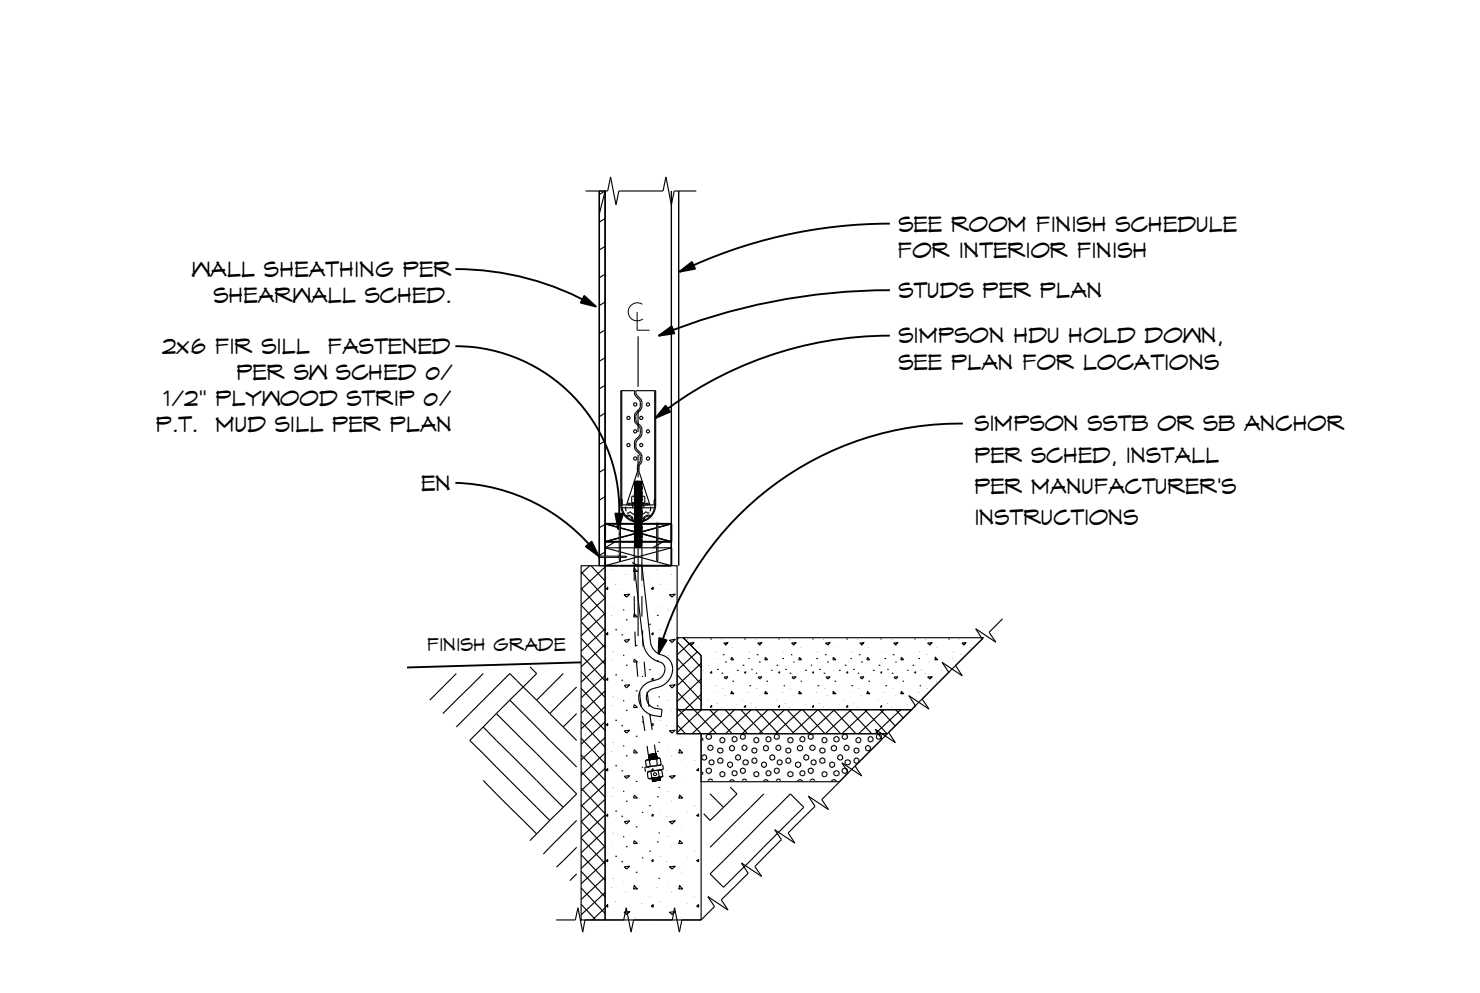

**4** SW HOLD DOWN DETAIL @ CONCRETE WALL (55TB/5B-AB)  
Scale 3/4" = 1'-0"

04/16/2025

53862

STRUCTURAL ONLY

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DAMASCUS, OR 97089

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ENGINEERING  
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1510 NW JEFFERSON ST., SUITE 200  
PORTLAND, OR 97209  
503.255.1229

**REVIEWED  
FOR  
CODE  
COMPLIANCE**

04/28/2025

Drawing Index		
No.	Date	Description
1	03.14.25	REV 1
2	04.15.25	REV 2

**OWNER INFORMATION**

LUKE & CARISSA  
BERLET

**BERLET  
'SHASTA'**


38980 MAIN STREET  
MILNER, CO 80477

**FOUNDATION  
DETAILS**


**S-106**

DRAWN BY  
RJP  
04/15/2025




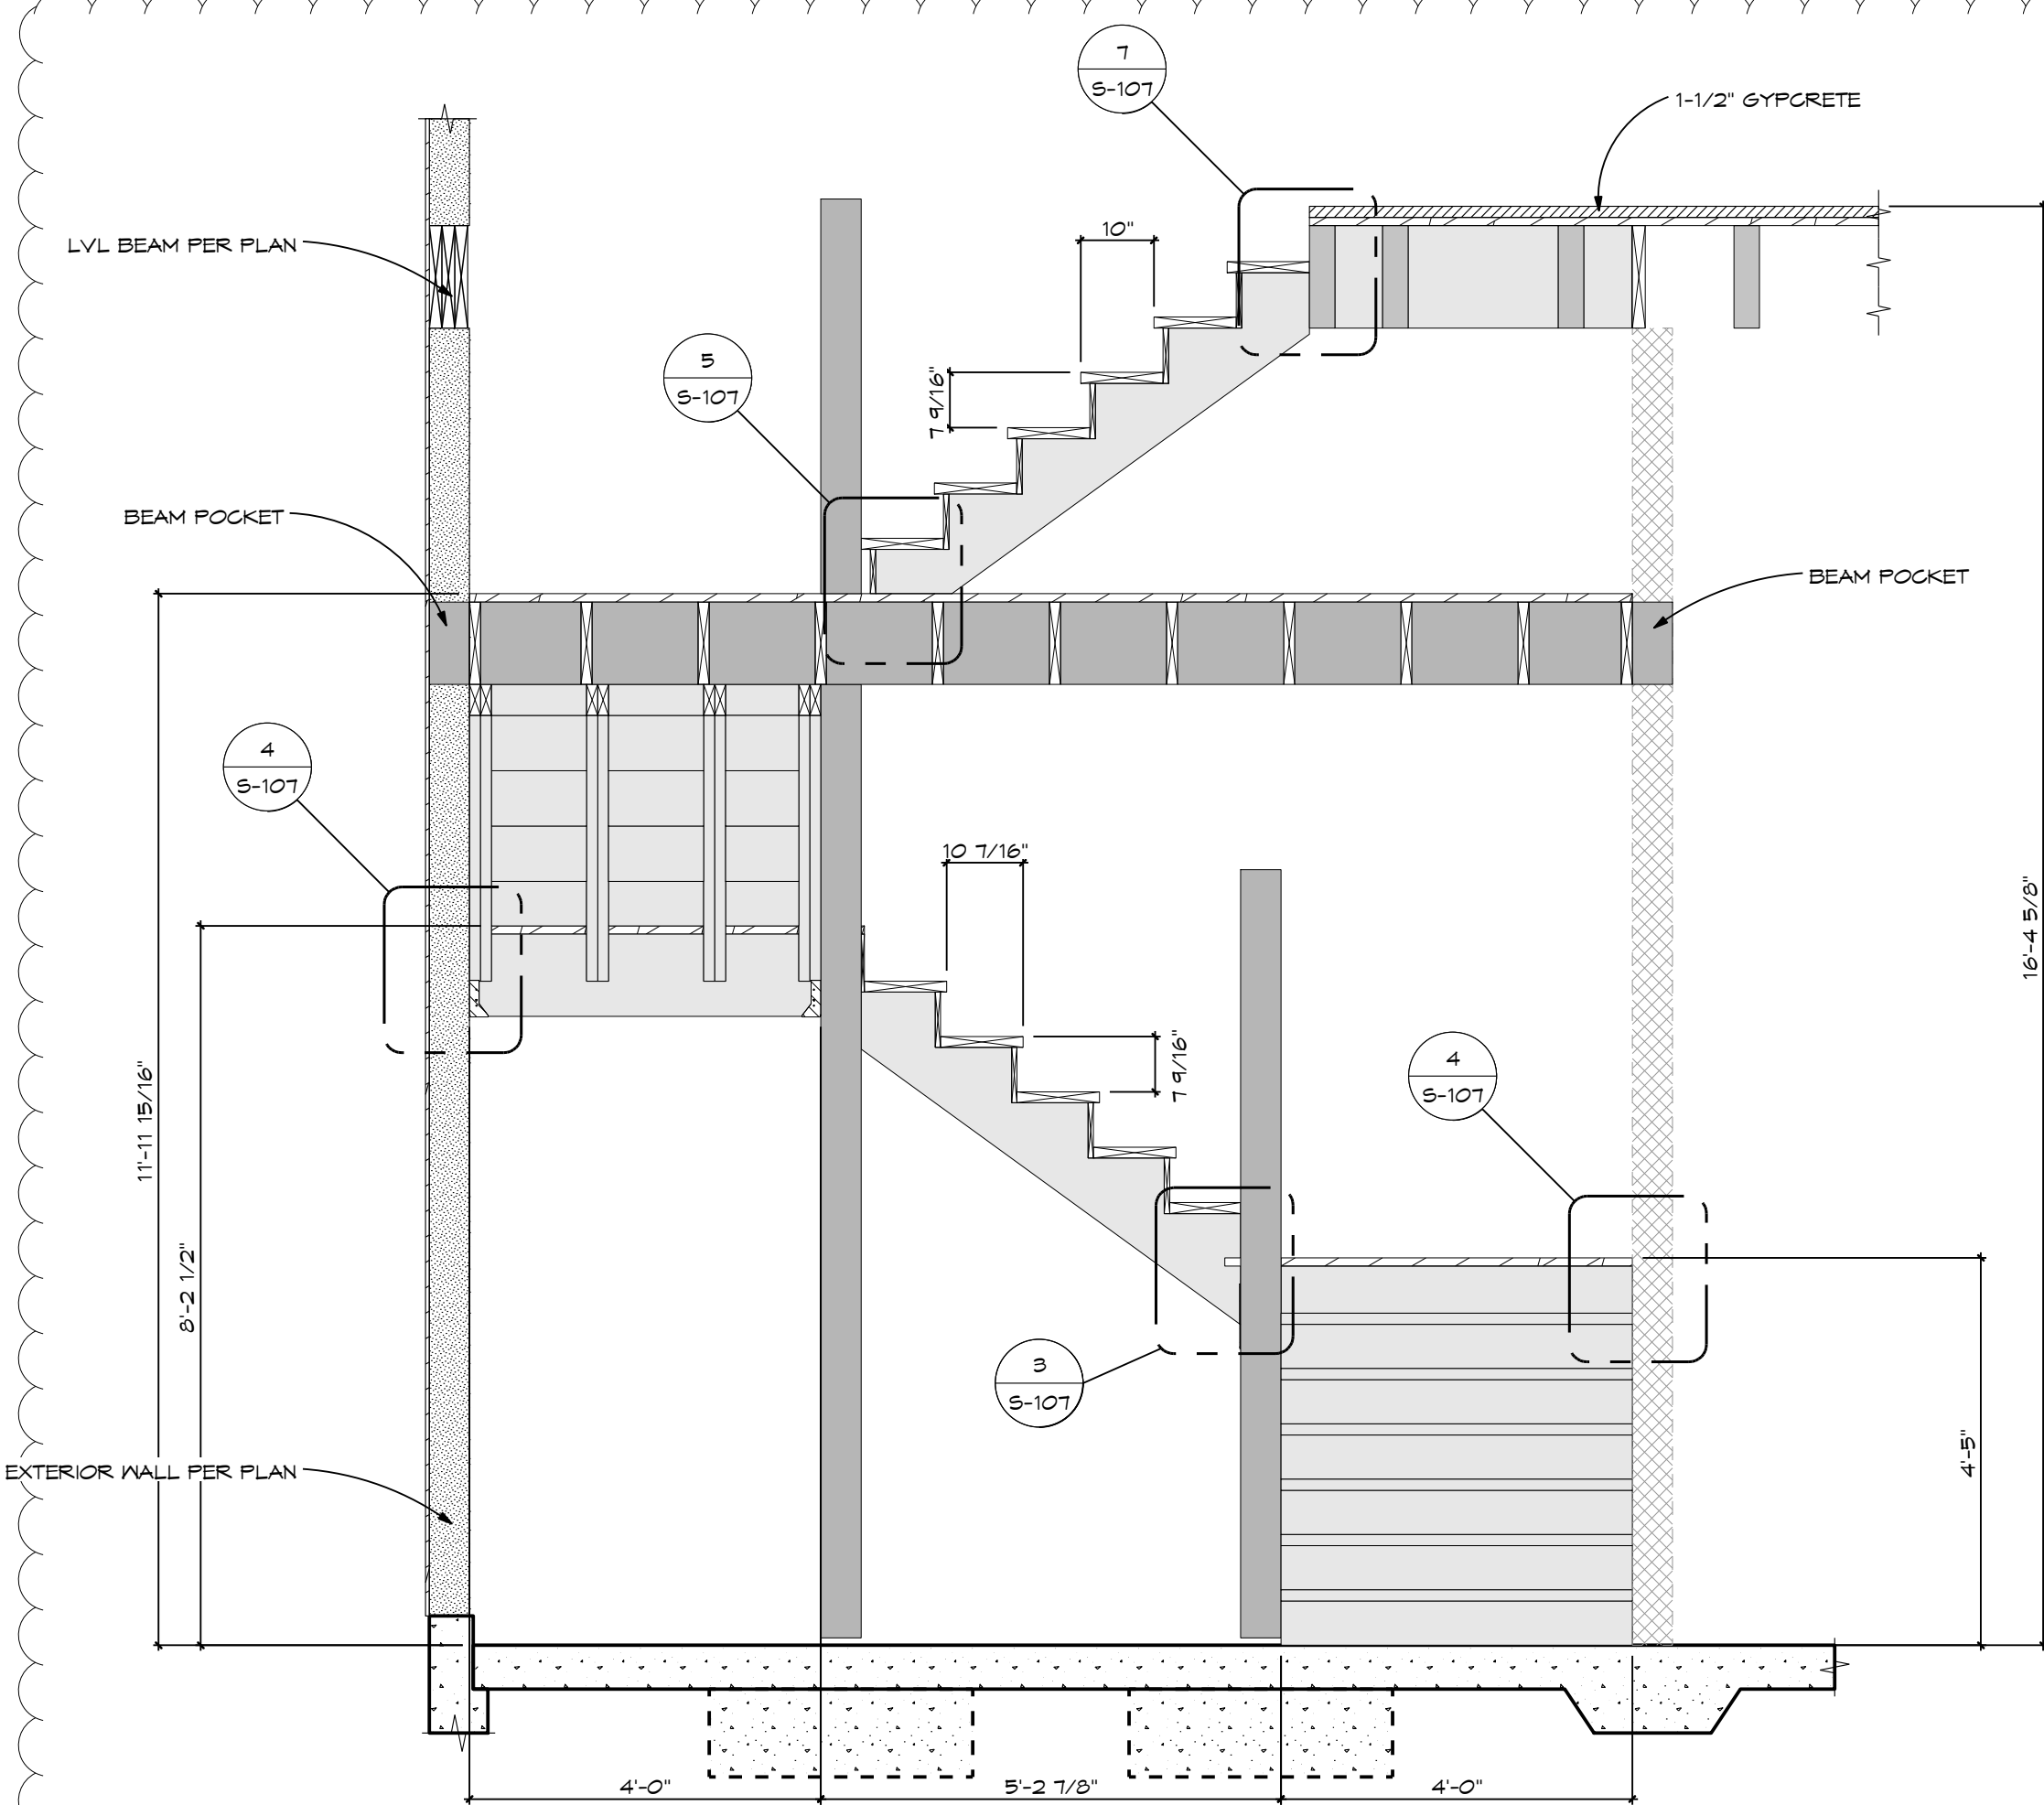


**8 INTERIOR STAIR SECTION**  
Scale 1/2" = 1'-0"

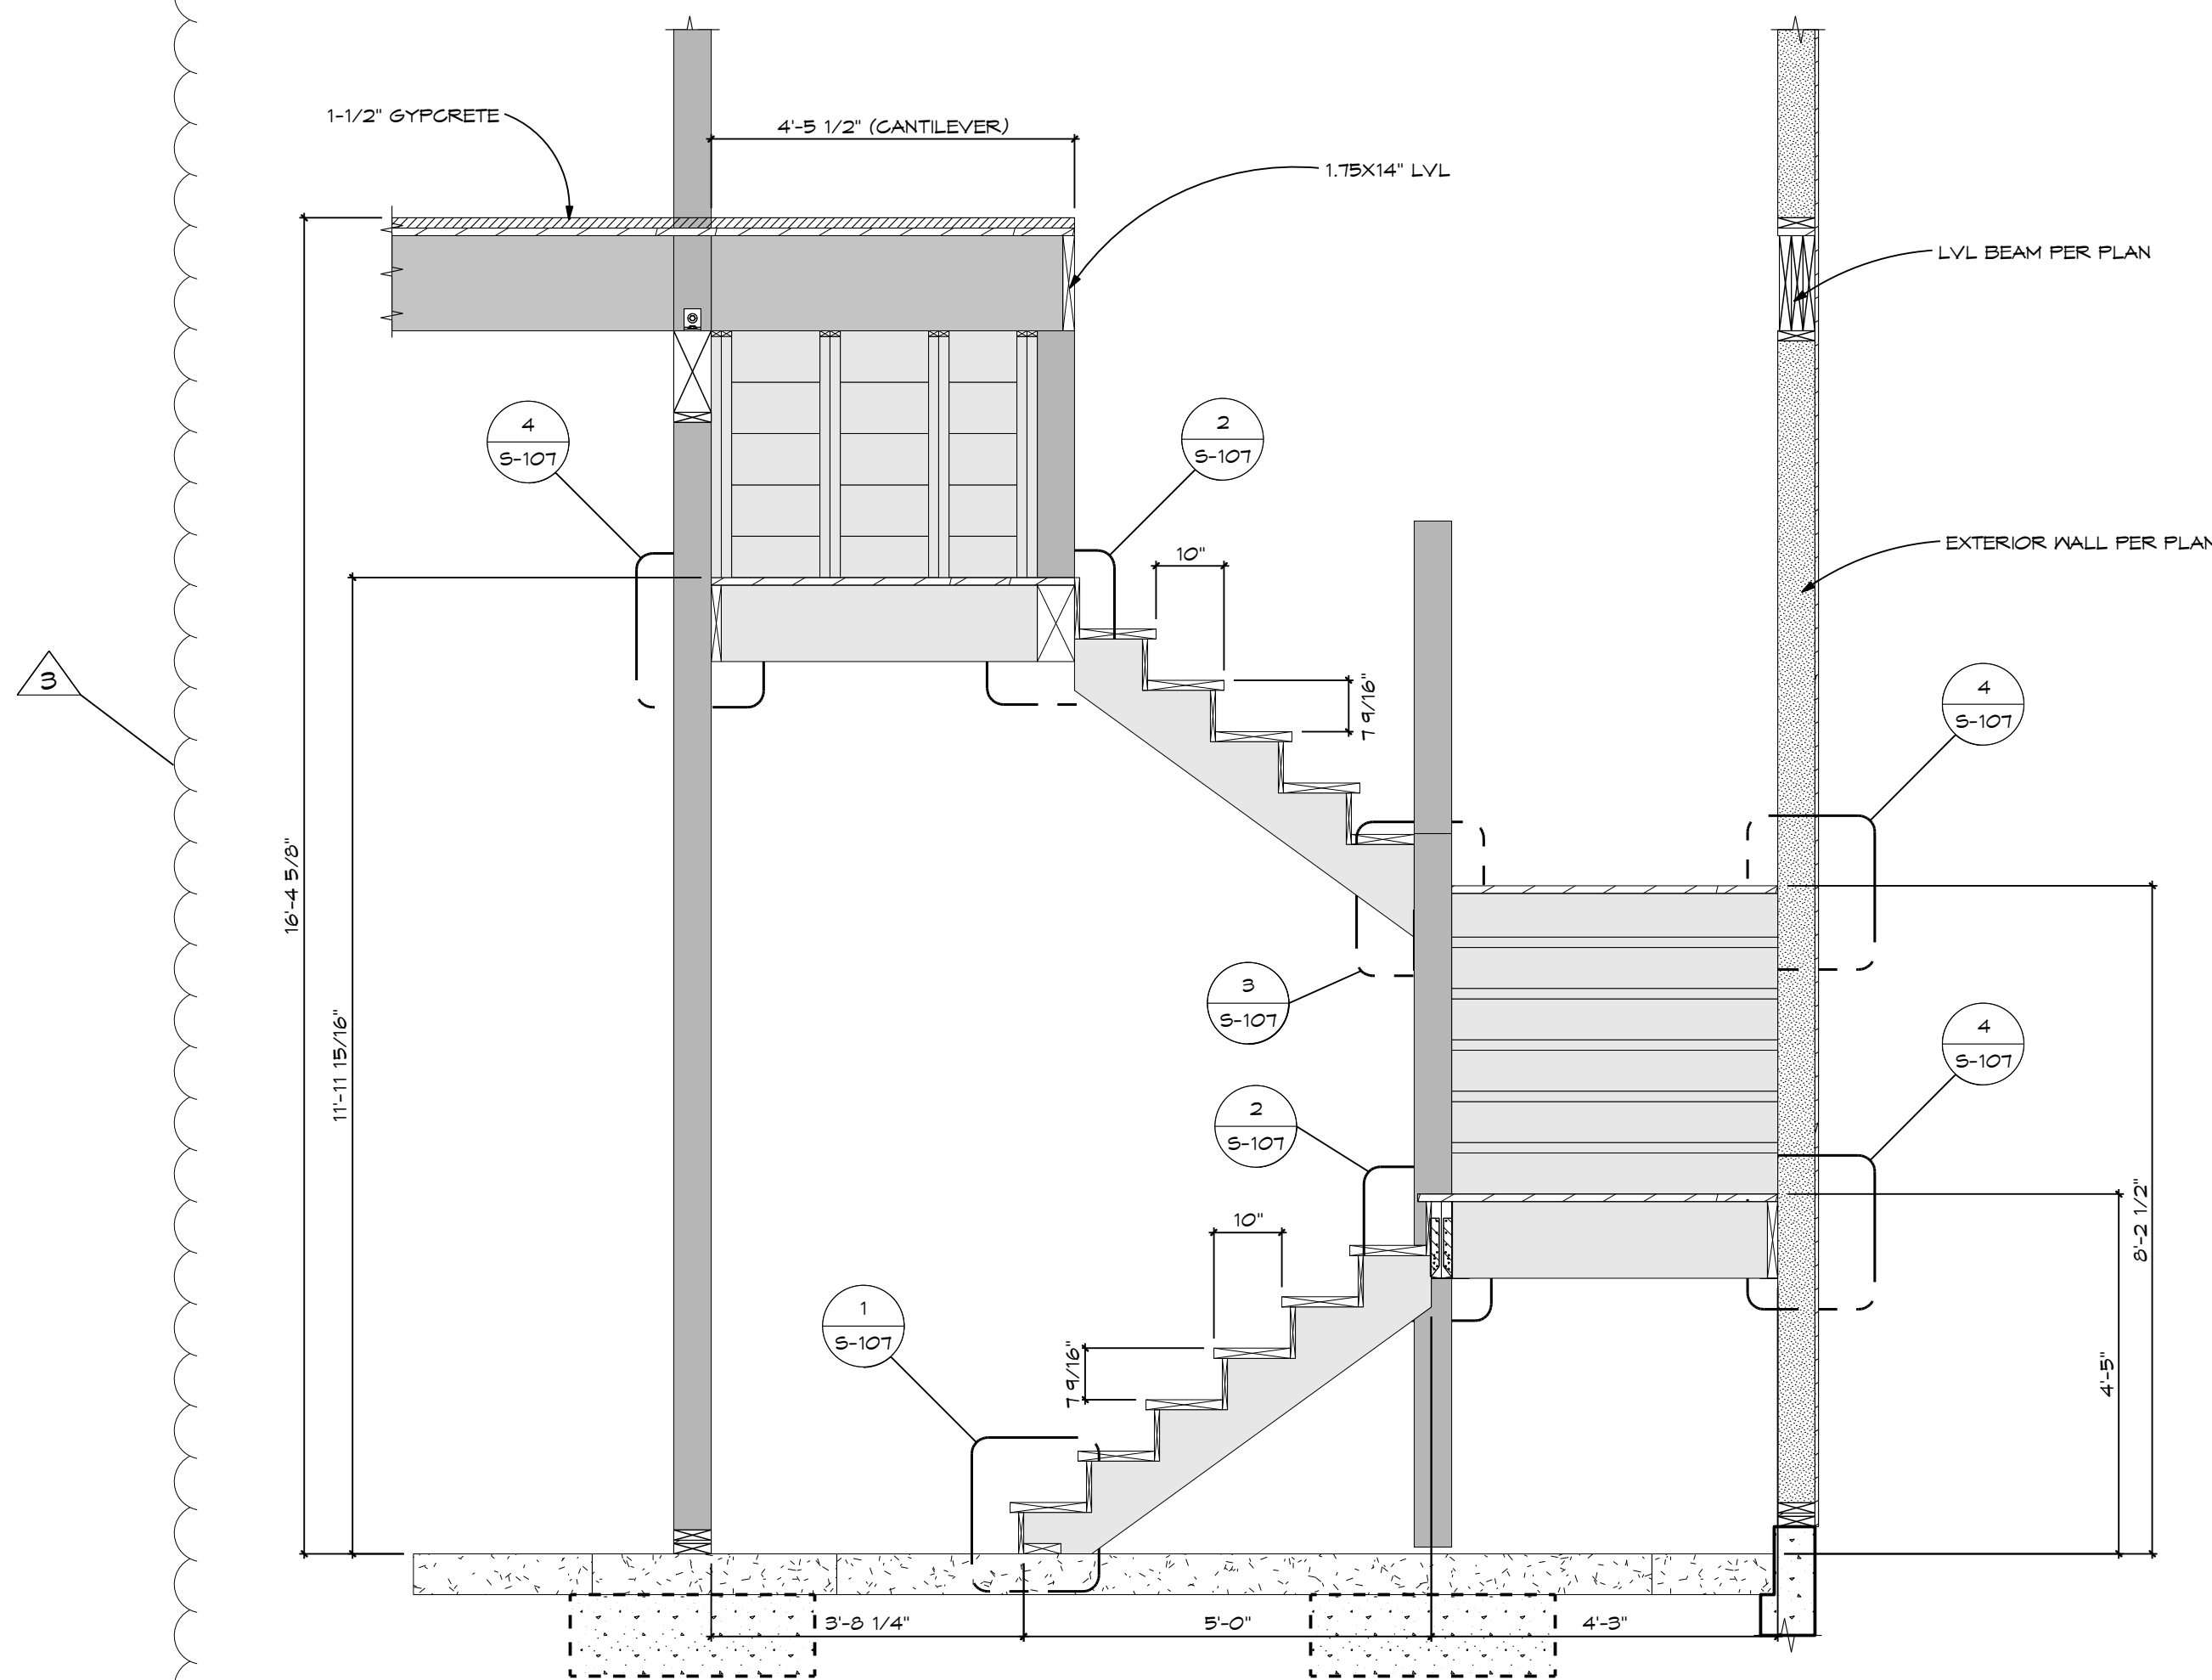


**9 INTERIOR STAIR SECTION**  
Scale 1/2" = 1'-0"

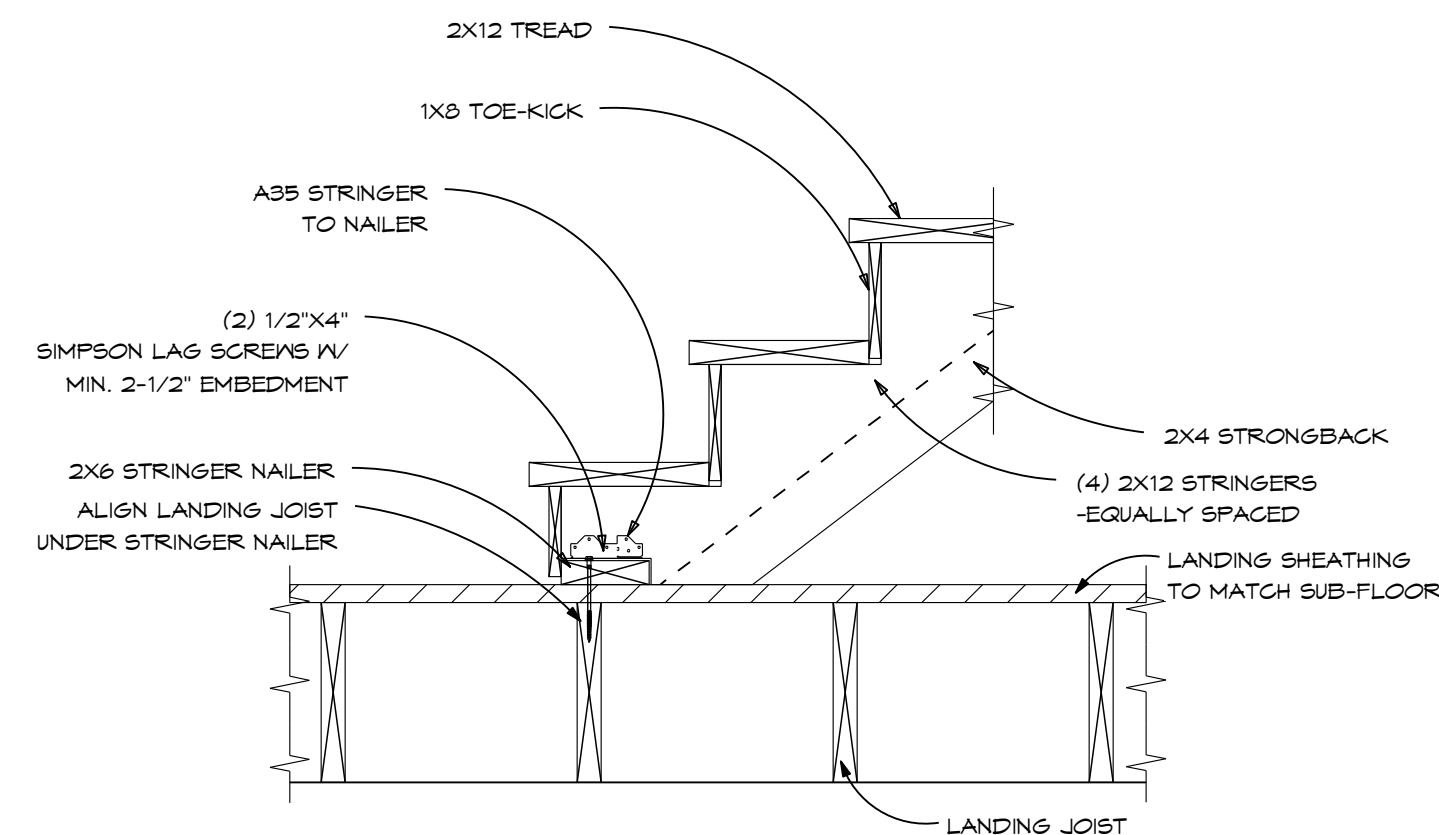


**5 STRINGER TO LANDING DETAIL**  
Scale 1" = 1'-0"

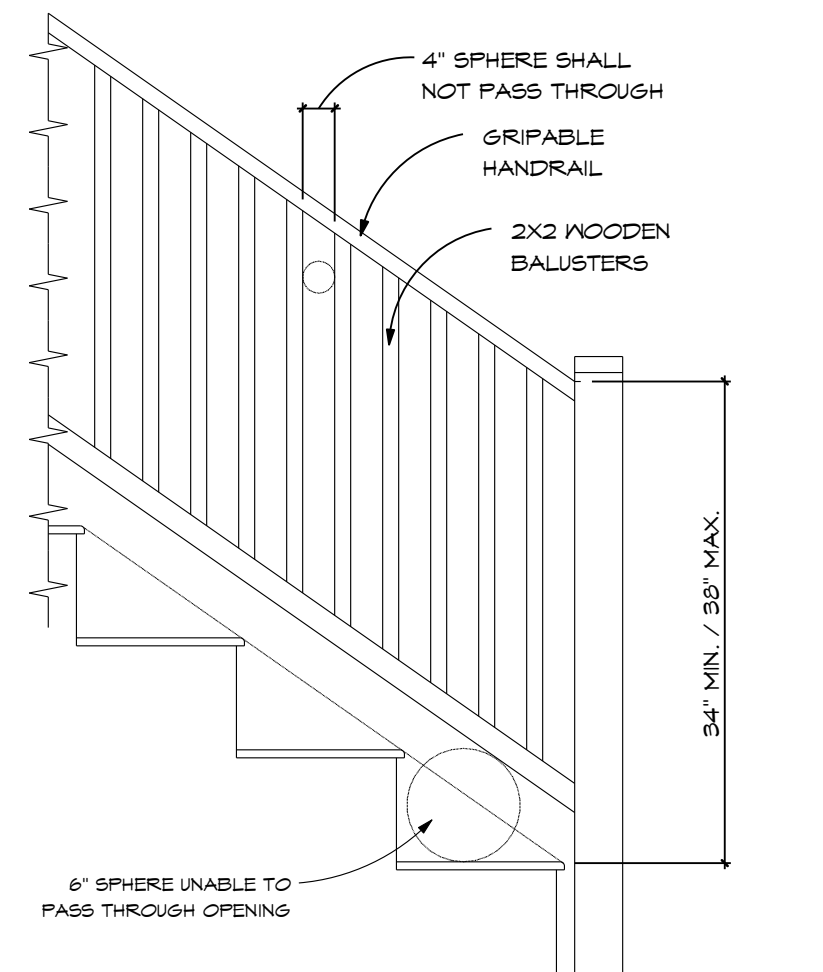


**6 GUARDRAIL DETAIL @ STAIR STRINGER**  
Scale 1/2" = 1'-0"

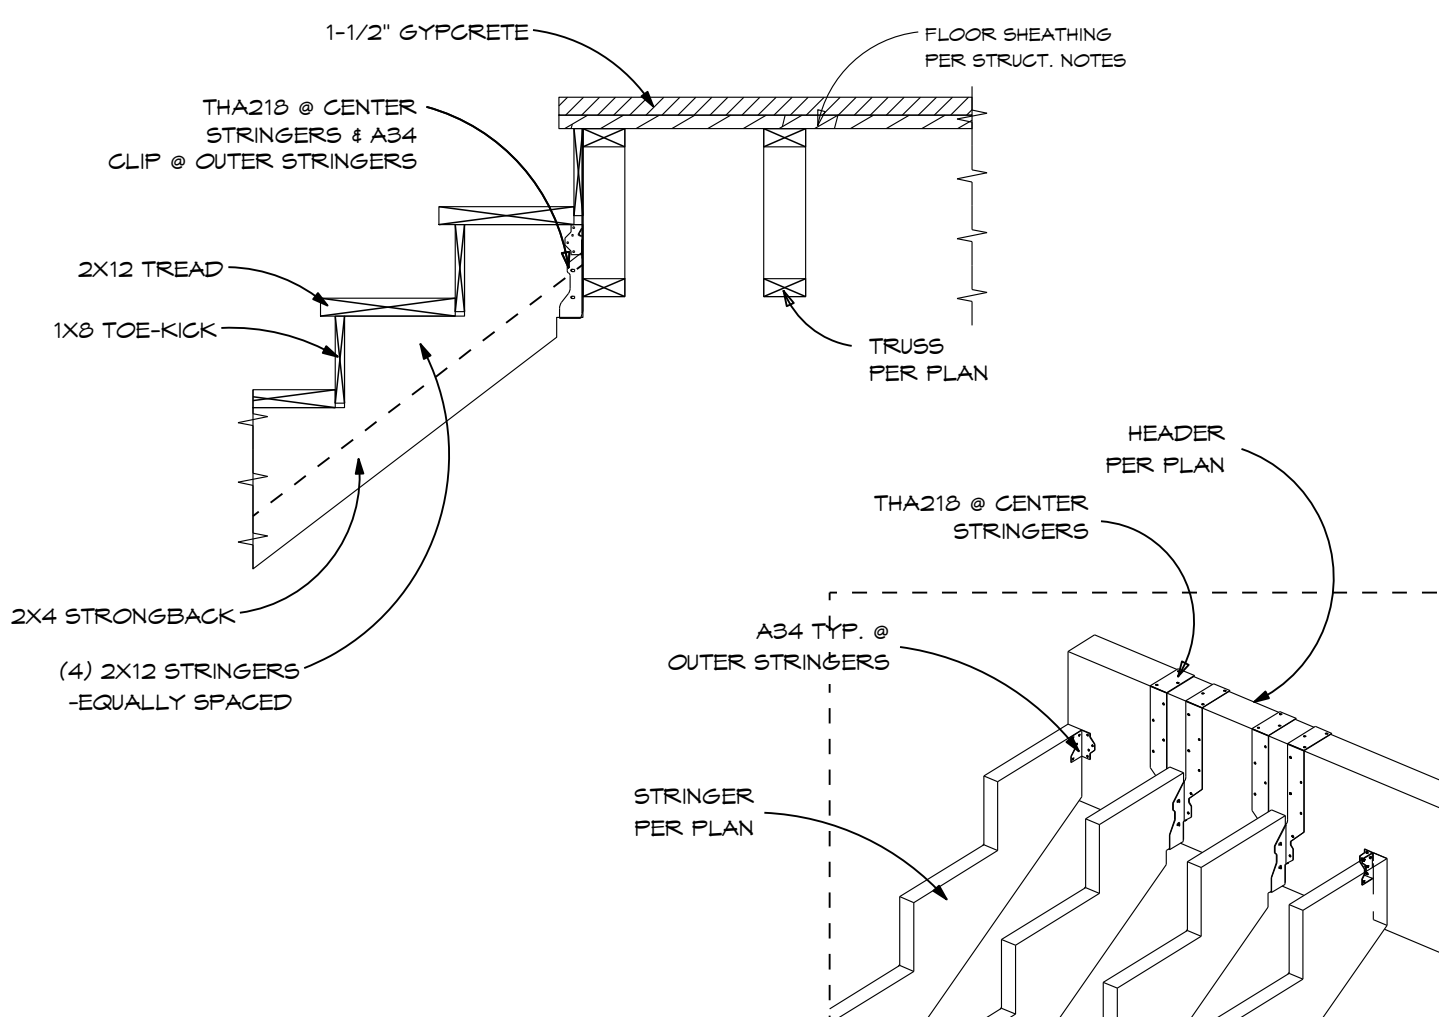


**7 STRINGER TO UPPER FLOOR HEADER**  
Scale 3/4" = 1'-0"

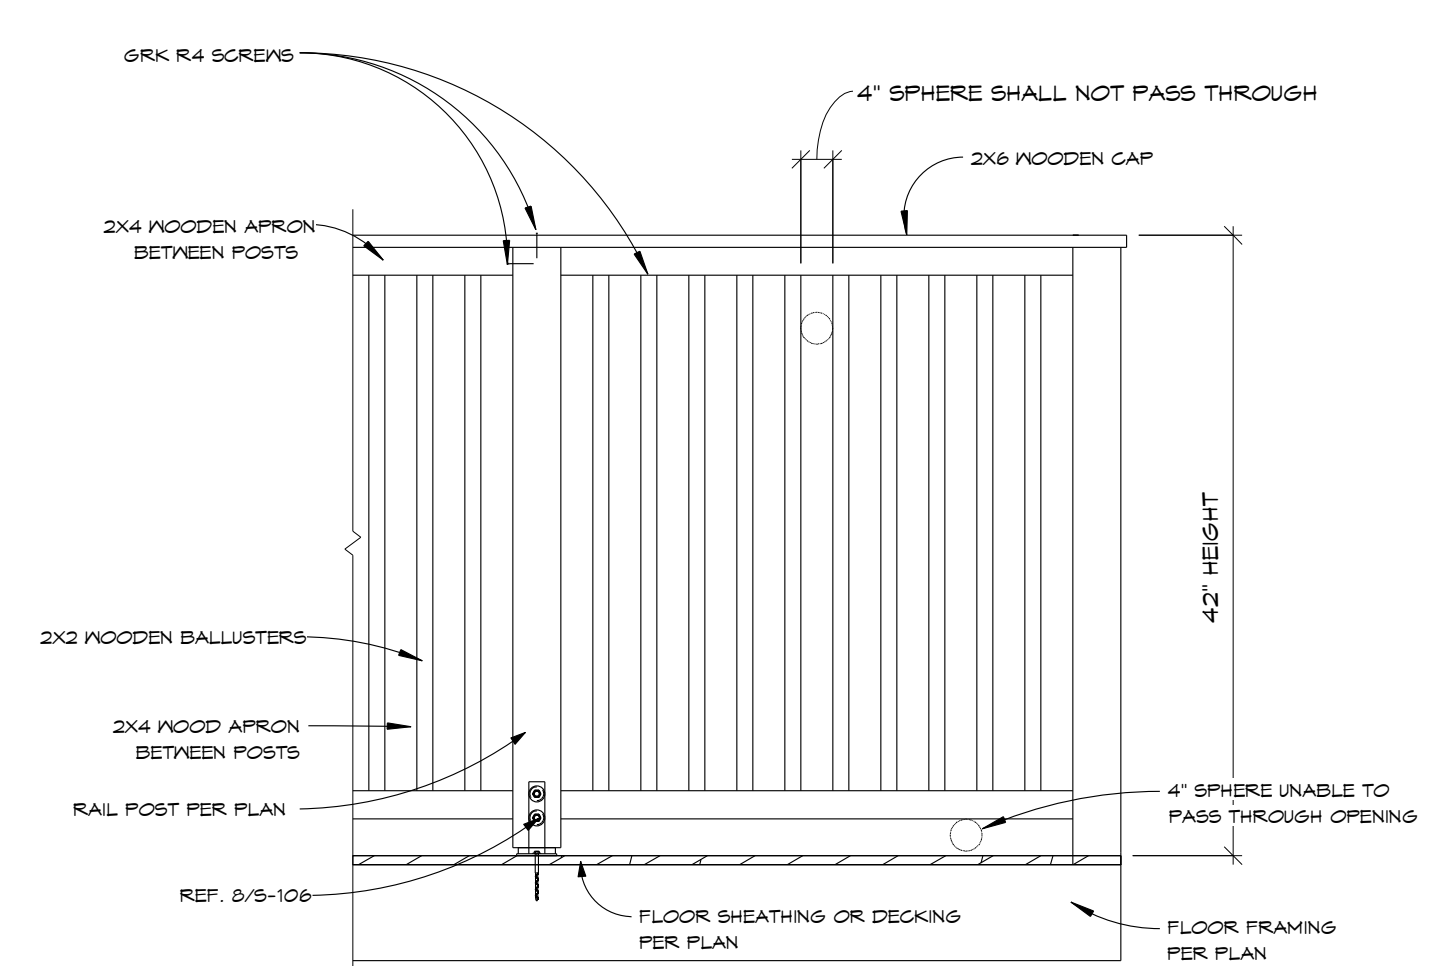


**8 GUARDRAIL DETAIL @ FLOOR EDGE**  
Scale 1/2" = 1'-0"

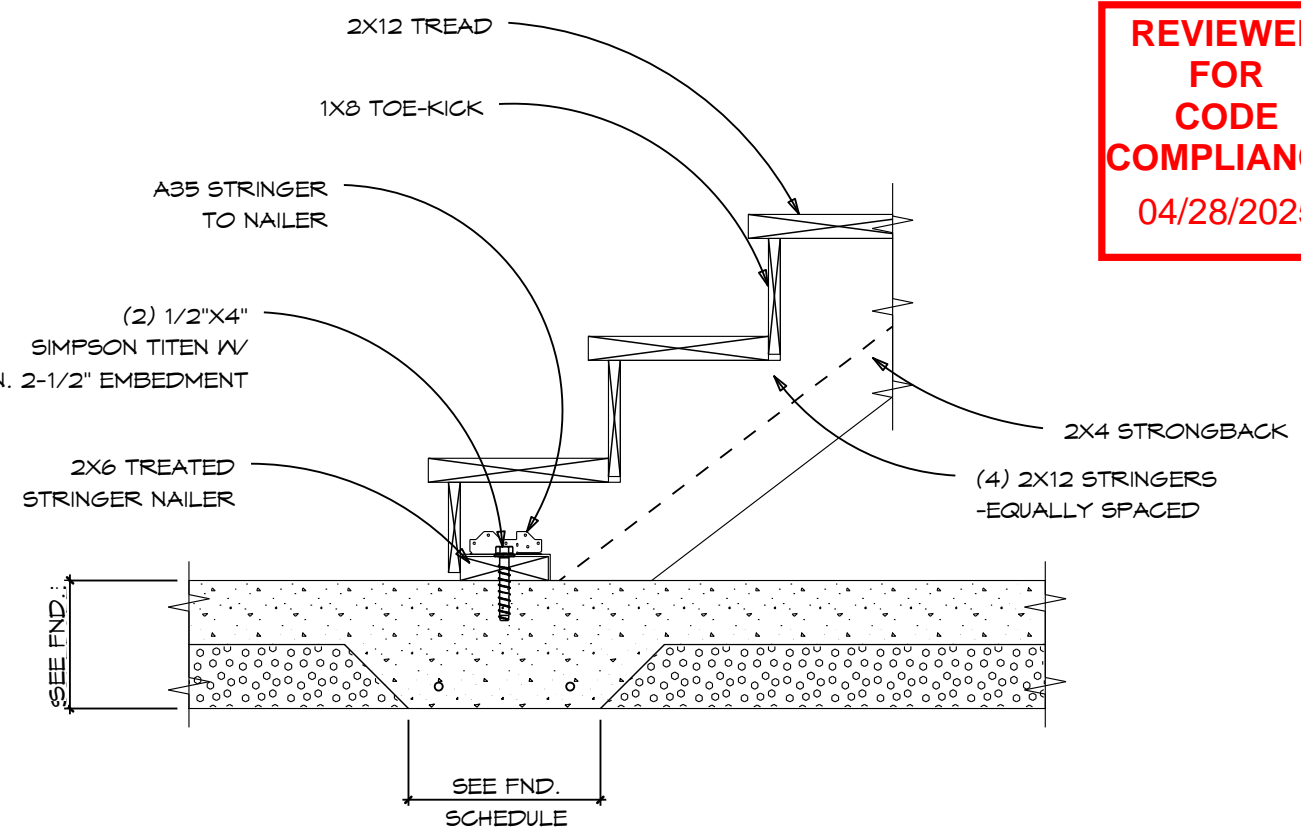


**1 STRINGER TO CONCRETE DETAIL**  
Scale 1" = 1'-0"

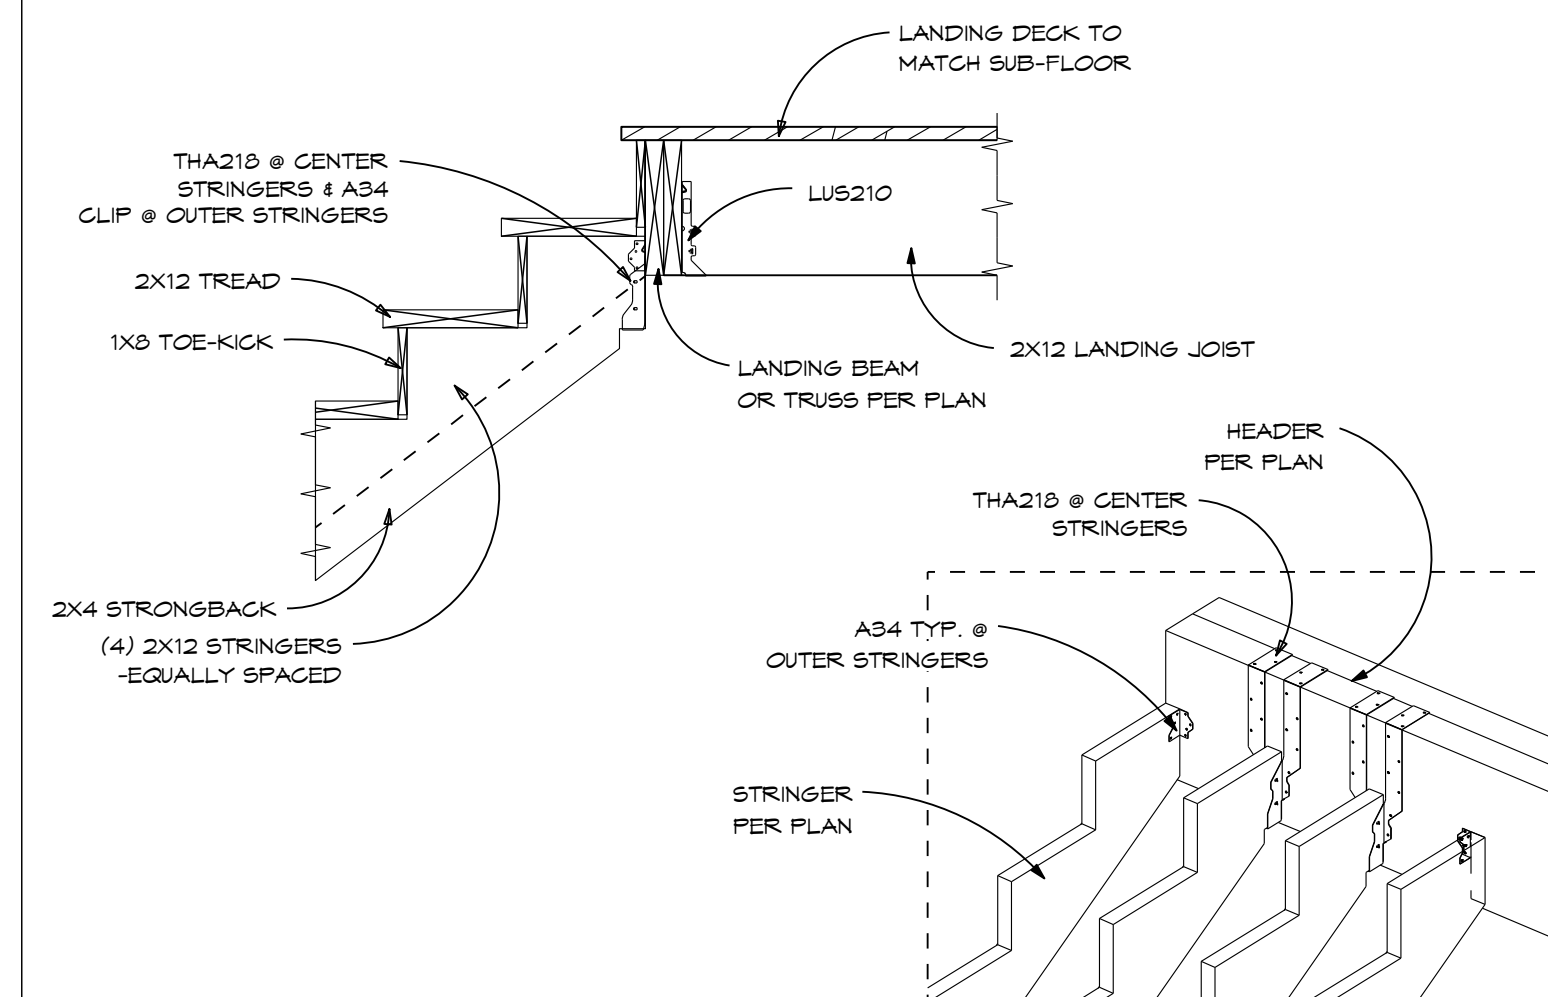

**2 LOWER STRINGER TO LANDING DETAIL**  
Scale 3/4" = 1'-0"

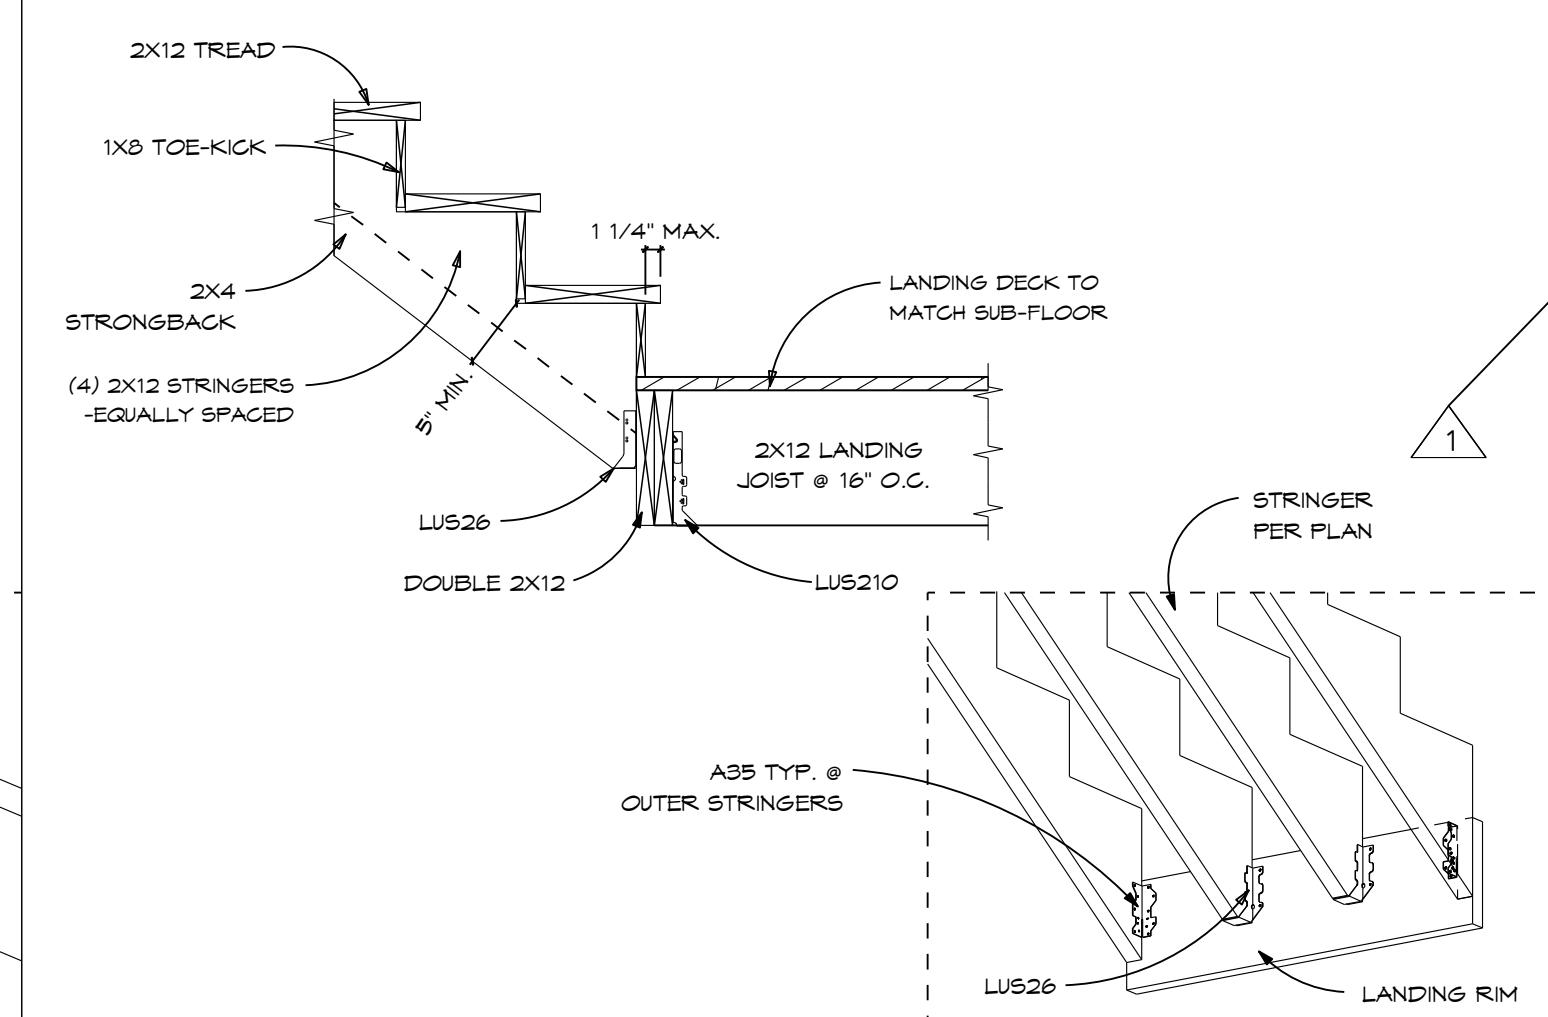


**3 UPPER STRINGER TO LANDING DETAIL**  
Scale 3/4" = 1'-0"

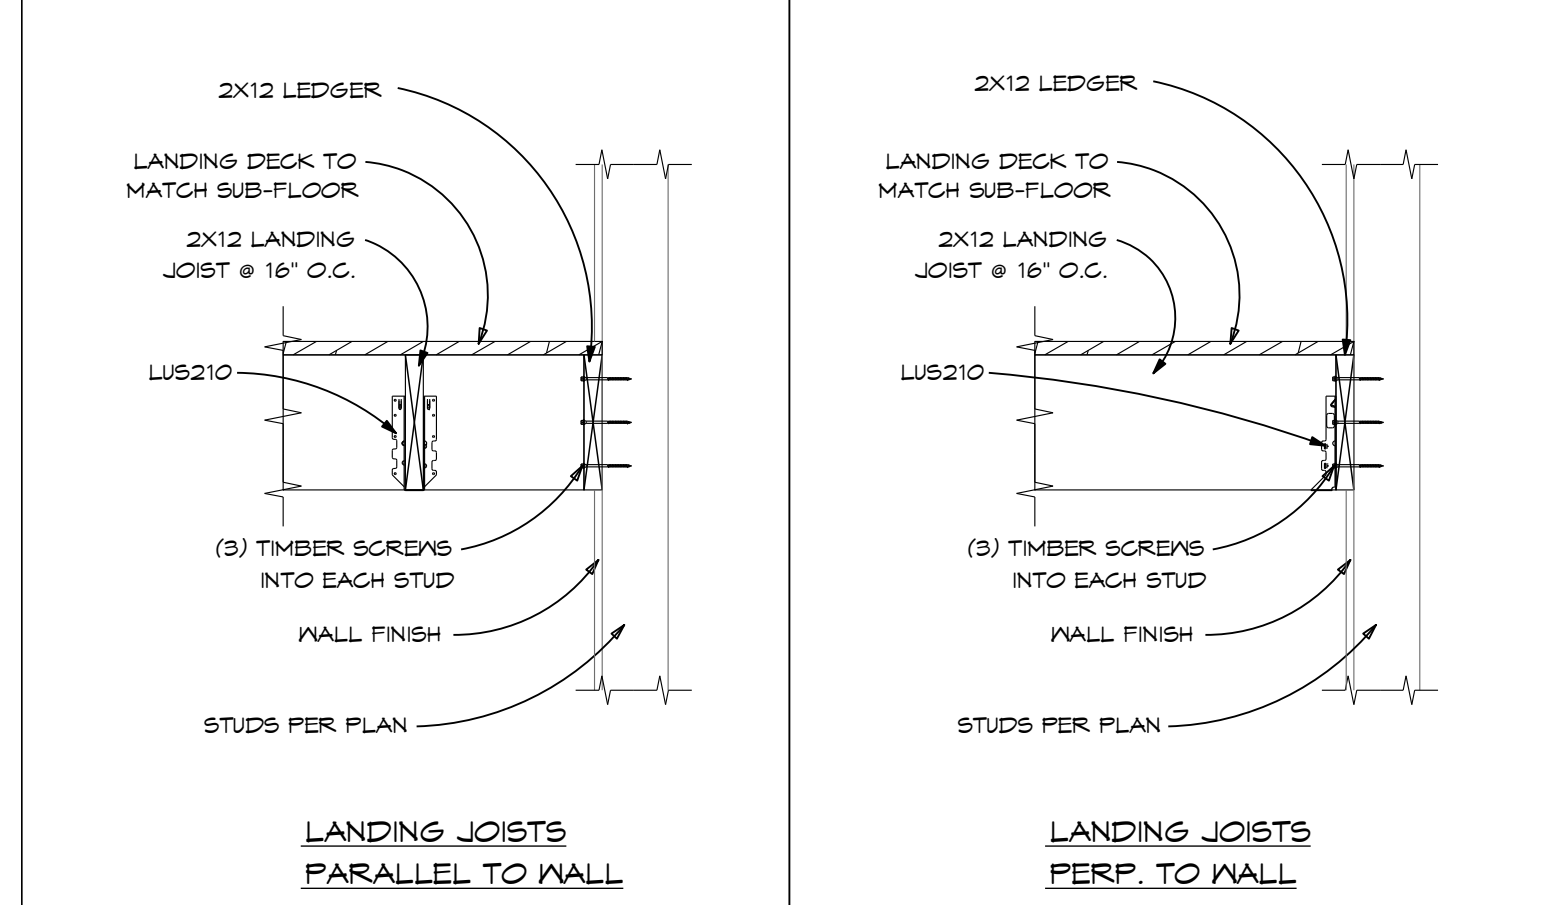


**4 LANDING TO WALL DETAIL**  
Scale 3/4" = 1'-0"

REVIEWED  
FOR  
CODE  
COMPLIANCE  
04/28/2025

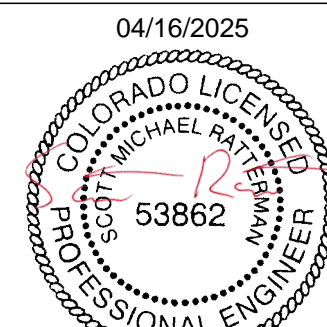

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3	04.16.25	REV 3

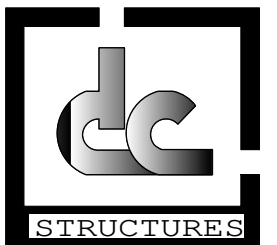OWNER INFORMATION  
LUKE & CARISSA  
BERLET

BERLET  
'SHASTA'


38980 MAIN STREET  
MILNER, CO 80477

STAIR  
FRAMING  
DETAILS


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R.J.F.  
04/19/2025




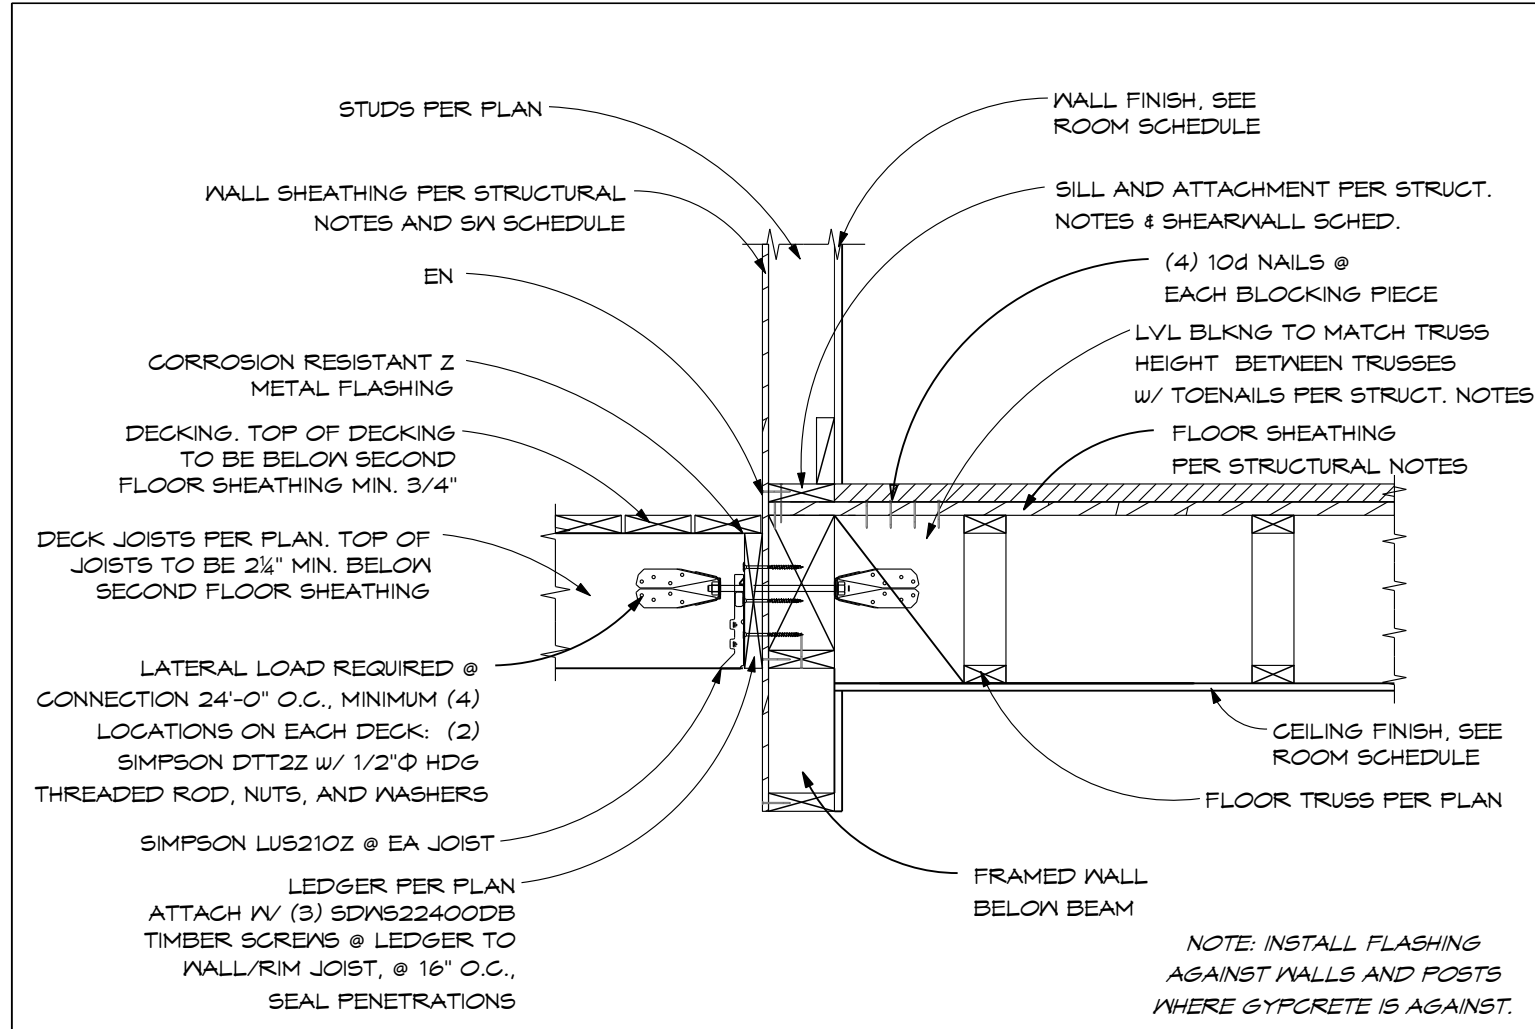


13 DECK LEDGER @ FLUSH WALL HEADER  
Scale 3/4" = 1'-0"

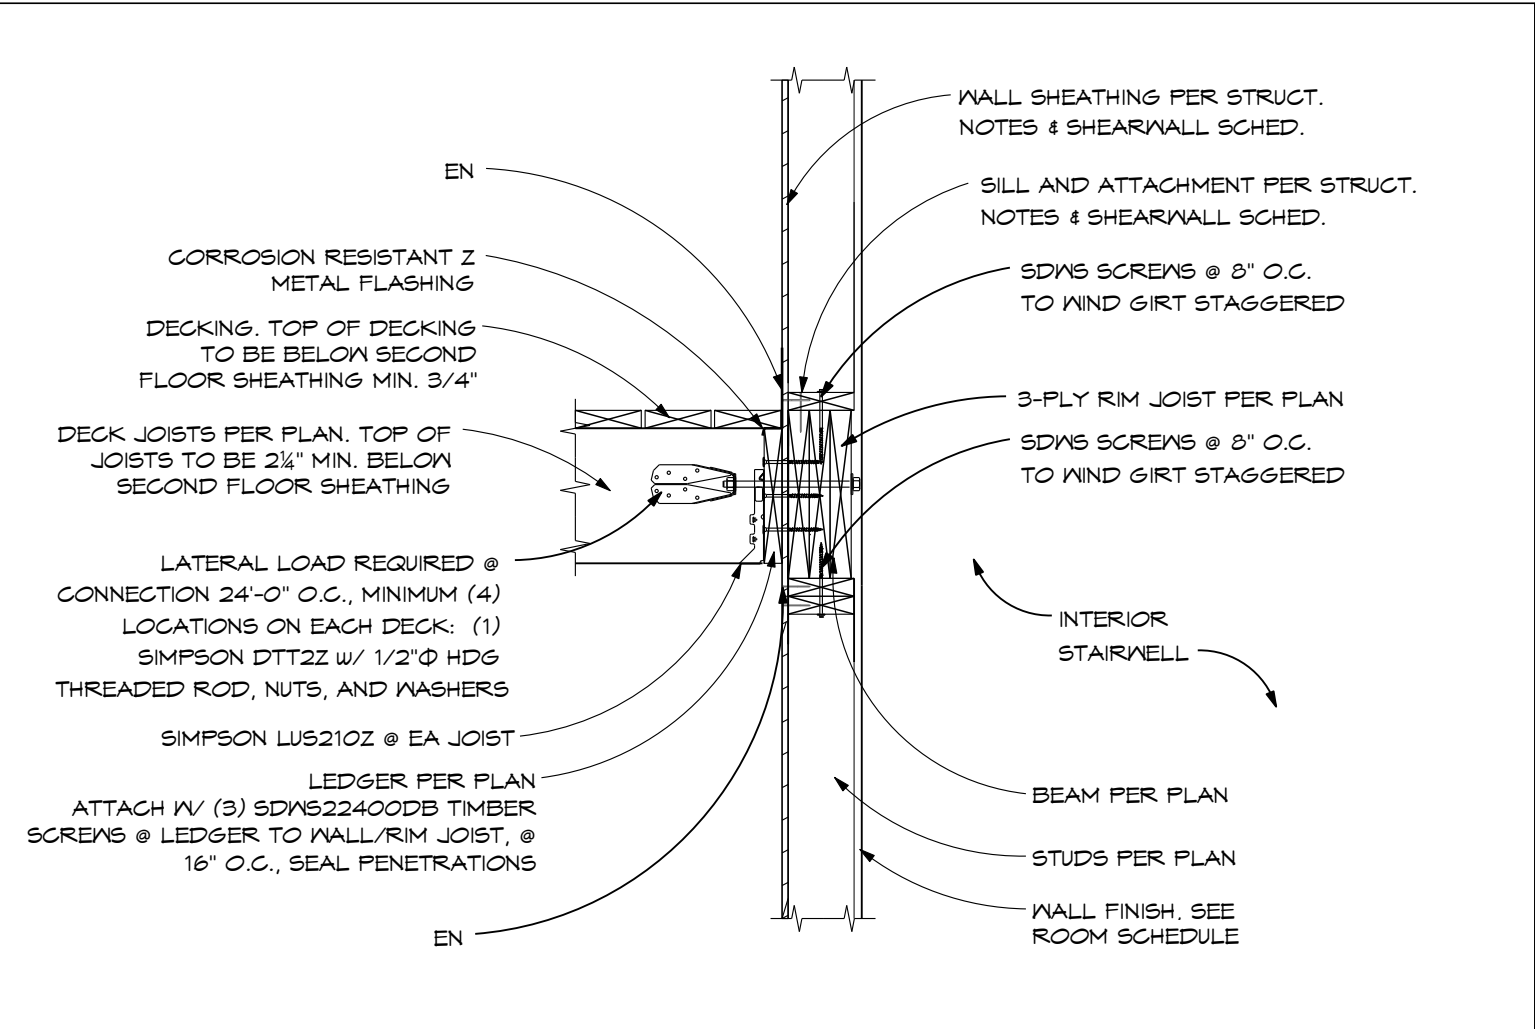


9 DECK LEDGER @ BEAM  
Scale 3/4" = 1'-0"

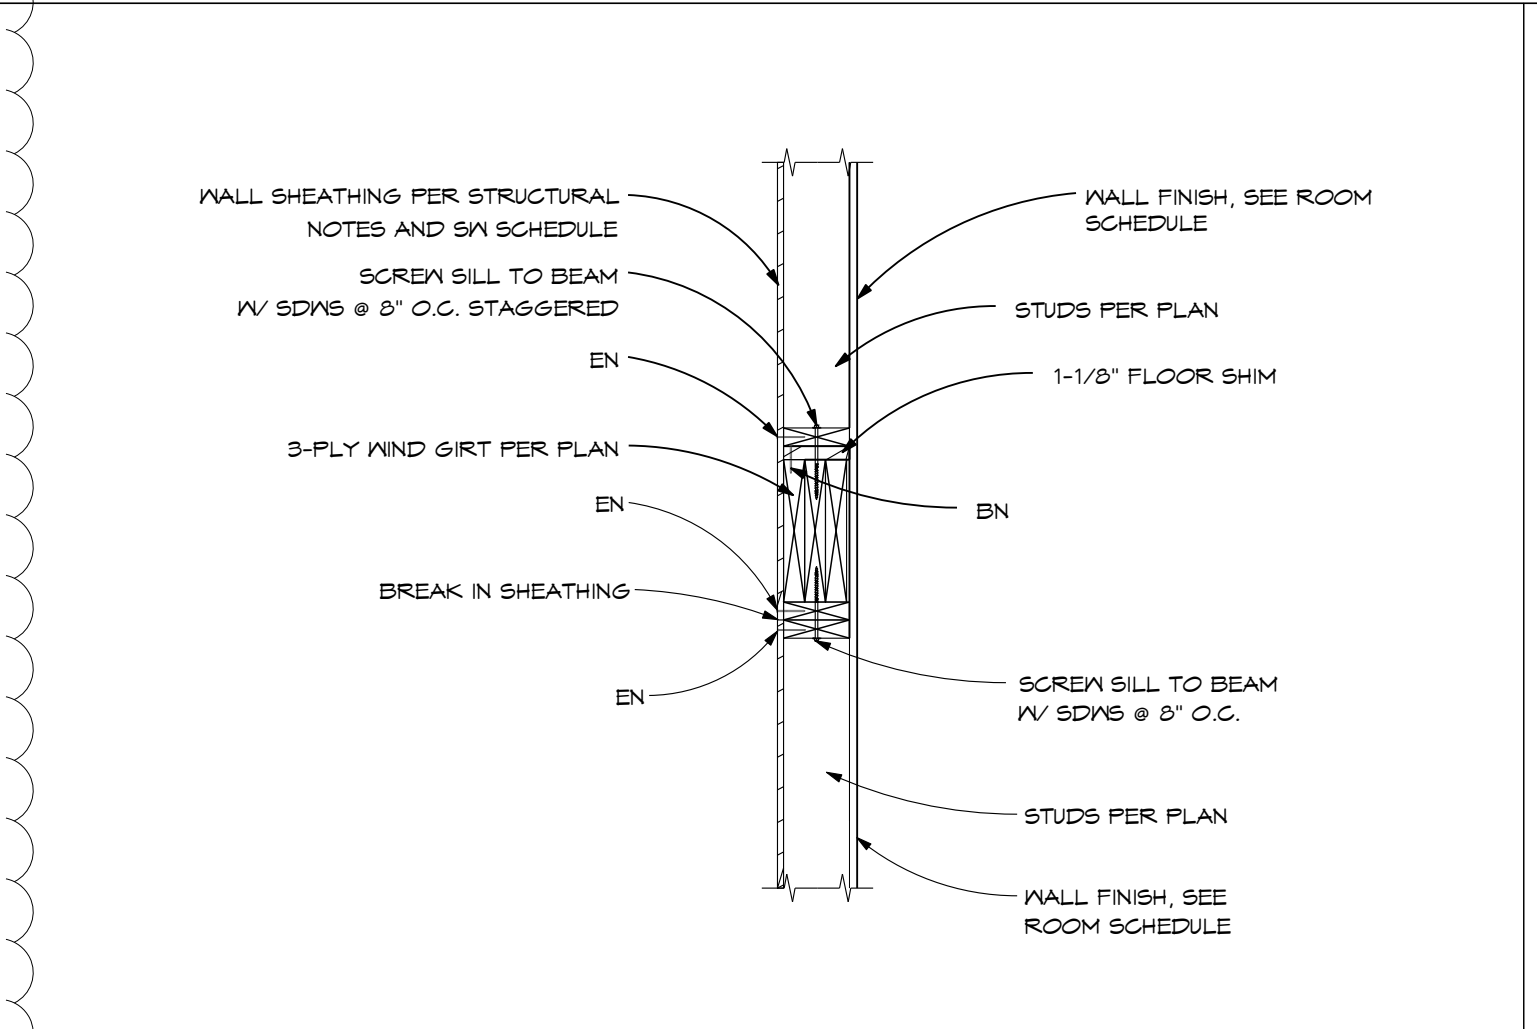


5 FLOOR TRUSS - STAIR OPENING  
Scale 3/4" = 1'-0"

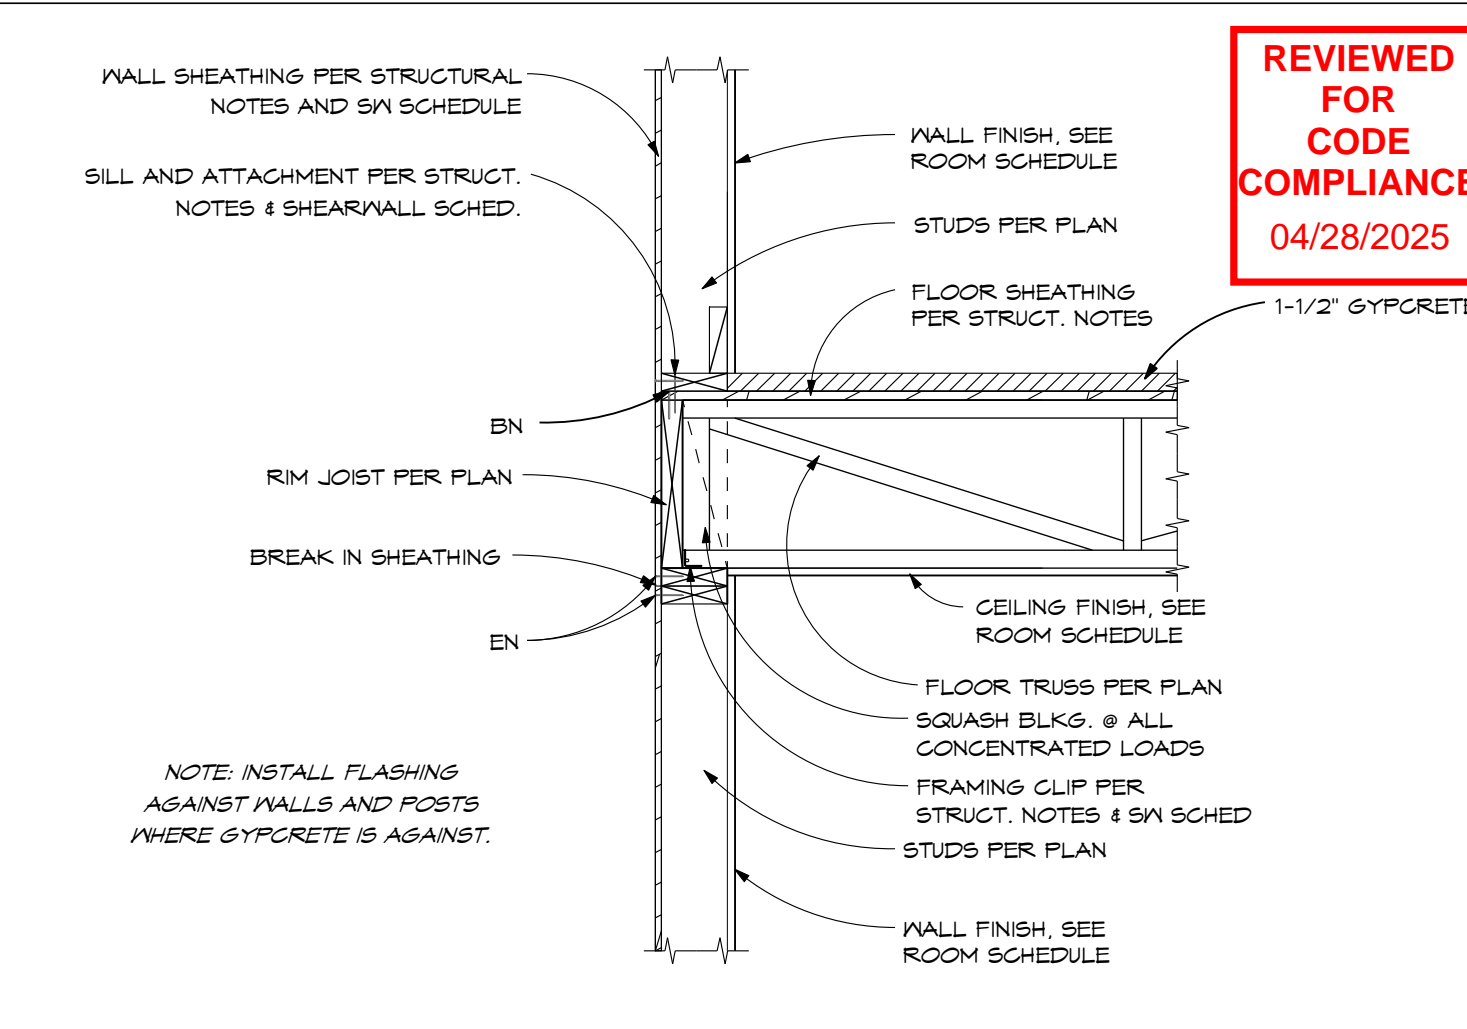


1 FLOOR TRUSS - PERP. TO FRAMED WALL  
Scale 3/4" = 1'-0"

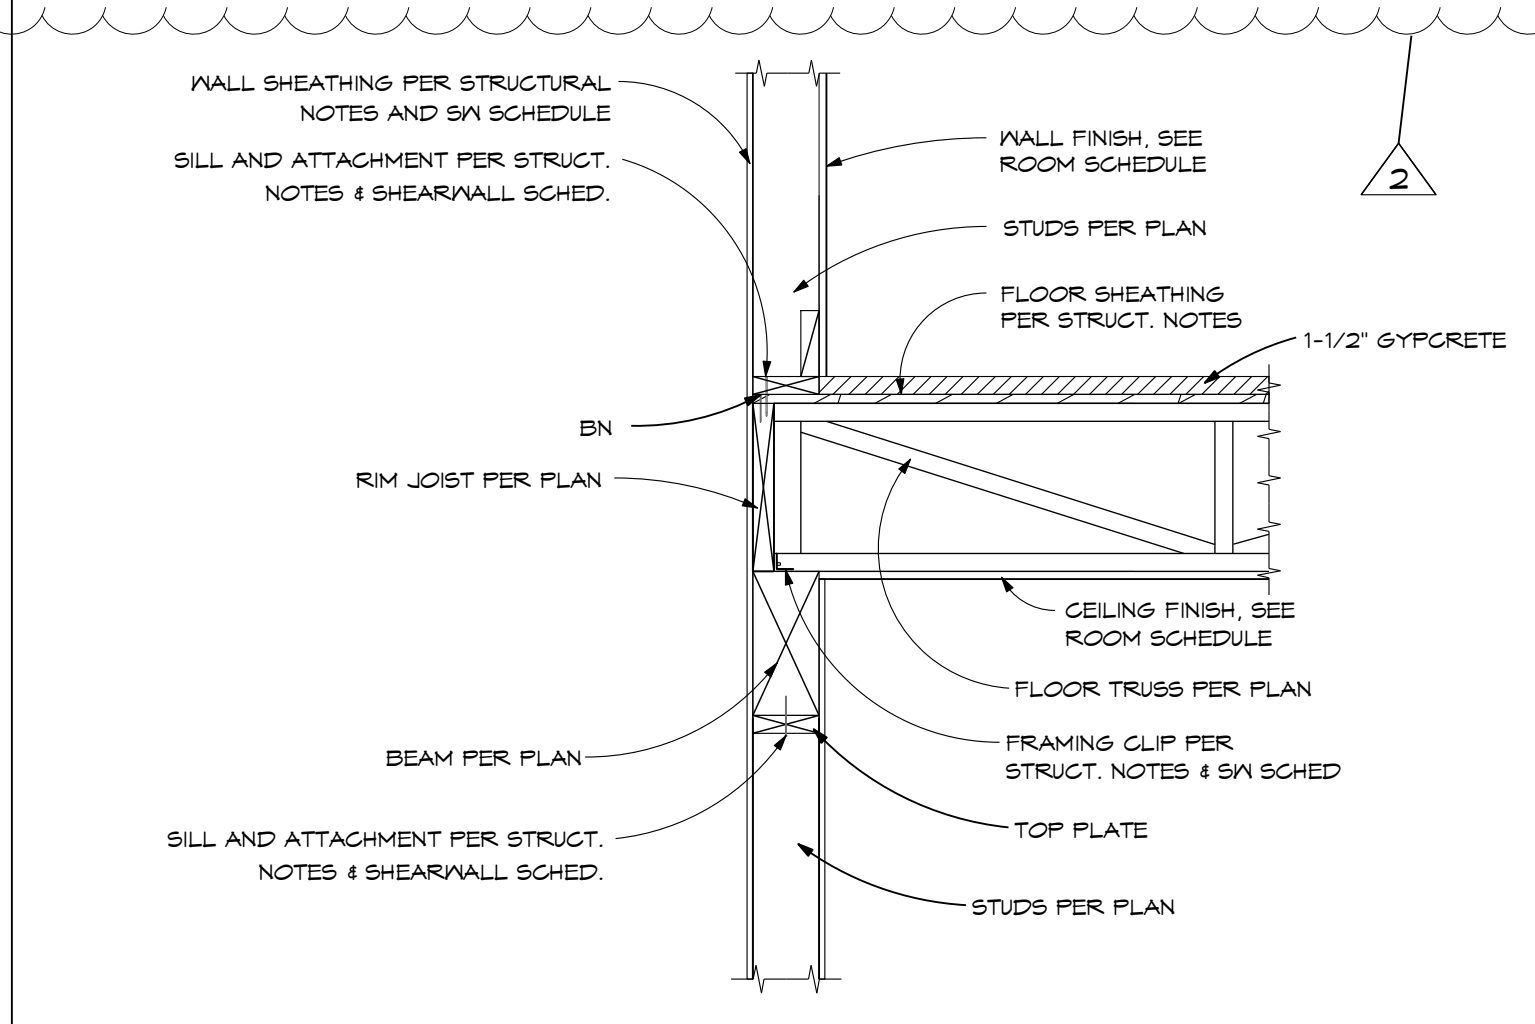


14 FLOOR TRUSS - PERP. TO FLOOR BEAM  
Scale 3/4" = 1'-0"

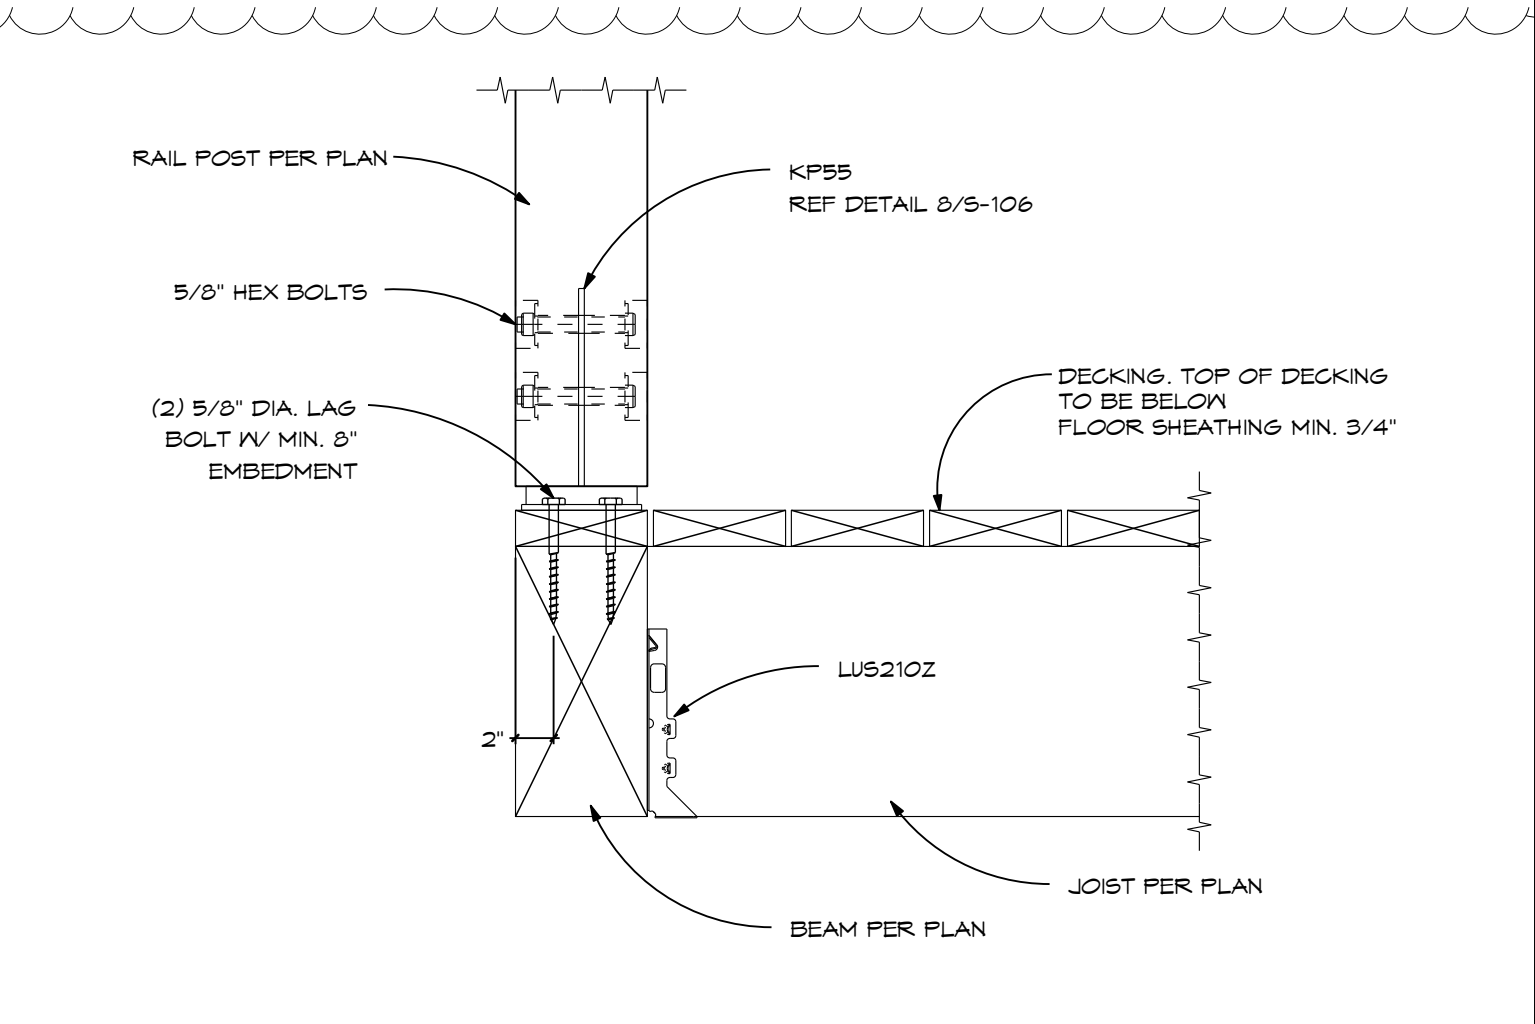


10 EXTERIOR DECK JOIST TO BEAM  
Scale 1 1/2" = 1'-0"

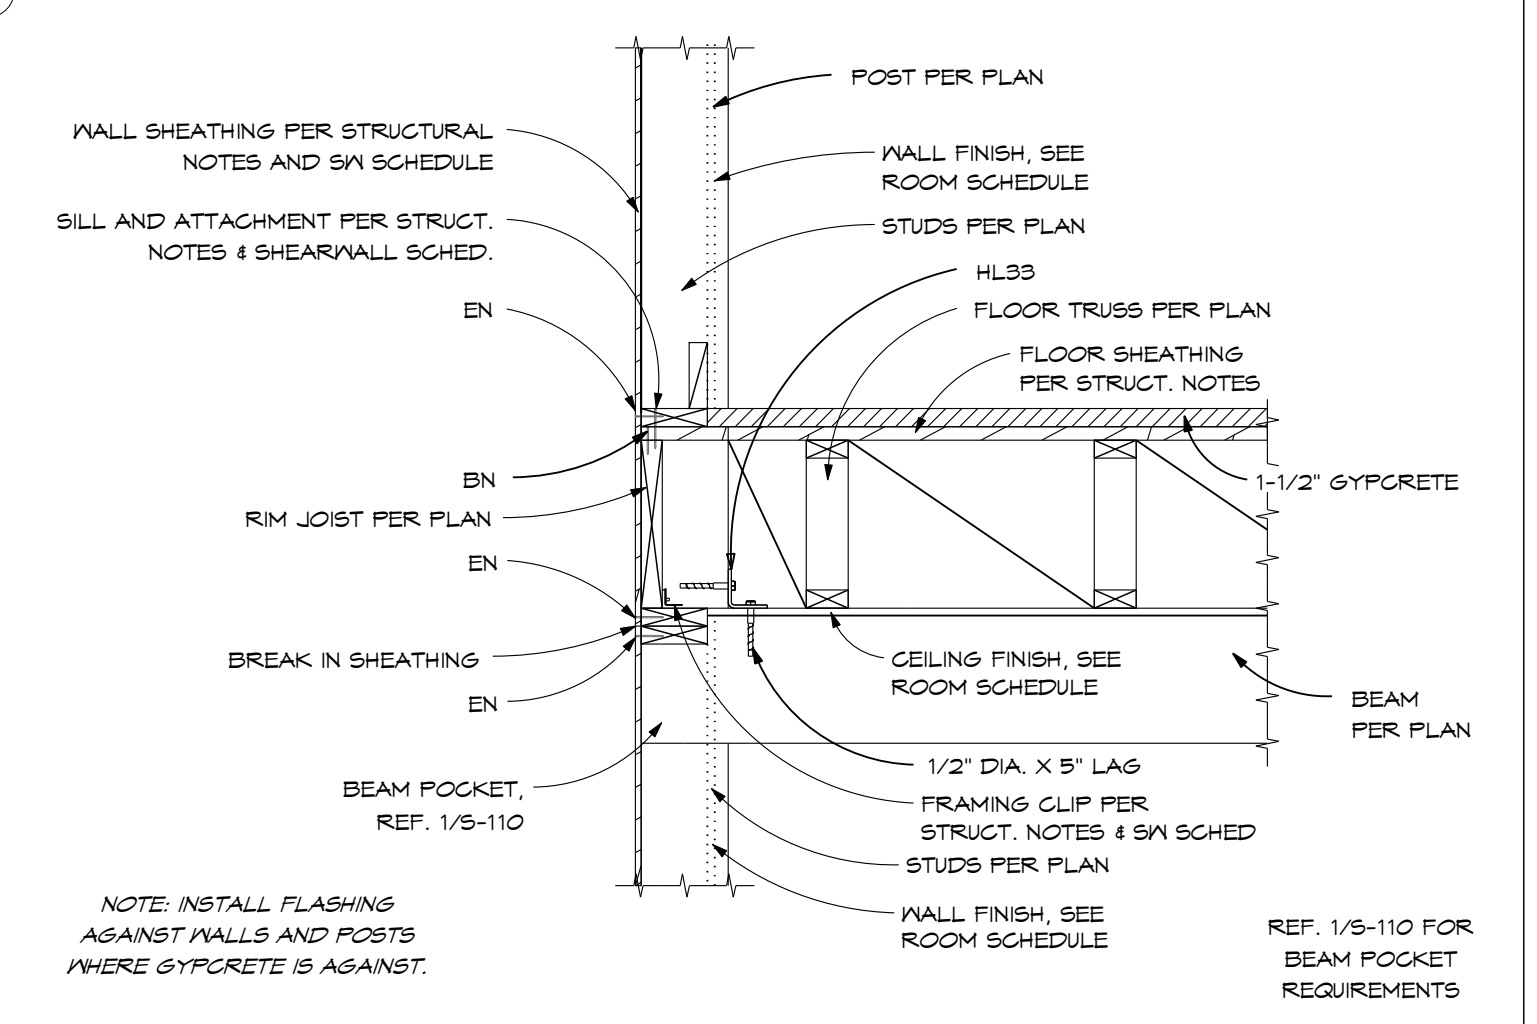


6 FLOOR TRUSS @ BEAM POST  
Scale 3/4" = 1'-0"

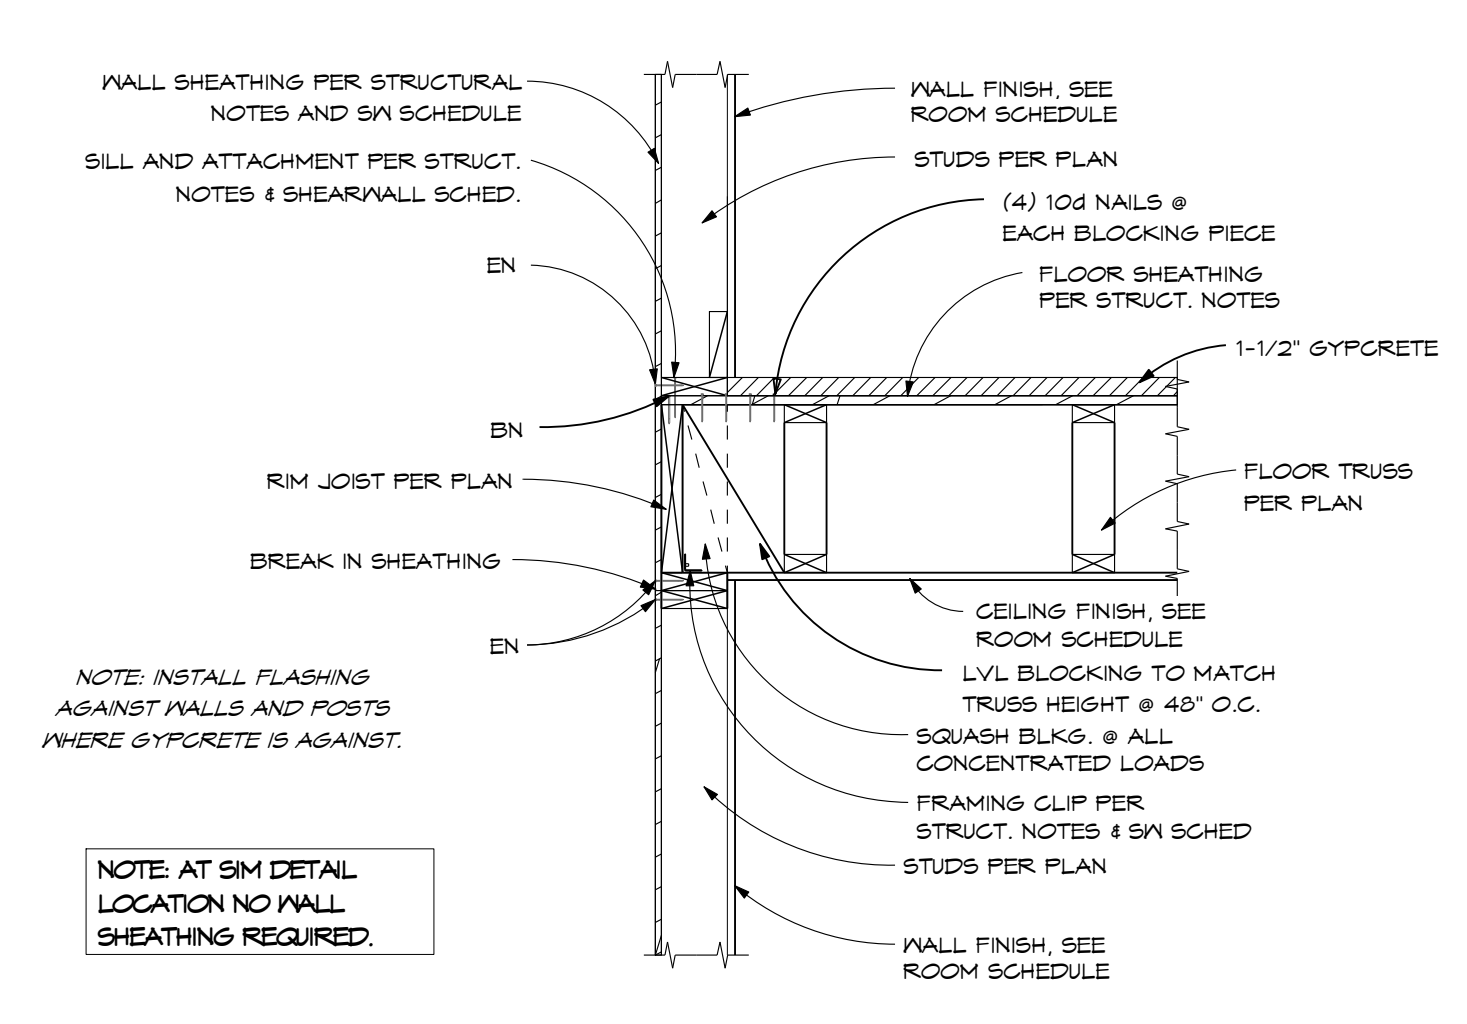


2 FLOOR TRUSS - PERP. TO FRAMED WALL  
Scale 3/4" = 1'-0"

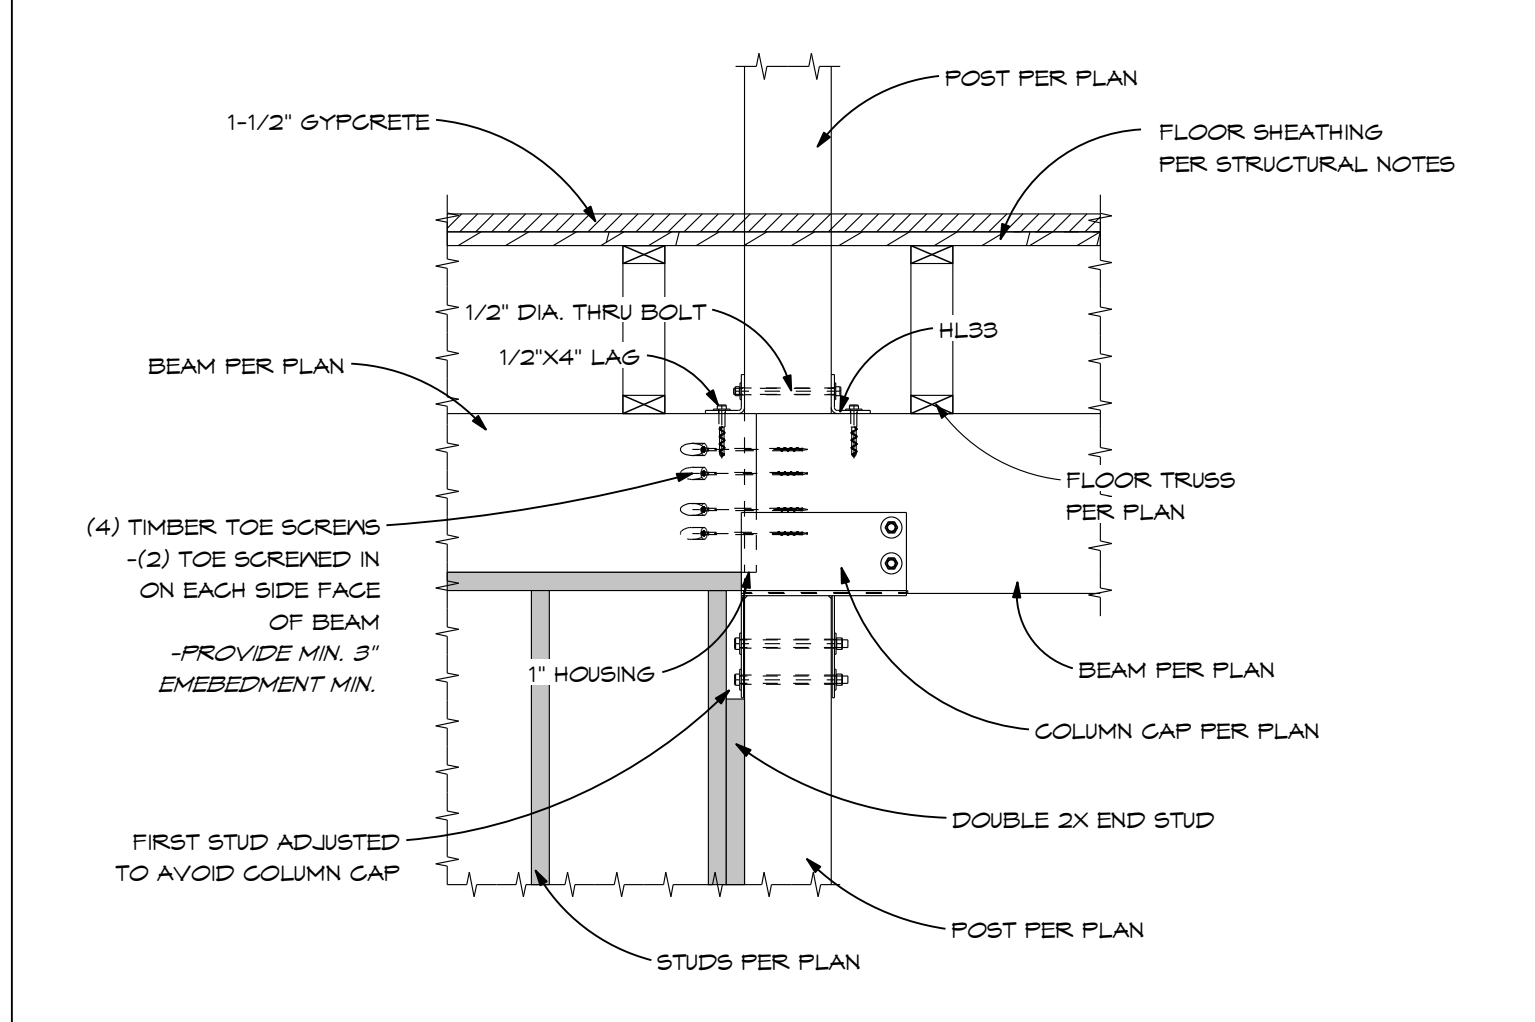


15 FLOOR TRUSS - BEAM TO BEAM  
Scale 3/4" = 1'-0"

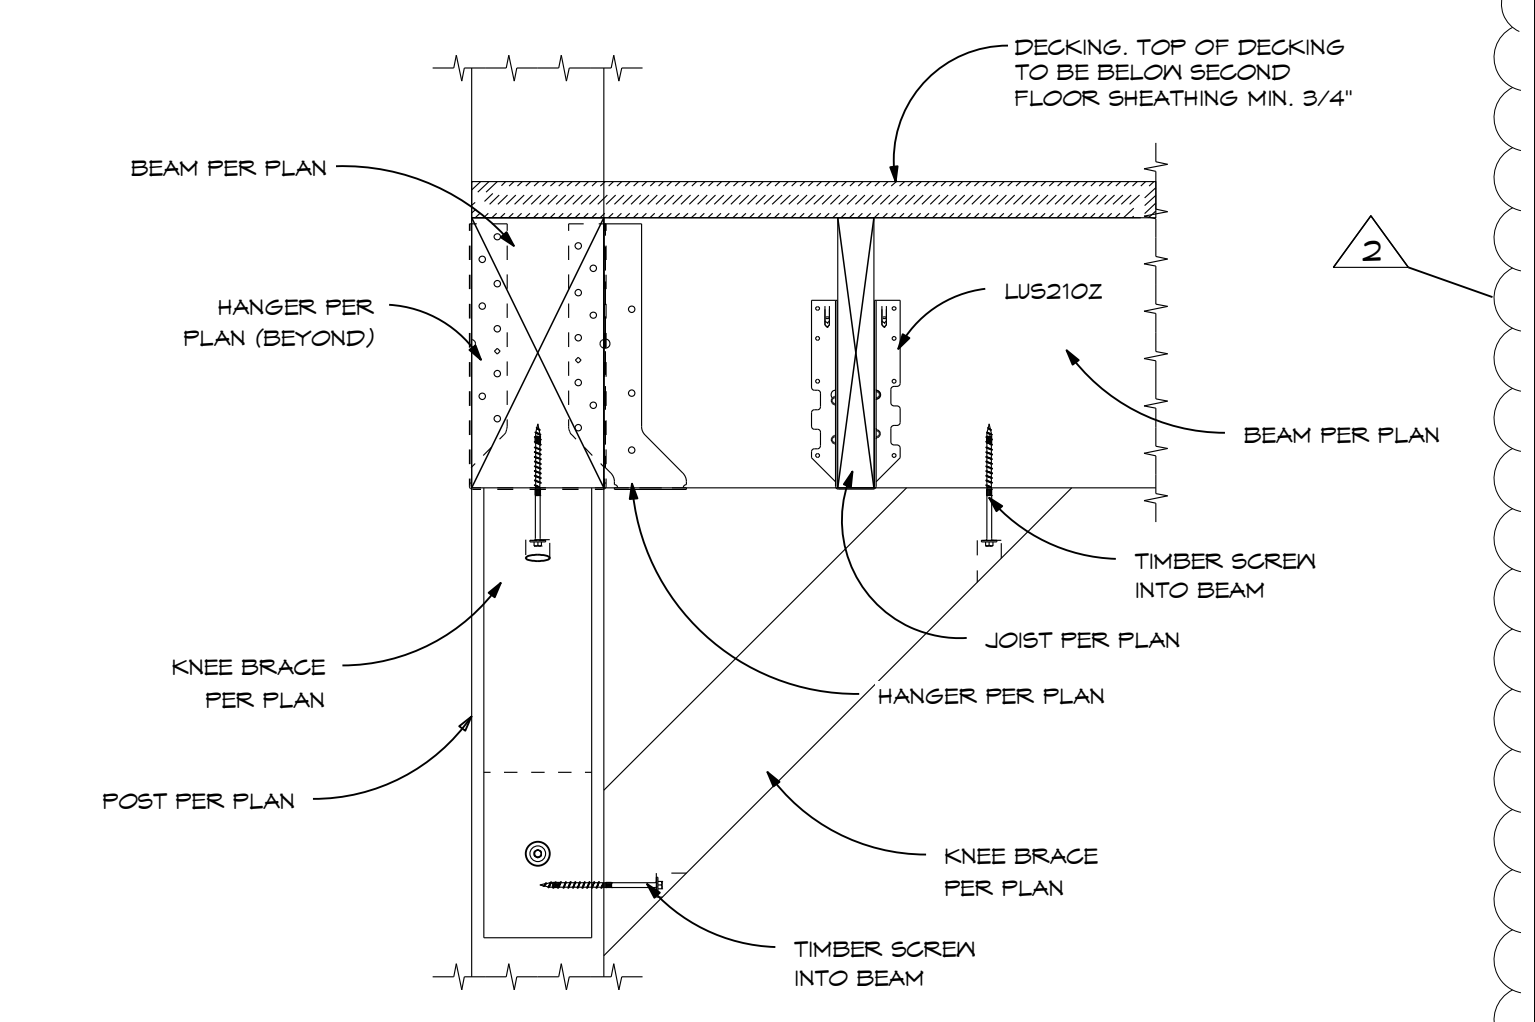

11 EXTERIOR DECK JOIST TO BEAM - CORNER  
Scale 1 1/2" = 1'-0"

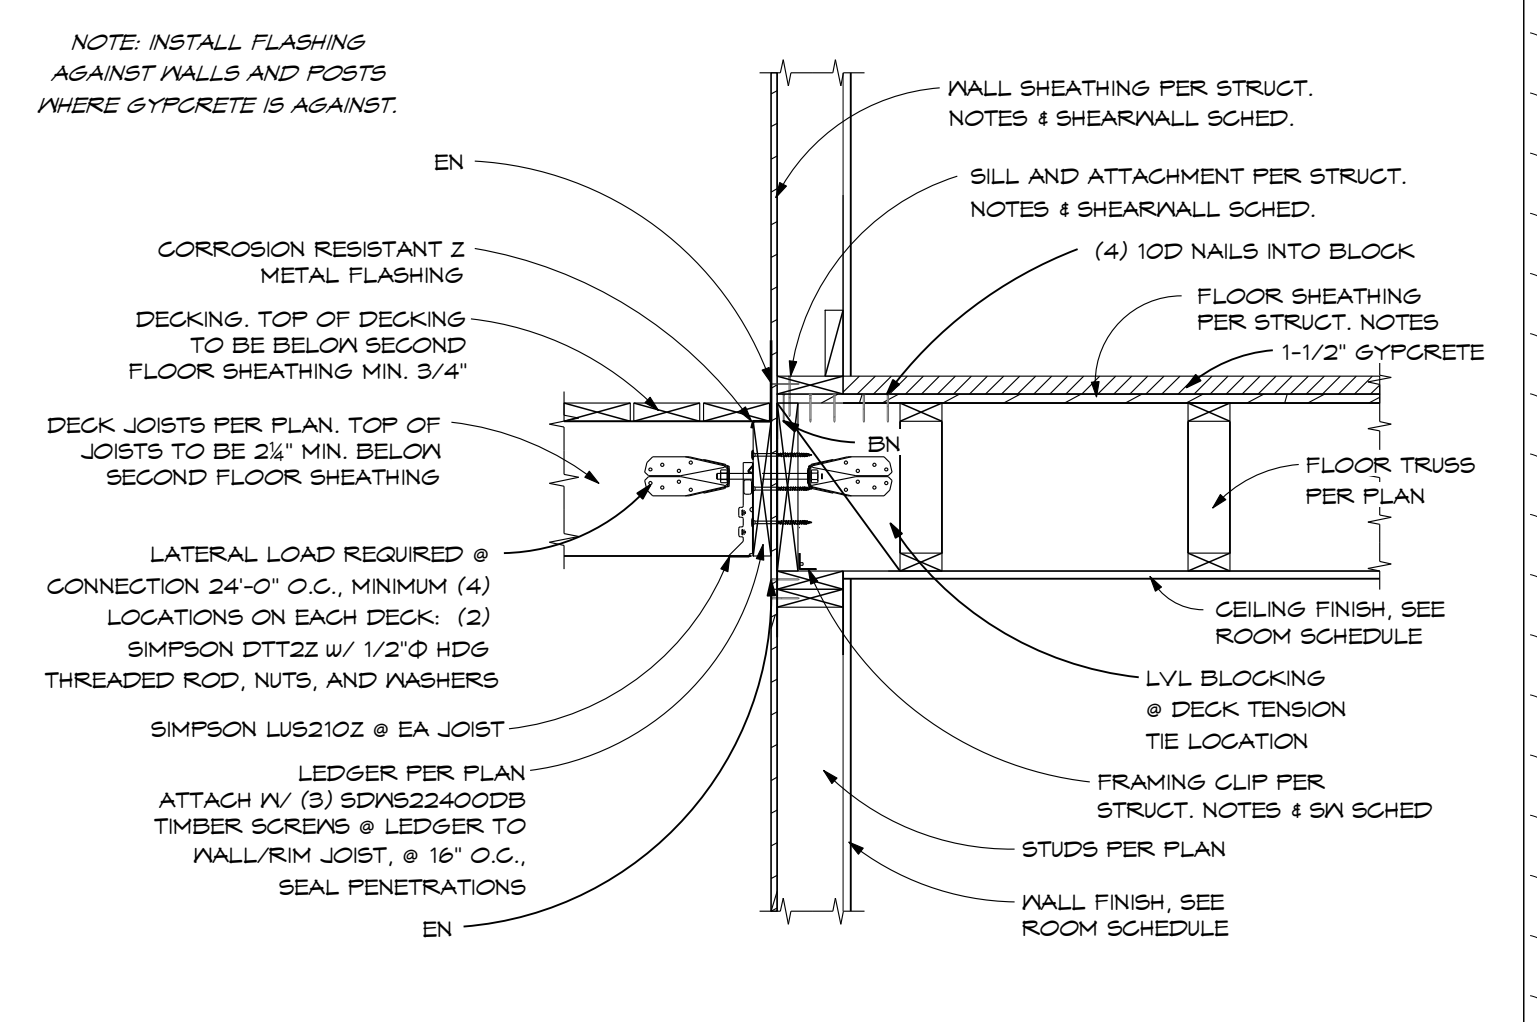


7 FLOOR TRUSS-PARALLEL W/ DECK LEDGER  
Scale 3/4" = 1'-0"

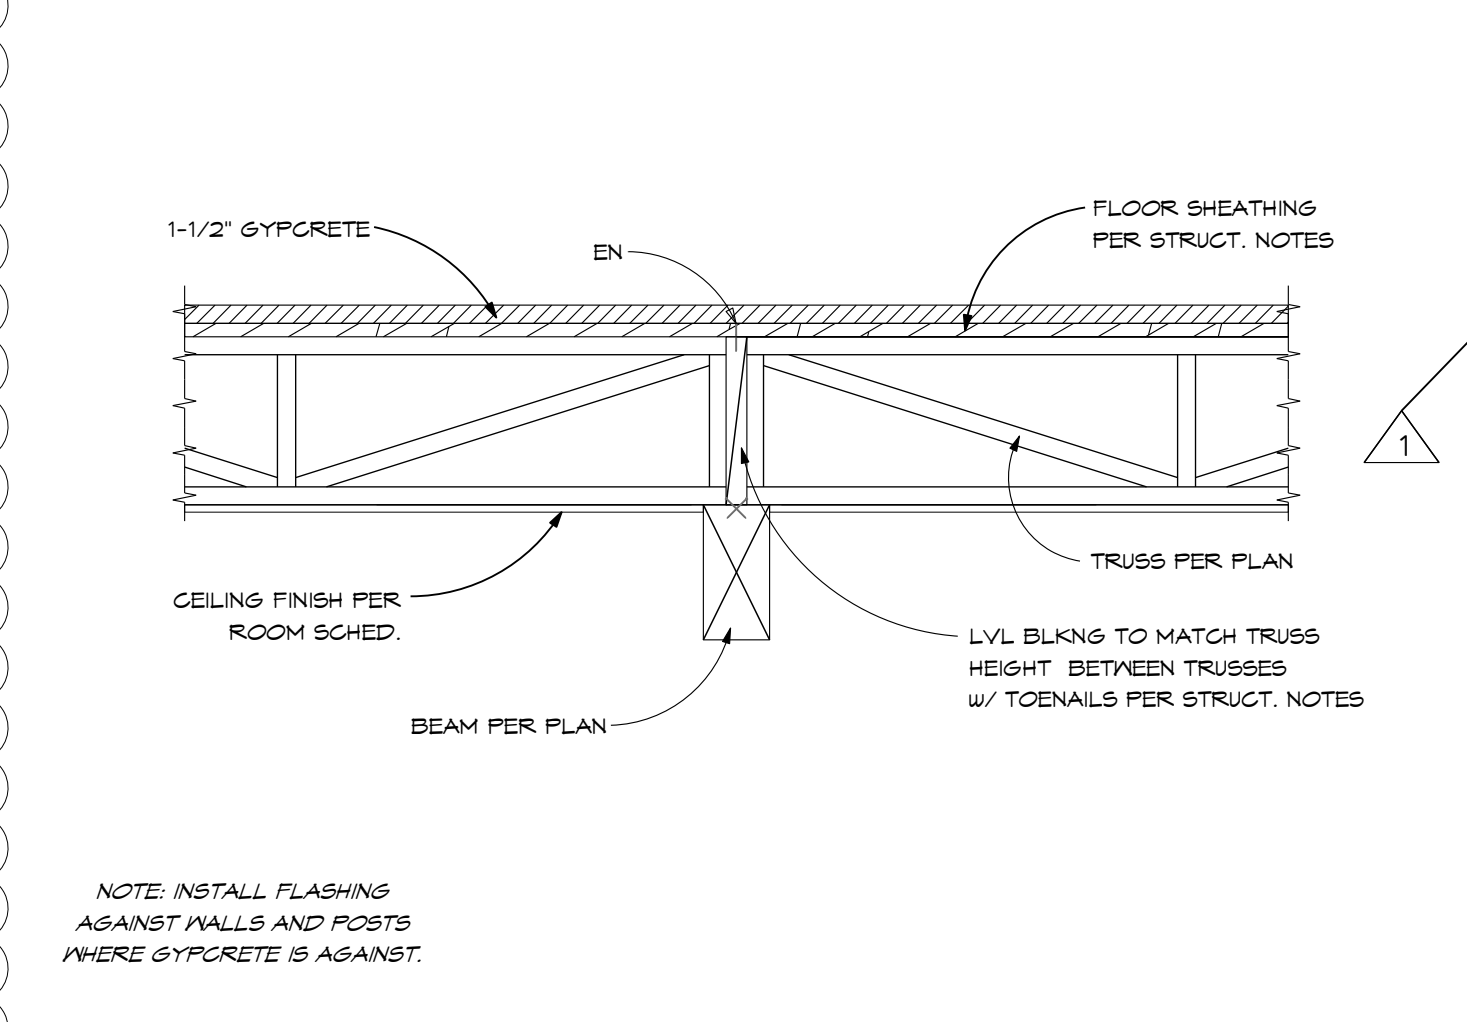


3 FLOOR TRUSS - PERP TO BEAM  
Scale 3/4" = 1'-0"




12 FLOOR TRUSS @ FLUSH WALL HEADER-PARALLEL TRUSS  
Scale 3/4" = 1'-0"

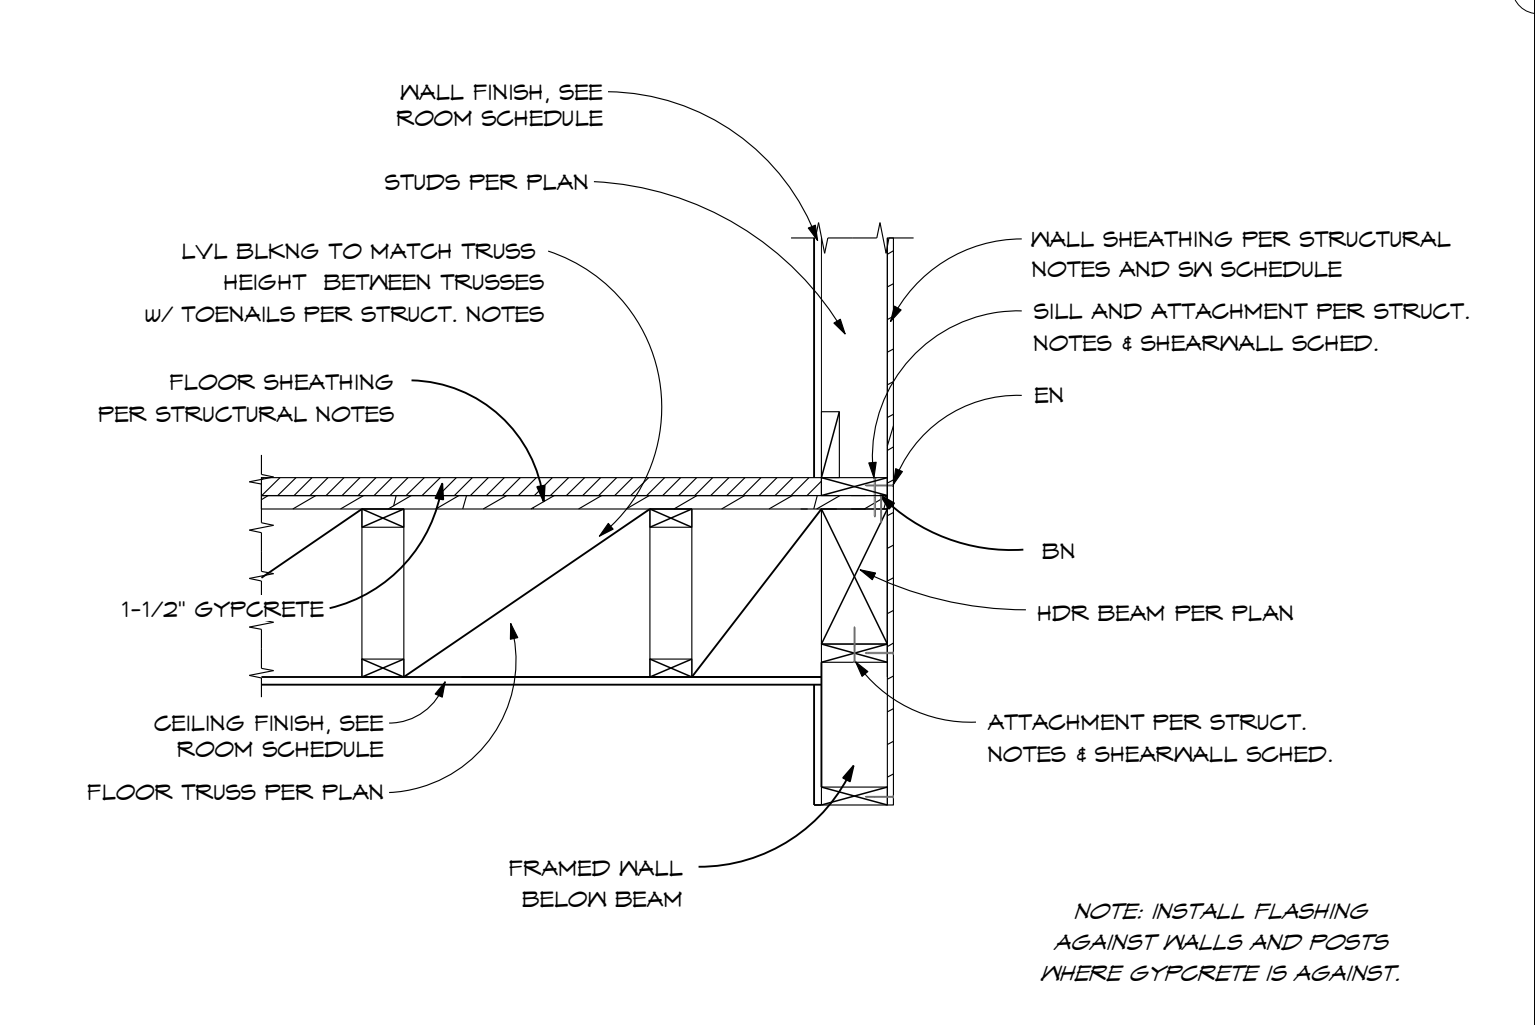

8 EXTERIOR DECK BEAM TO POST  
Scale 1 1/2" = 1'-0"

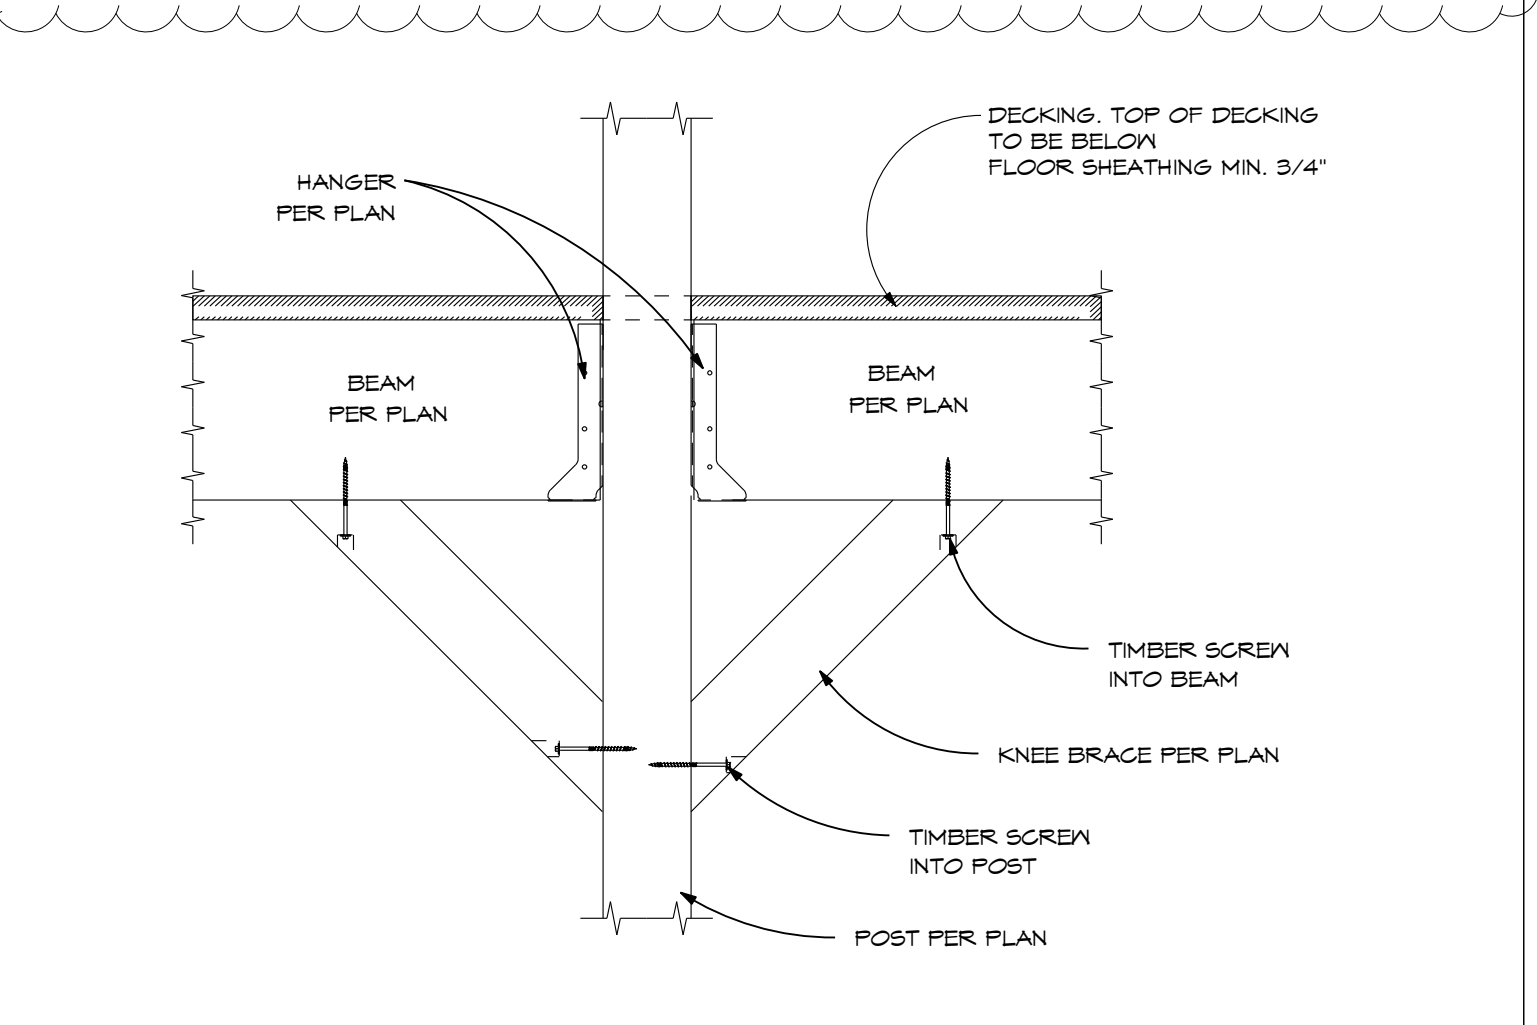

4 FLOOR TRUSS @ POST  
Scale 3/4" = 1'-0"

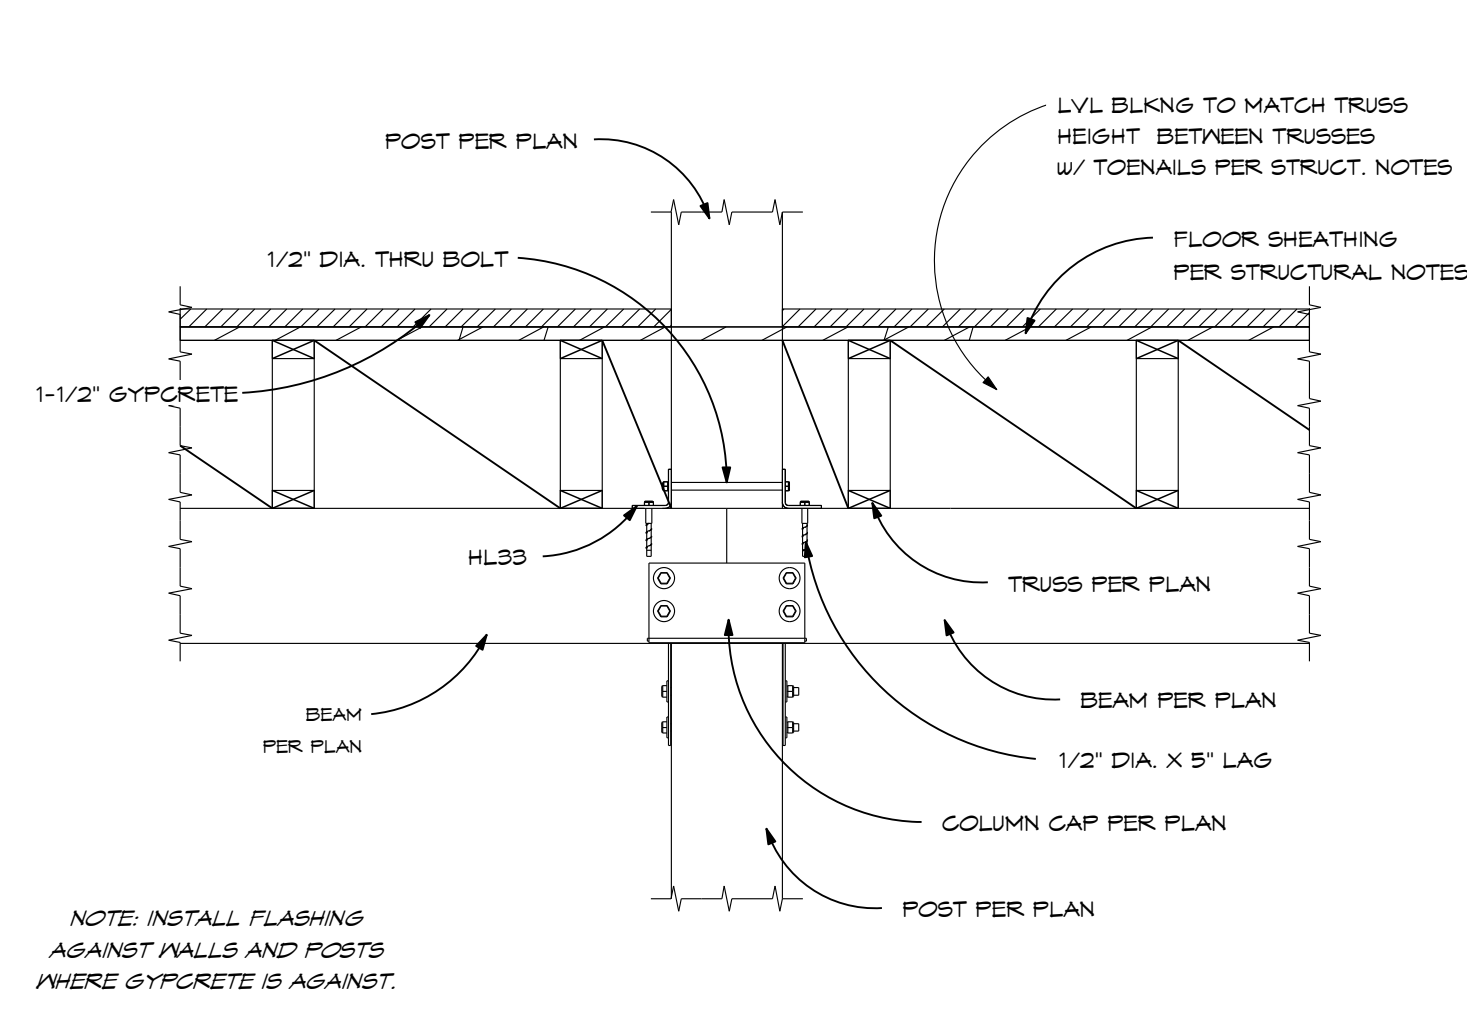

4 FLOOR TRUSS @ POST  
Scale 3/4" = 1'-0"

04/16/2025  
MICHAEL T. BERLET  
53862  
PROFESSIONAL ENGINEER  
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OWNER INFORMATION  
LUKE & CARISSA  
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BERLET  
'SHASTA'

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MILNER, CO 80477


FLOOR  
FRAMING  
DETAILS

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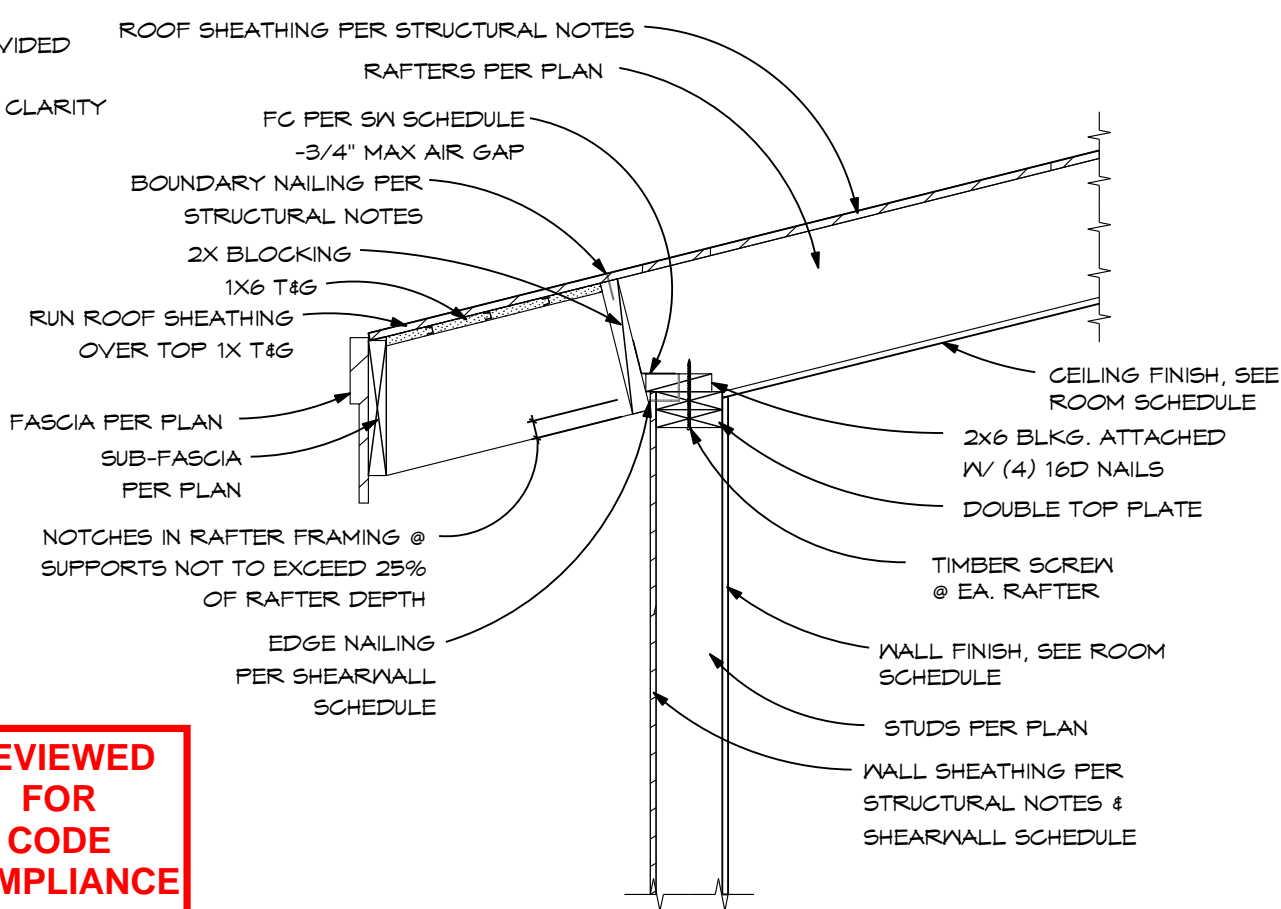


NOTE:  
INSULATION, PROVIDED  
BY OTHERS,  
NOT SHOWN FOR CLARITY




**5** RIDGE - 2X FRAMING  
Scale 3/4" = 1'-0"

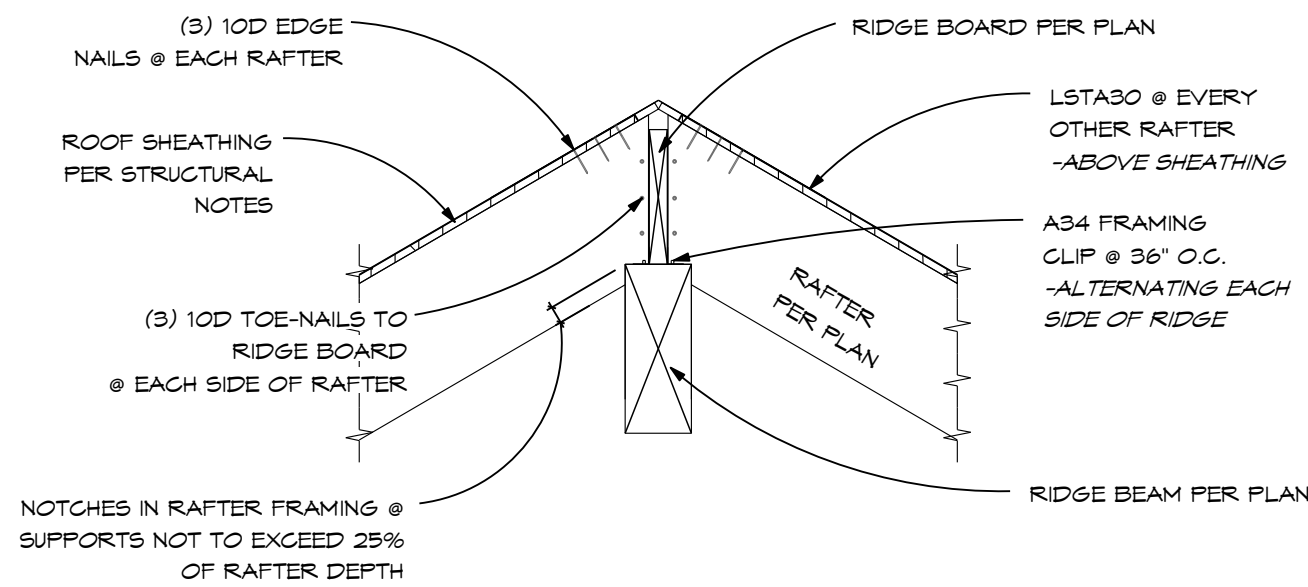
NOTE:  
INSULATION, PROVIDED  
BY OTHERS,  
NOT SHOWN FOR CLARITY




**1** EAVE DETAIL - 2X FRAMING LOW  
Scale 3/4" = 1'-0"

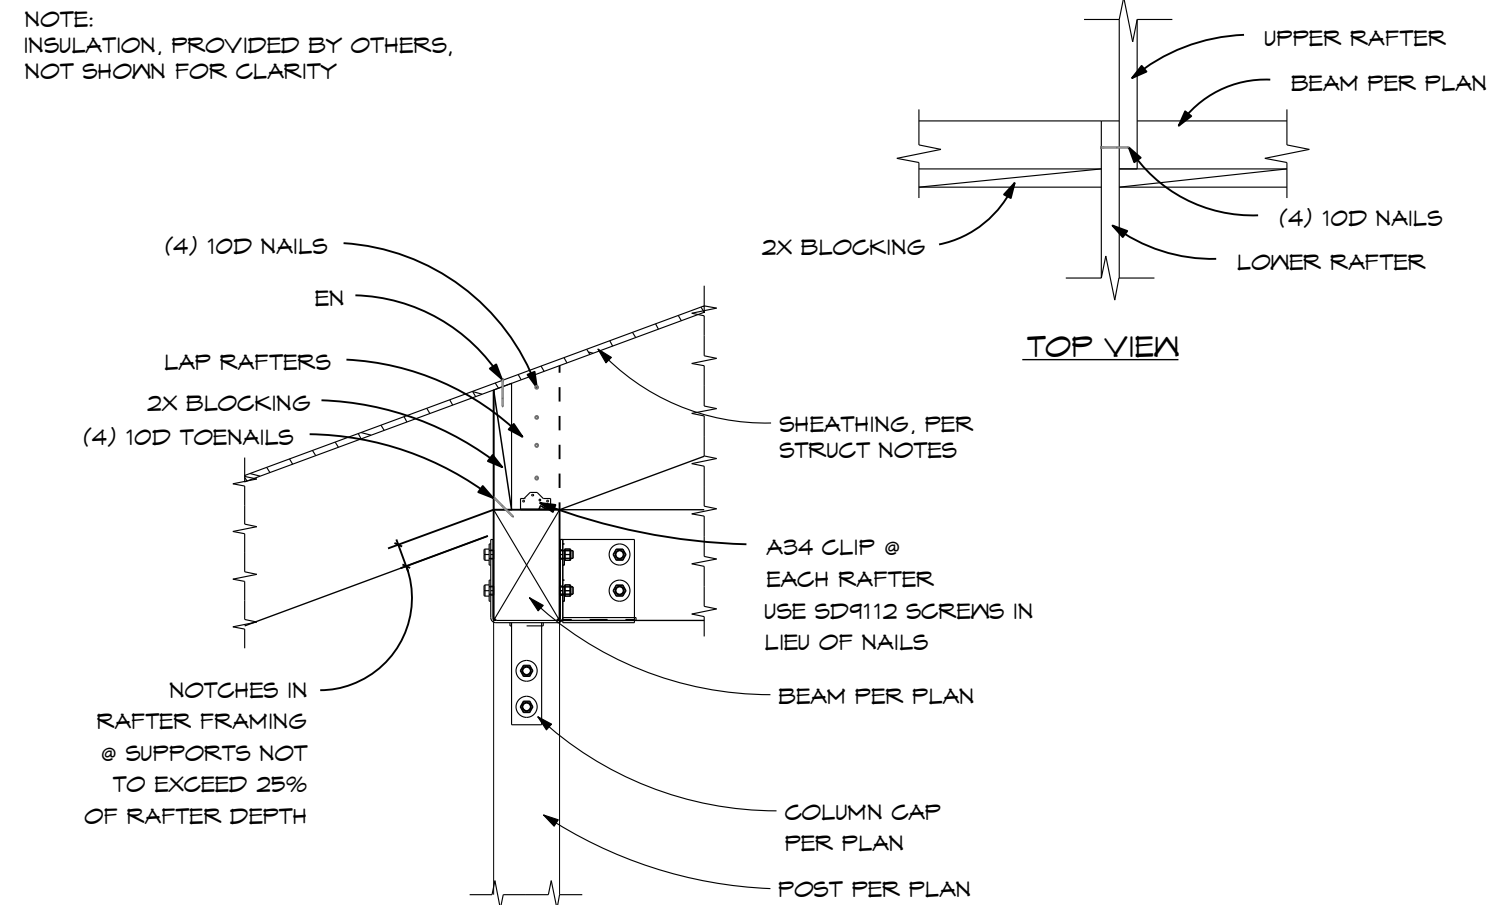

**2** MID SPAN BEAM - 2x LAP FRAMING @ MID-SPAN BEAM  
Scale 3/4" = 1'-0"

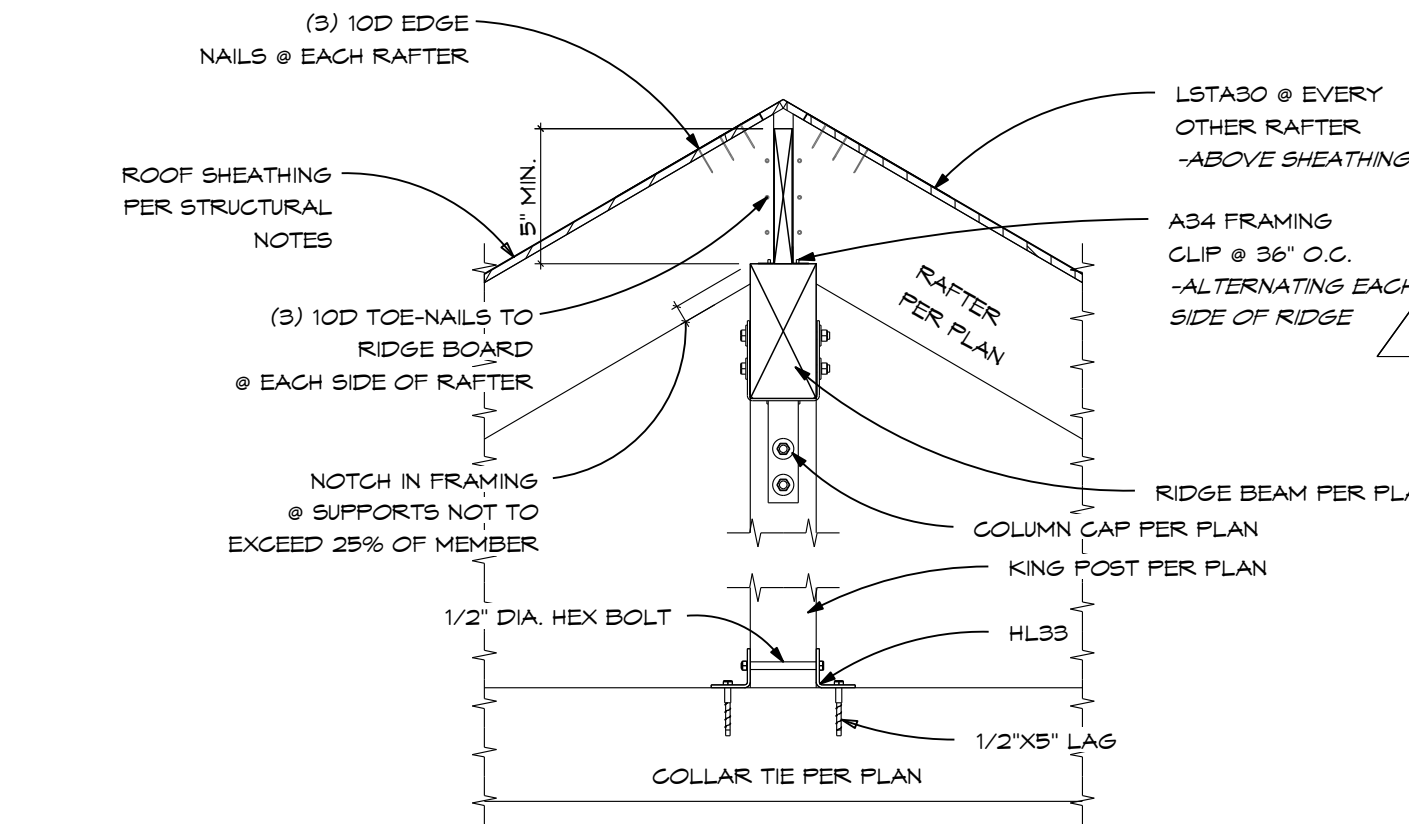

**3** RIDGE / KING POST - 2X FRAMING  
Scale 3/4" = 1'-0"

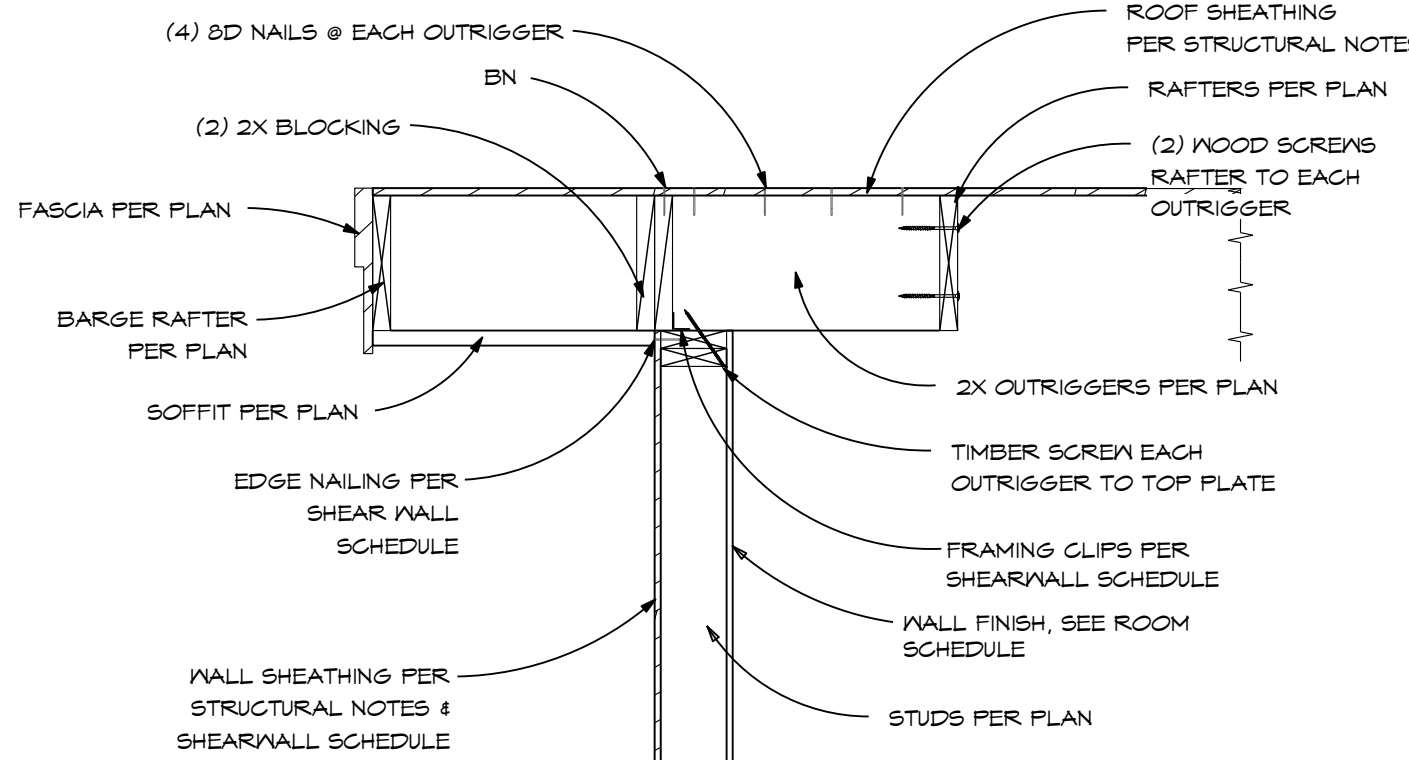

NOTE:  
INSULATION, PROVIDED  
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**4** RAKE - 2X FRAMING W/ RAFTER  
Scale 3/4" = 1'-0"

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Drawing Index		
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1	03.14.25	REV 1

OWNER INFORMATION  
LUKE & CARISSA  
BERLET

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ROOF  
FRAMING  
DETAILS

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