


APPROVED

ATMOS ENERGY CORPORATION Not in ATMOS ENERGY CORPORATION'S Service area. No Atmos Energy natural gas in area.

RCRBD

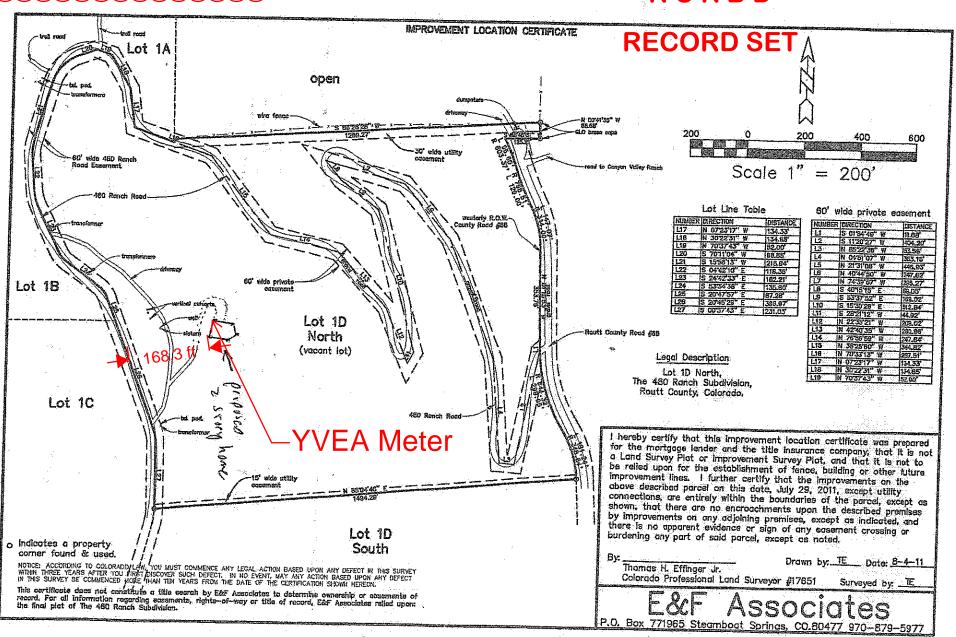


GIS/Addressing OK EK 20160920

Meter and meter panels are to be located as described by YVEA. They shall not be enclosed, covered or concealed. Violation shall result in termination of service.

YAMPA VALLEY ELECTRIC ASSN. INC.

This approval addresses only the meter and service location.

Approved: Jerry Nanio - YVEA.

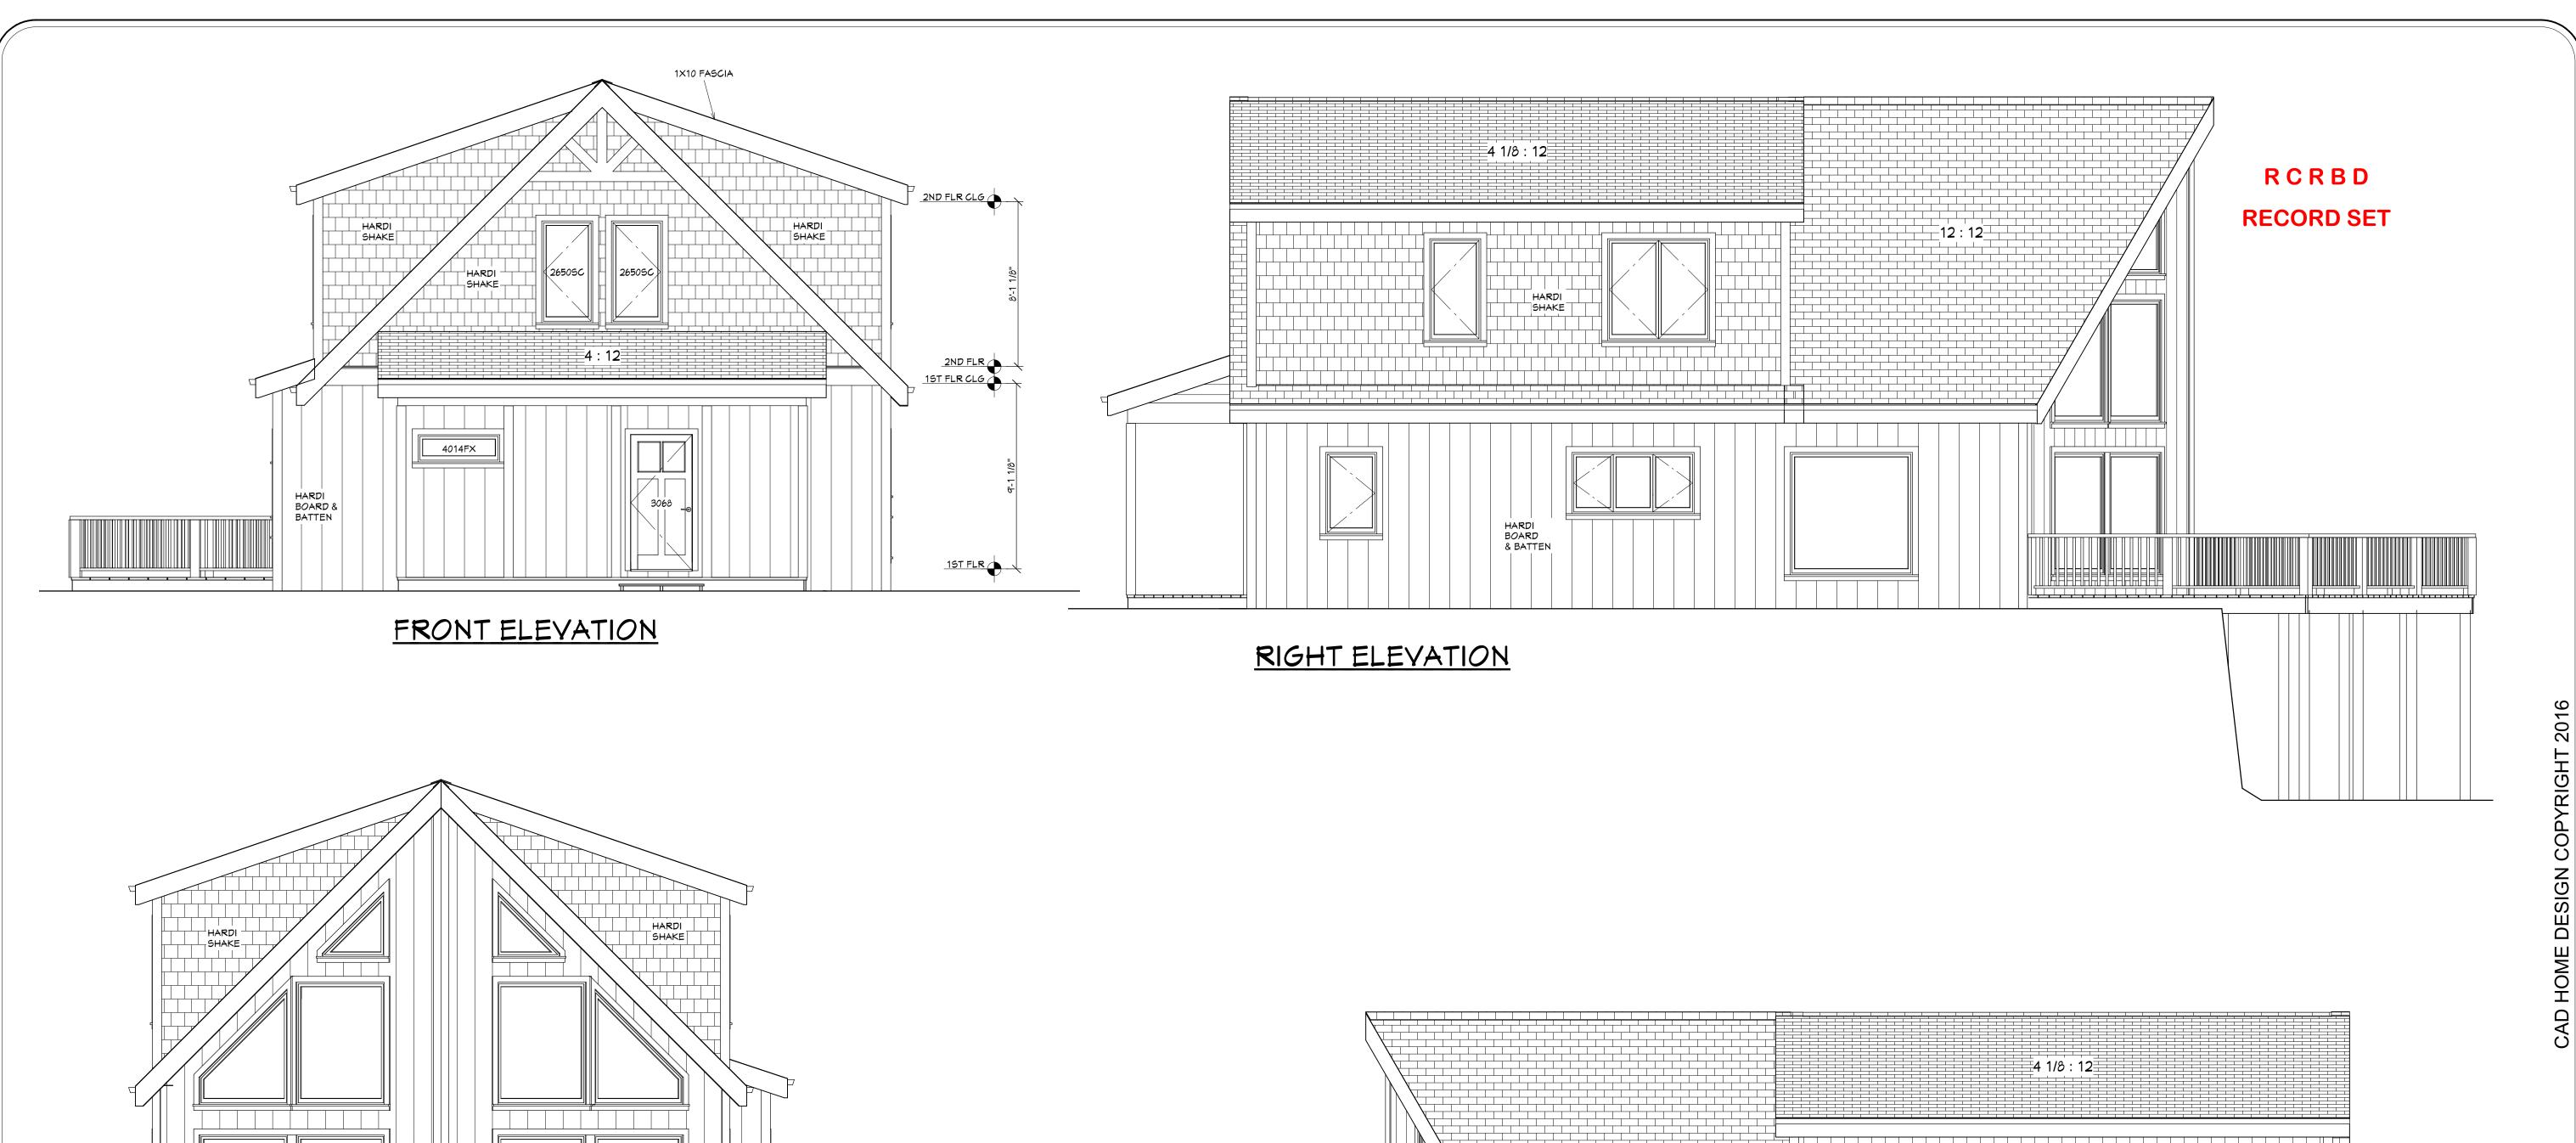





LEFT ELEVATION

ELECTRICAL SUBJECT TO APPROVAL AT FIELD INSPECTION

ALL WORK SHALL BE PERFORMED IN ACCORDANCE WITH APPLICABLE BUILDING CODES. (CURRENTLY IRC 2012) CONTRACTOR/BUILDER SHALL VERIFY ALL CONDITIONS AND DIMENSIONS AT SITE BEFORE BEGINNING CONSTRUCTION. ANY DISCREPANCIES SHALL BE REPORTED TO CAD HOME DESIGN, INC, FOR JUSTIFICATION OR CORRECTION BEFORE PROCEEDING WITH THE WORK.
CONTRACTOR SHALL ASSUME RESPONSIBILITY FOR UNREPORTED ERRORS. ALL PORTIONS OF FOOTINGS ARE TO BE BELOW LOCAL FROST LINES AND MUST REST ON UNDISTURBED SOIL WITH ADEQUATE BEARING CAPACITY TO SUPPORT THE STRUCTURE. A LOCAL ENGINEER MUST BE CONSULTED FOR PROPER FOOTING AND REINFORCEMENT SIZES. CONTRACTOR TO ENSURE COMPATIBILTY OF THE STRUCTURE WITH ALL SITE REQUIREMENTS. REINFORCE FOUNDATION WALLS PER LOCAL CODES. ALL WOOD, CONCRETE, AND STEEL MEMBERS ARE TO MEET NATIONAL, STATE, AND LOCAL CODES. ALL COLUMNS OR SOLID FRAMING SHALL BE DESIGNED TO CARRY AND TERMINATE LOADS THROUGH THE STRUCTURE TO FOUNDATION ELEMENTS THAT DISTRIBUTE THE LOADS TO FULL CAPACITY SOILS. CAD HOME DESIGN IS THE SOLE OWNER OF THIS OR ANY DERIVATIVE MODIFICATION OF THIS COPYRIGHT PROTECTED PLAN. ALL ELECTRICAL, MECHANICAL, AND PLUMBING ARE TO BE VERIFIED AND PERFORMED BY A LICSENSED ELECTRICAL, MECHANICAL, AND PLUMBING CONTRACTOR IN ACCORDANCE WITH BUILDING CODE.

GENERAL NOTES


65 Stone Ridge Ct. #20433 Jasper, Ga 30143 O.770.893.4545 E.770.234.4067 Home Design

SQUARE FOOTAGE 1ST. FLOOR 1218 2ND. FLOOR 670 TERRACE 658 BONUS 2546

TURCOTTE RESIDENCE

8/25/2016


CHK:

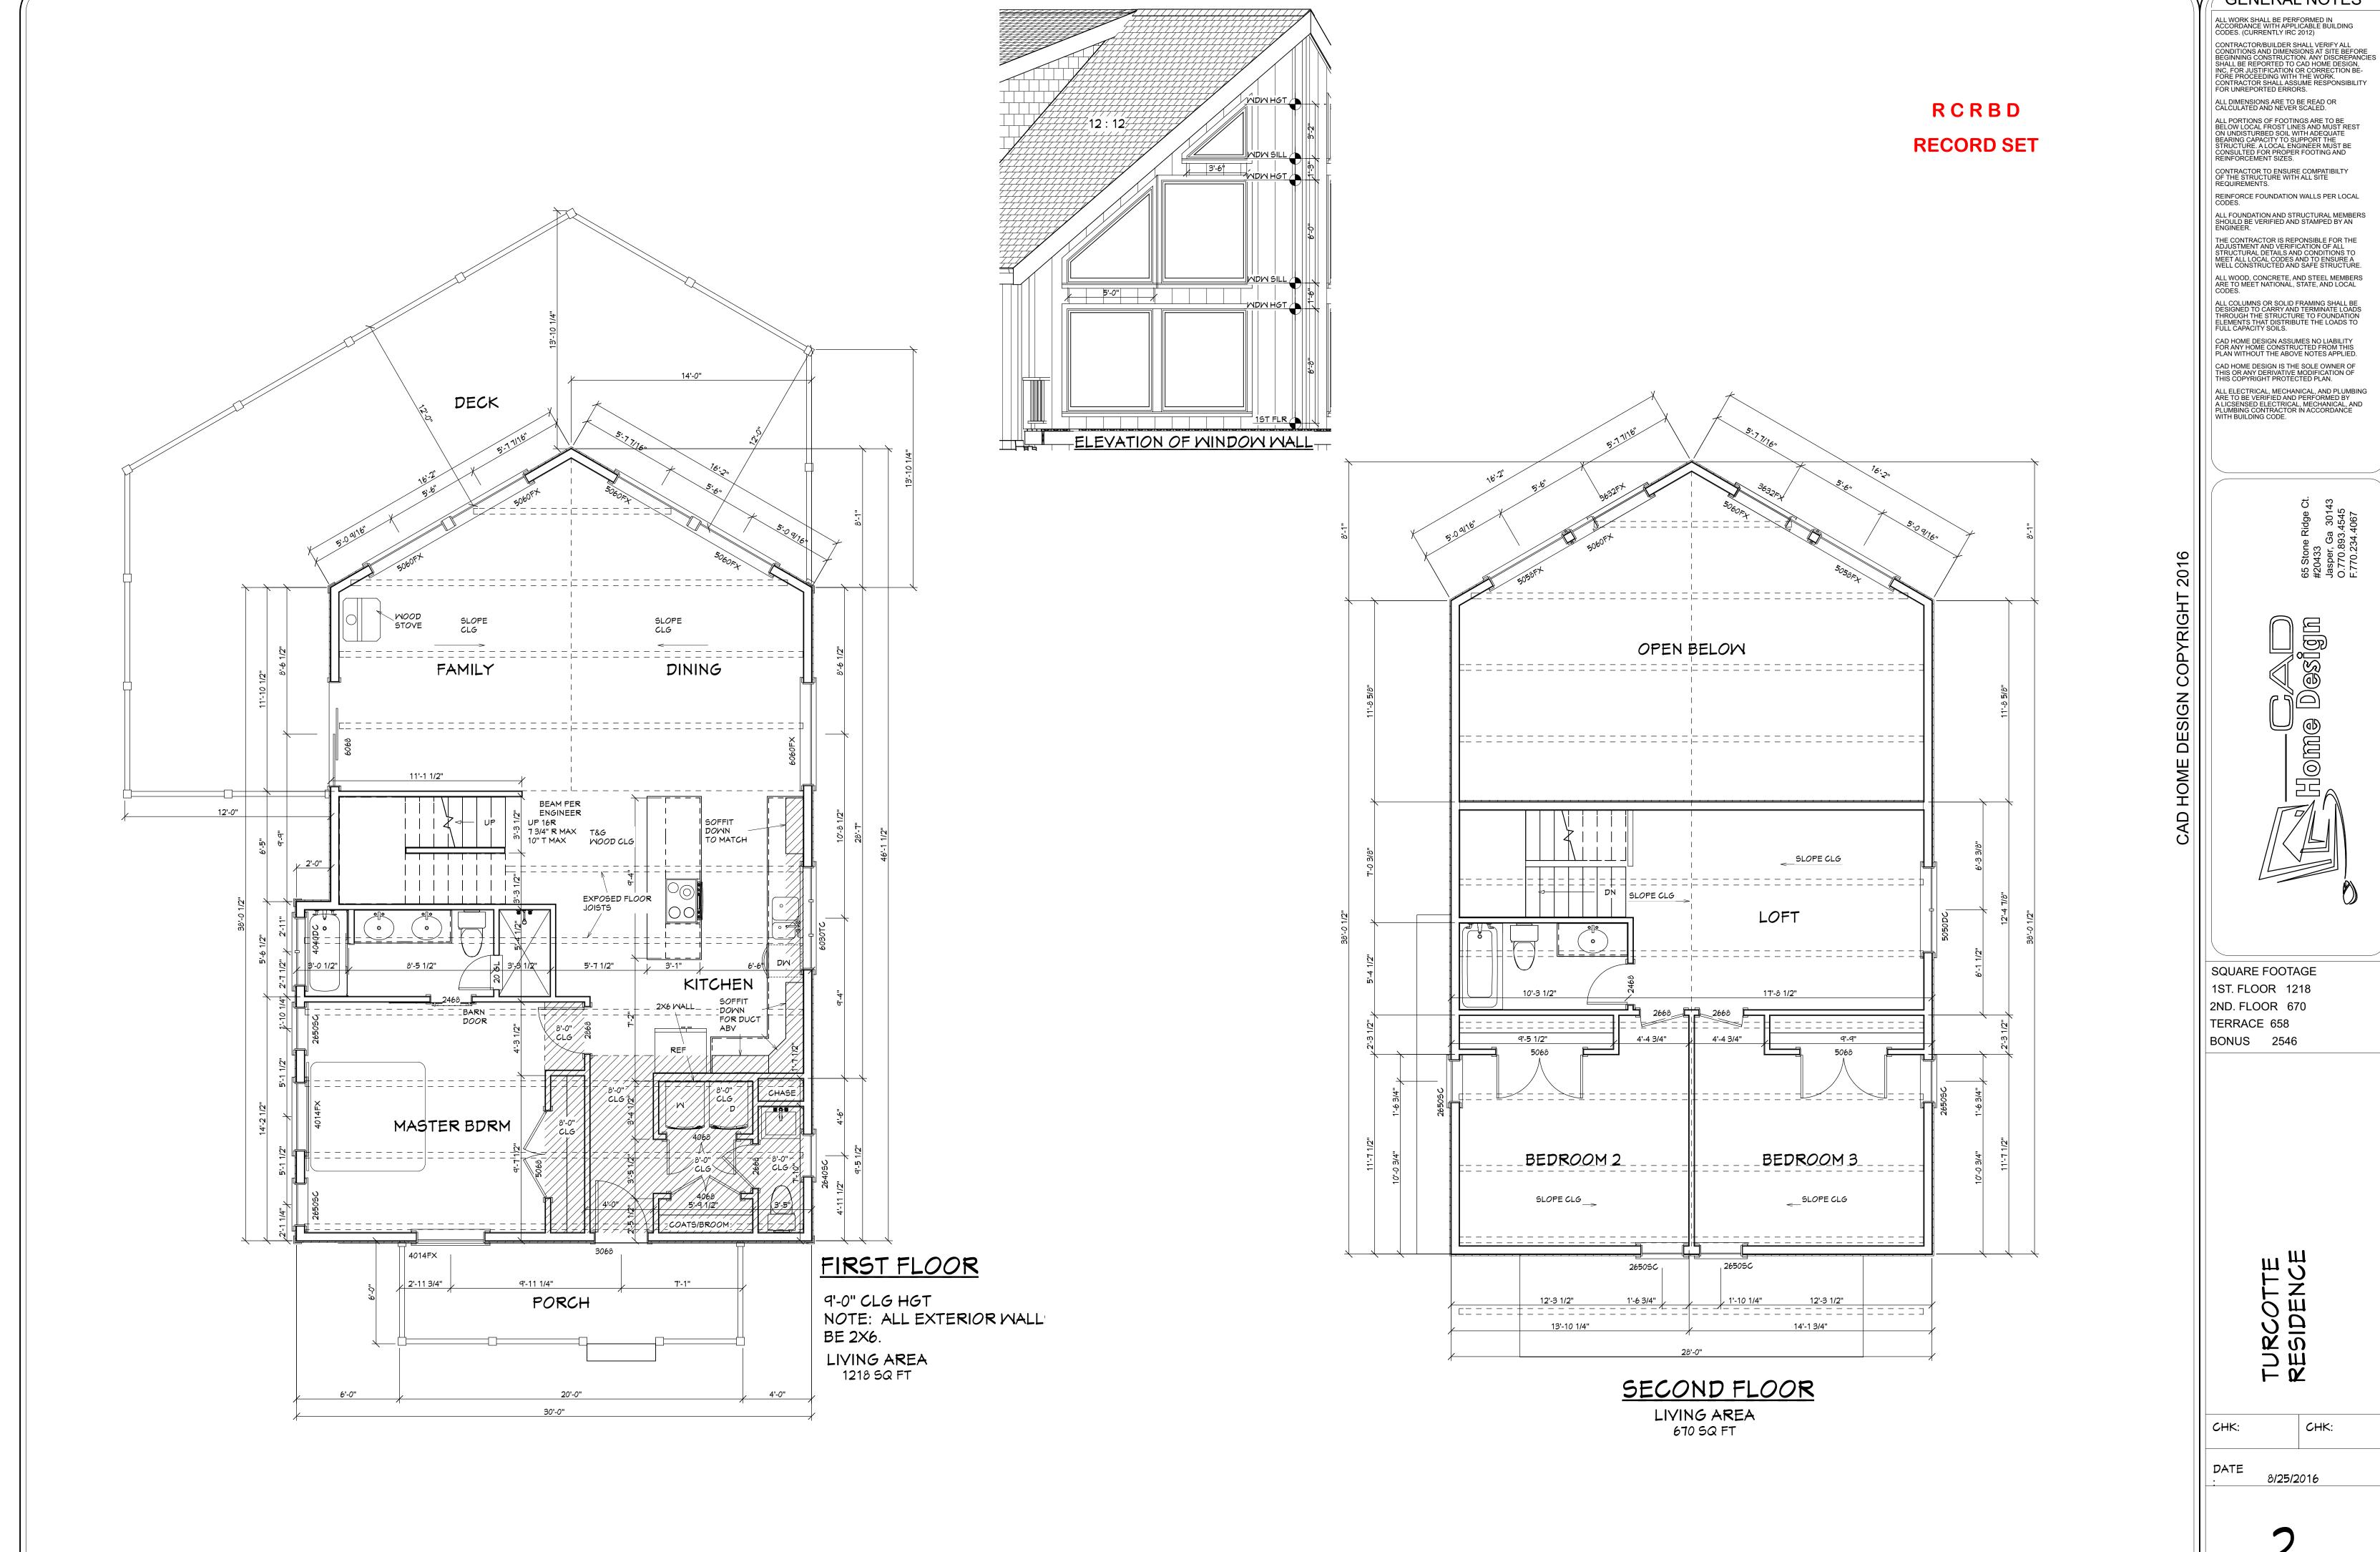


GENERAL NOTES

REINFORCE FOUNDATION WALLS PER LOCAL CODES.

R C R B D RECORD SET

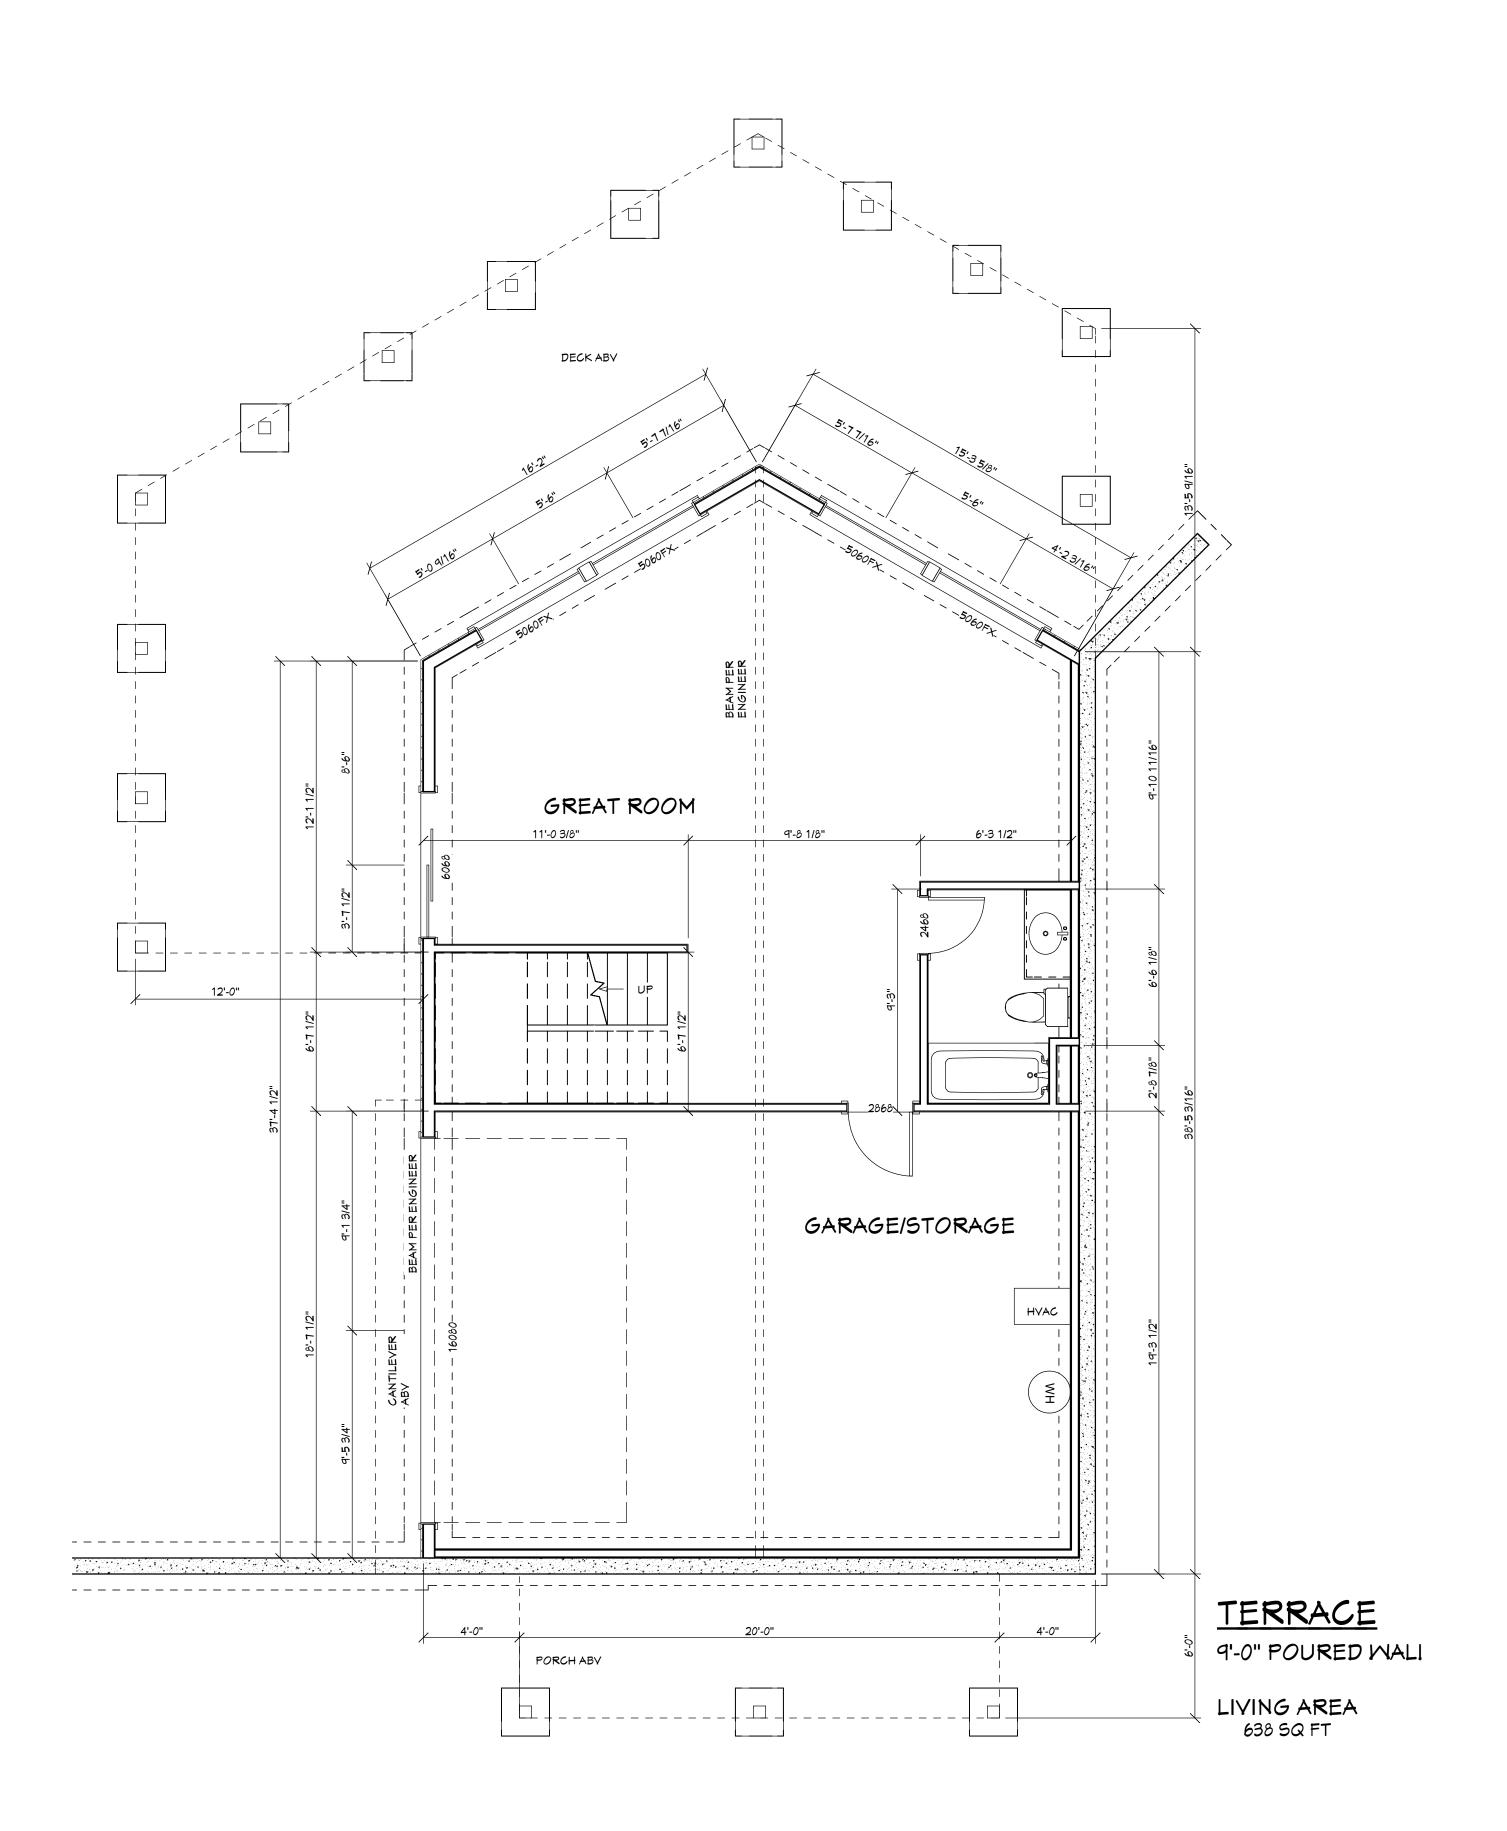

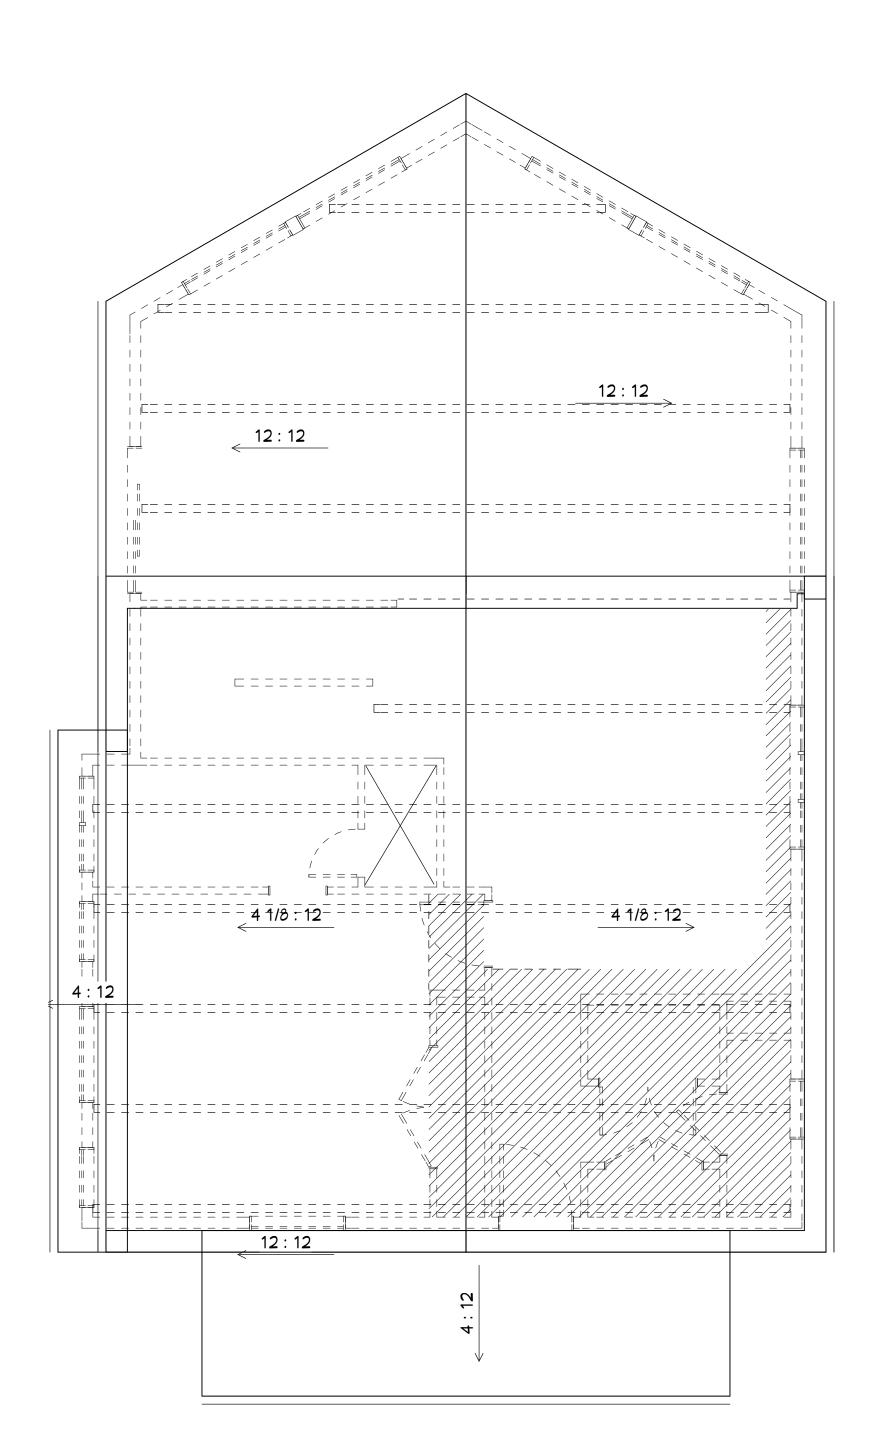

ROOF PLAN


GENERAL NOTES ALL WORK SHALL BE PERFORMED IN ACCORDANCE WITH APPLICABLE BUILDING CODES. (CURRENTLY IRC 2012) CONTRACTOR/BUILDER SHALL VERIFY ALL CONDITIONS AND DIMENSIONS AT SITE BEFORE BEGINNING CONSTRUCTION. ANY DISCREPANCIES SHALL BE REPORTED TO CAD HOME DESIGN, INC, FOR JUSTIFICATION OR CORRECTION BEFORE PROCEEDING WITH THE WORK.
CONTRACTOR SHALL ASSUME RESPONSIBILITY FOR UNREPORTED ERRORS. ALL PORTIONS OF FOOTINGS ARE TO BE BELOW LOCAL FROST LINES AND MUST REST ON UNDISTURBED SOIL WITH ADEQUATE BEARING CAPACITY TO SUPPORT THE STRUCTURE. A LOCAL ENGINEER MUST BE CONSULTED FOR PROPER FOOTING AND REINFORCEMENT SIZES. CONTRACTOR TO ENSURE COMPATIBILTY OF THE STRUCTURE WITH ALL SITE REQUIREMENTS. REINFORCE FOUNDATION WALLS PER LOCAL CODES. ALL FOUNDATION AND STRUCTURAL MEMBERS SHOULD BE VERIFIED AND STAMPED BY AN ENGINEER. THE CONTRACTOR IS REPONSIBLE FOR THE ADJUSTMENT AND VERIFICATION OF ALL STRUCTURAL DETAILS AND CONDITIONS TO MEET ALL LOCAL CODES AND TO ENSURE A WELL CONSTRUCTED AND SAFE STRUCTURE. ALL WOOD, CONCRETE, AND STEEL MEMBERS ARE TO MEET NATIONAL, STATE, AND LOCAL CODES. ALL COLUMNS OR SOLID FRAMING SHALL BE DESIGNED TO CARRY AND TERMINATE LOADS THROUGH THE STRUCTURE TO FOUNDATION ELEMENTS THAT DISTRIBUTE THE LOADS TO FULL CAPACITY SOILS. CAD HOME DESIGN ASSUMES NO LIABILITY FOR ANY HOME CONSTRUCTED FROM THIS PLAN WITHOUT THE ABOVE NOTES APPLIED. CAD HOME DESIGN IS THE SOLE OWNER OF THIS OR ANY DERIVATIVE MODIFICATION OF THIS COPYRIGHT PROTECTED PLAN. ALL ELECTRICAL, MECHANICAL, AND PLUMBING ARE TO BE VERIFIED AND PERFORMED BY A LICSENSED ELECTRICAL, MECHANICAL, AND PLUMBING CONTRACTOR IN ACCORDANCE WITH BUILDING CODE. 2016 SQUARE FOOTAGE 1ST. FLOOR 1218 2ND. FLOOR 670 TERRACE 658 BONUS 2546 TURCOTTE RESIDENCE CHK: CHK:

3

8/25/2016

DATE

R C R B D RECORD SET

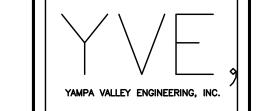

STRUCTURAL
MECHANICAL
ENGINEERING
DESIGN
DRAFTING
SERVICES

JAMES STEGMAIER, P.E. 1794 KAMAR PLAZA P.O. BOX 772192 STEAMBOAT SPRINGS, CO 80477 970-870-9229 yvengr@yvengr.com

E RESIDENCE
LOT 1D
County, Colorado


JOB NO: 16-067
DRAWN: BAB
DATE: 09-10-16

REVISIONS

NO. DATE DRAWN

SHEET NUMBER

A-4

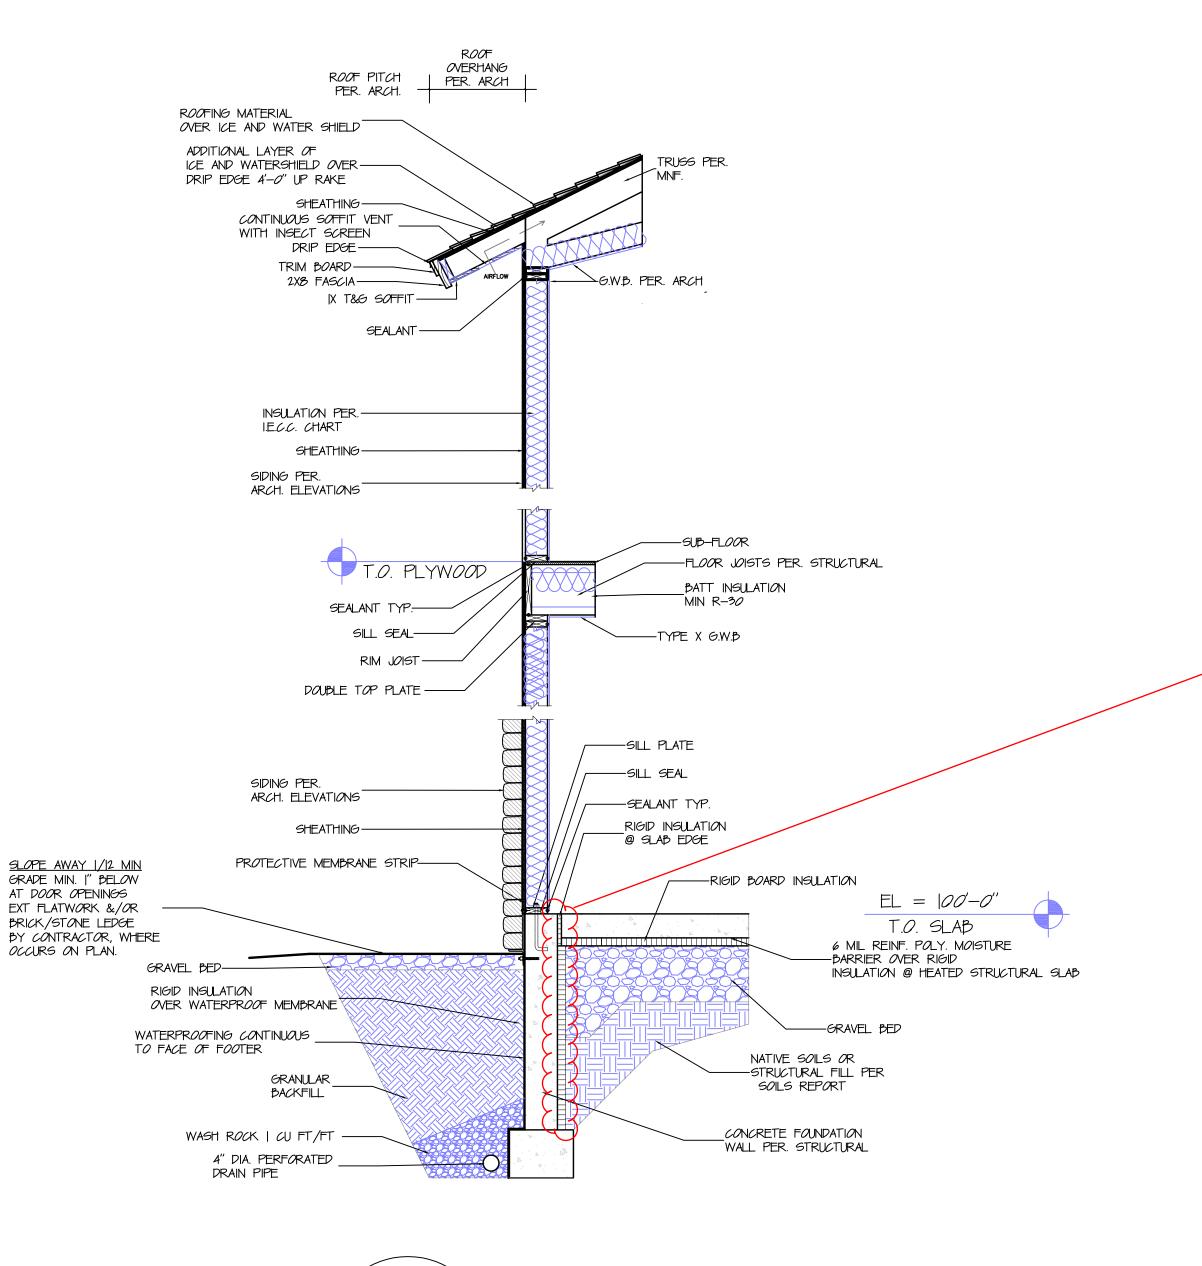

TYP WALL SECTION

SCALE 1/2" = 1'-0"

Specify insulation requirements for slabs. These requirements apply only to slabs 12 inches (305 mm) or less below grade. The listed R-value requirements in the table are for unheated slabs. A heated slab must add another R-5 to the required insulation levels based on Note d of Table 402.1.1. Accordingly, a heated slab shall also have insulating materials having a minimum R-value of 5 installed in accordance with Section M2103.2 of the 2009 IRC plus another R-5 for the slab edge component as applicable. The insulation must extend downward from the top of the slab or downward to the bottom of the slab and then horizontally in either direction until the distance listed in Table 402.1.1 is reached. Correct the building sections to reflect this requirement along with any additional requirements for insulation of heated slabs, if applicable.

											,
2009 IECC PRESCRIPTIVE METHOD - TABLE 402.[.]											
INSULATION AND FENESTRATION REQUIREMENTS BY COMPONENT(a)											
COUNTY	CLIMATE ZONE	FENESTRATION U-FACTOR	SKYLIGHT(b) U-FACTOR	GLAZED FENESTRATION SHGC	CEILING R-VALUE	W <i>OOD</i> FRAME _K WALL R-VALUE	MASS WALL R-VALUE	FL <i>OO</i> R R-VALUE	BASEMENT(c) WALL R-VALUE	SLAB(d) R-VALUE & DEPTH	CRAWL SPACE(c) WALL R-VALUE
R <i>O</i> UTT	7 & 8	0.35	0.60	NR	49	2	19	30(f)	10 OR 13	10, 4 FT.	10 OR 13

For SI: | foot = 3048 mm.

(a) R-values are minimums. U-factors and SHOC are maximums. R-19 shall be permitted to be compressed into a 2x6 cavity

(b) The fenestration U-factor column excludes skylights. The SHOC column applies to all glazed fenestration. (c) The first R-value applies to coninuous insulation, the second to framing cavity insulation, either

insulation meets the requirement.


(d) R-5 shall be added to the required slab edge R-values for heated slabs.


(d) R—5 shall be added to the required slab edge R—values for heated slabs. (e) There are no SHGC requirements in the Marine zone.

(f) Or insulation sufficient to fill the framing cavity, R-19 minimum.

(g) "13+5" means R-13 cavity insulation plus R-5 insulated sheathing. If structural sheathing covers 25 percent or less of the exterior, insulating sheathing is not required where structural sheathing in used. If

structural sheathing covers more than 25 percent of exterior, structural sheathing shall be supplemented with insulated sheathing of at least R-2.

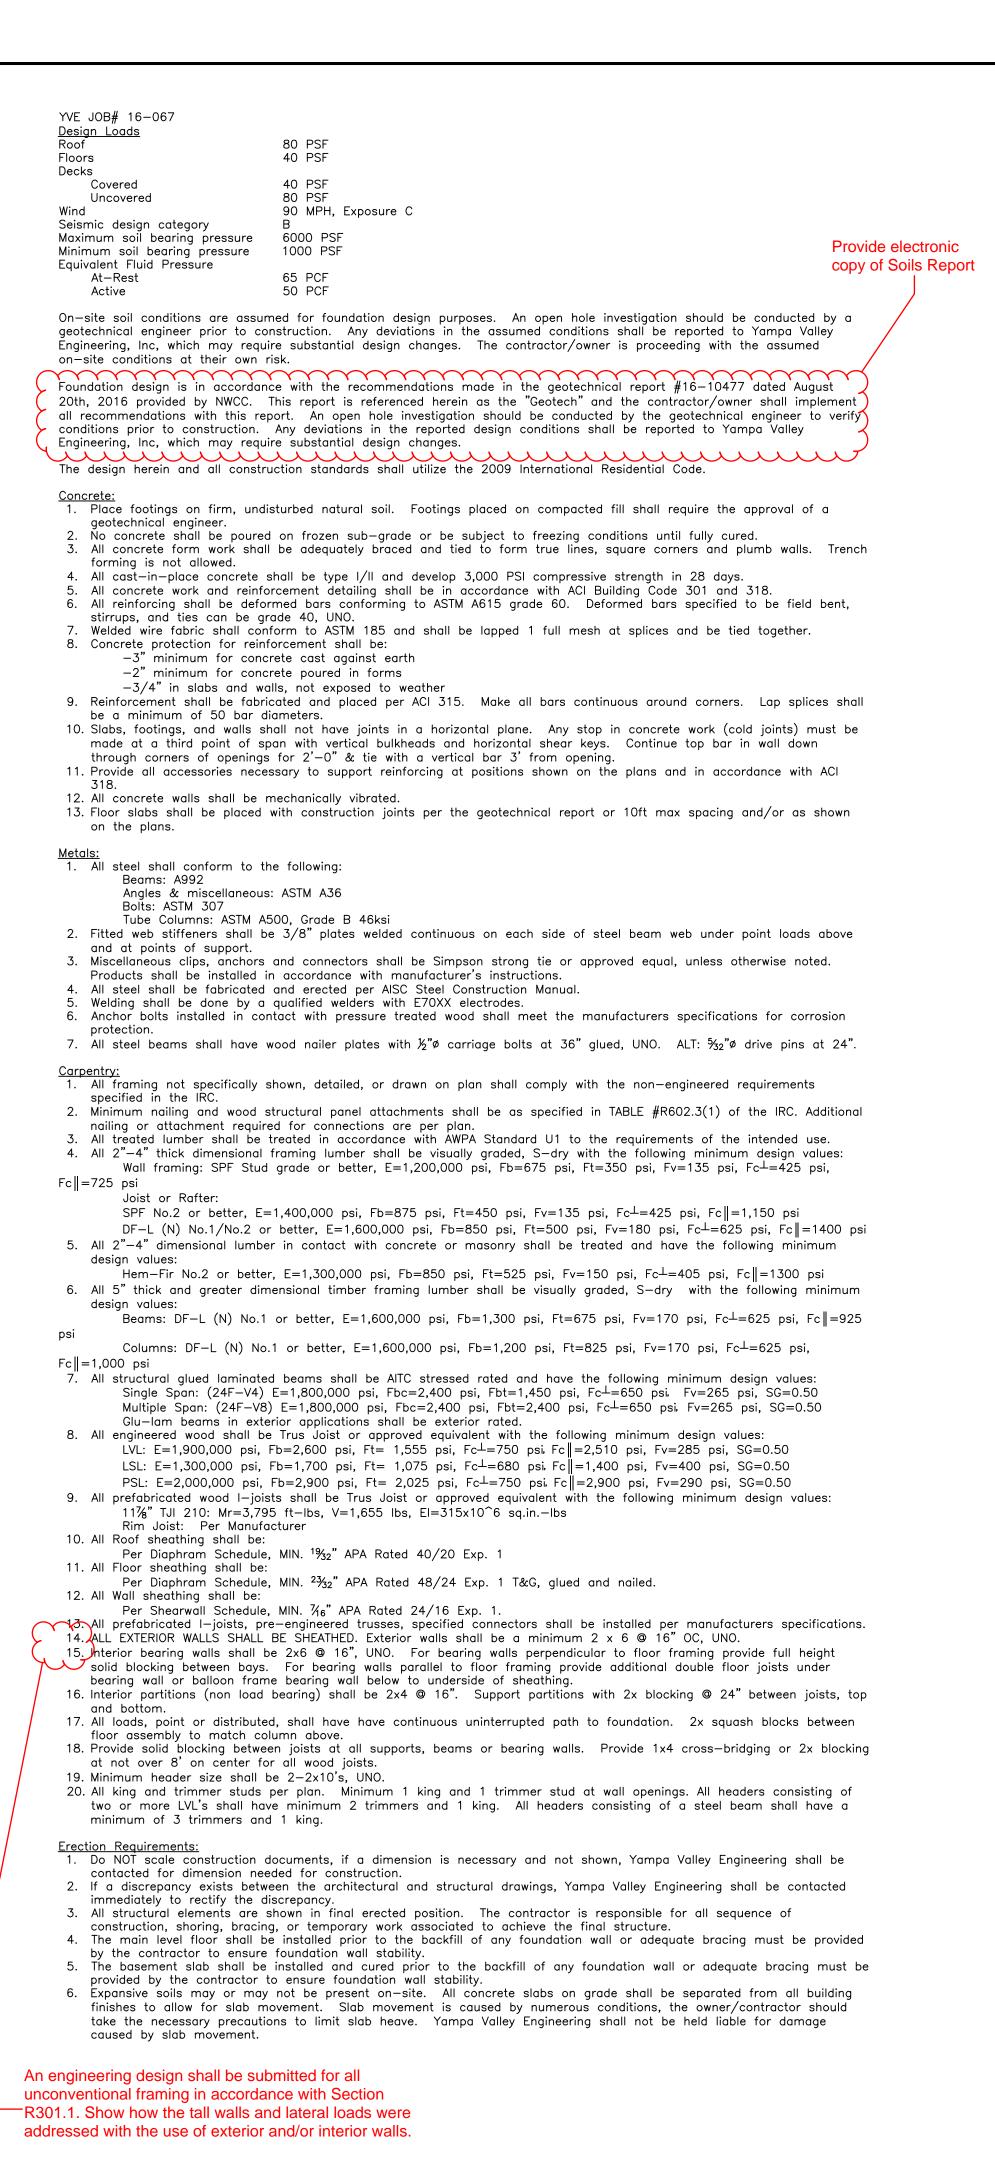

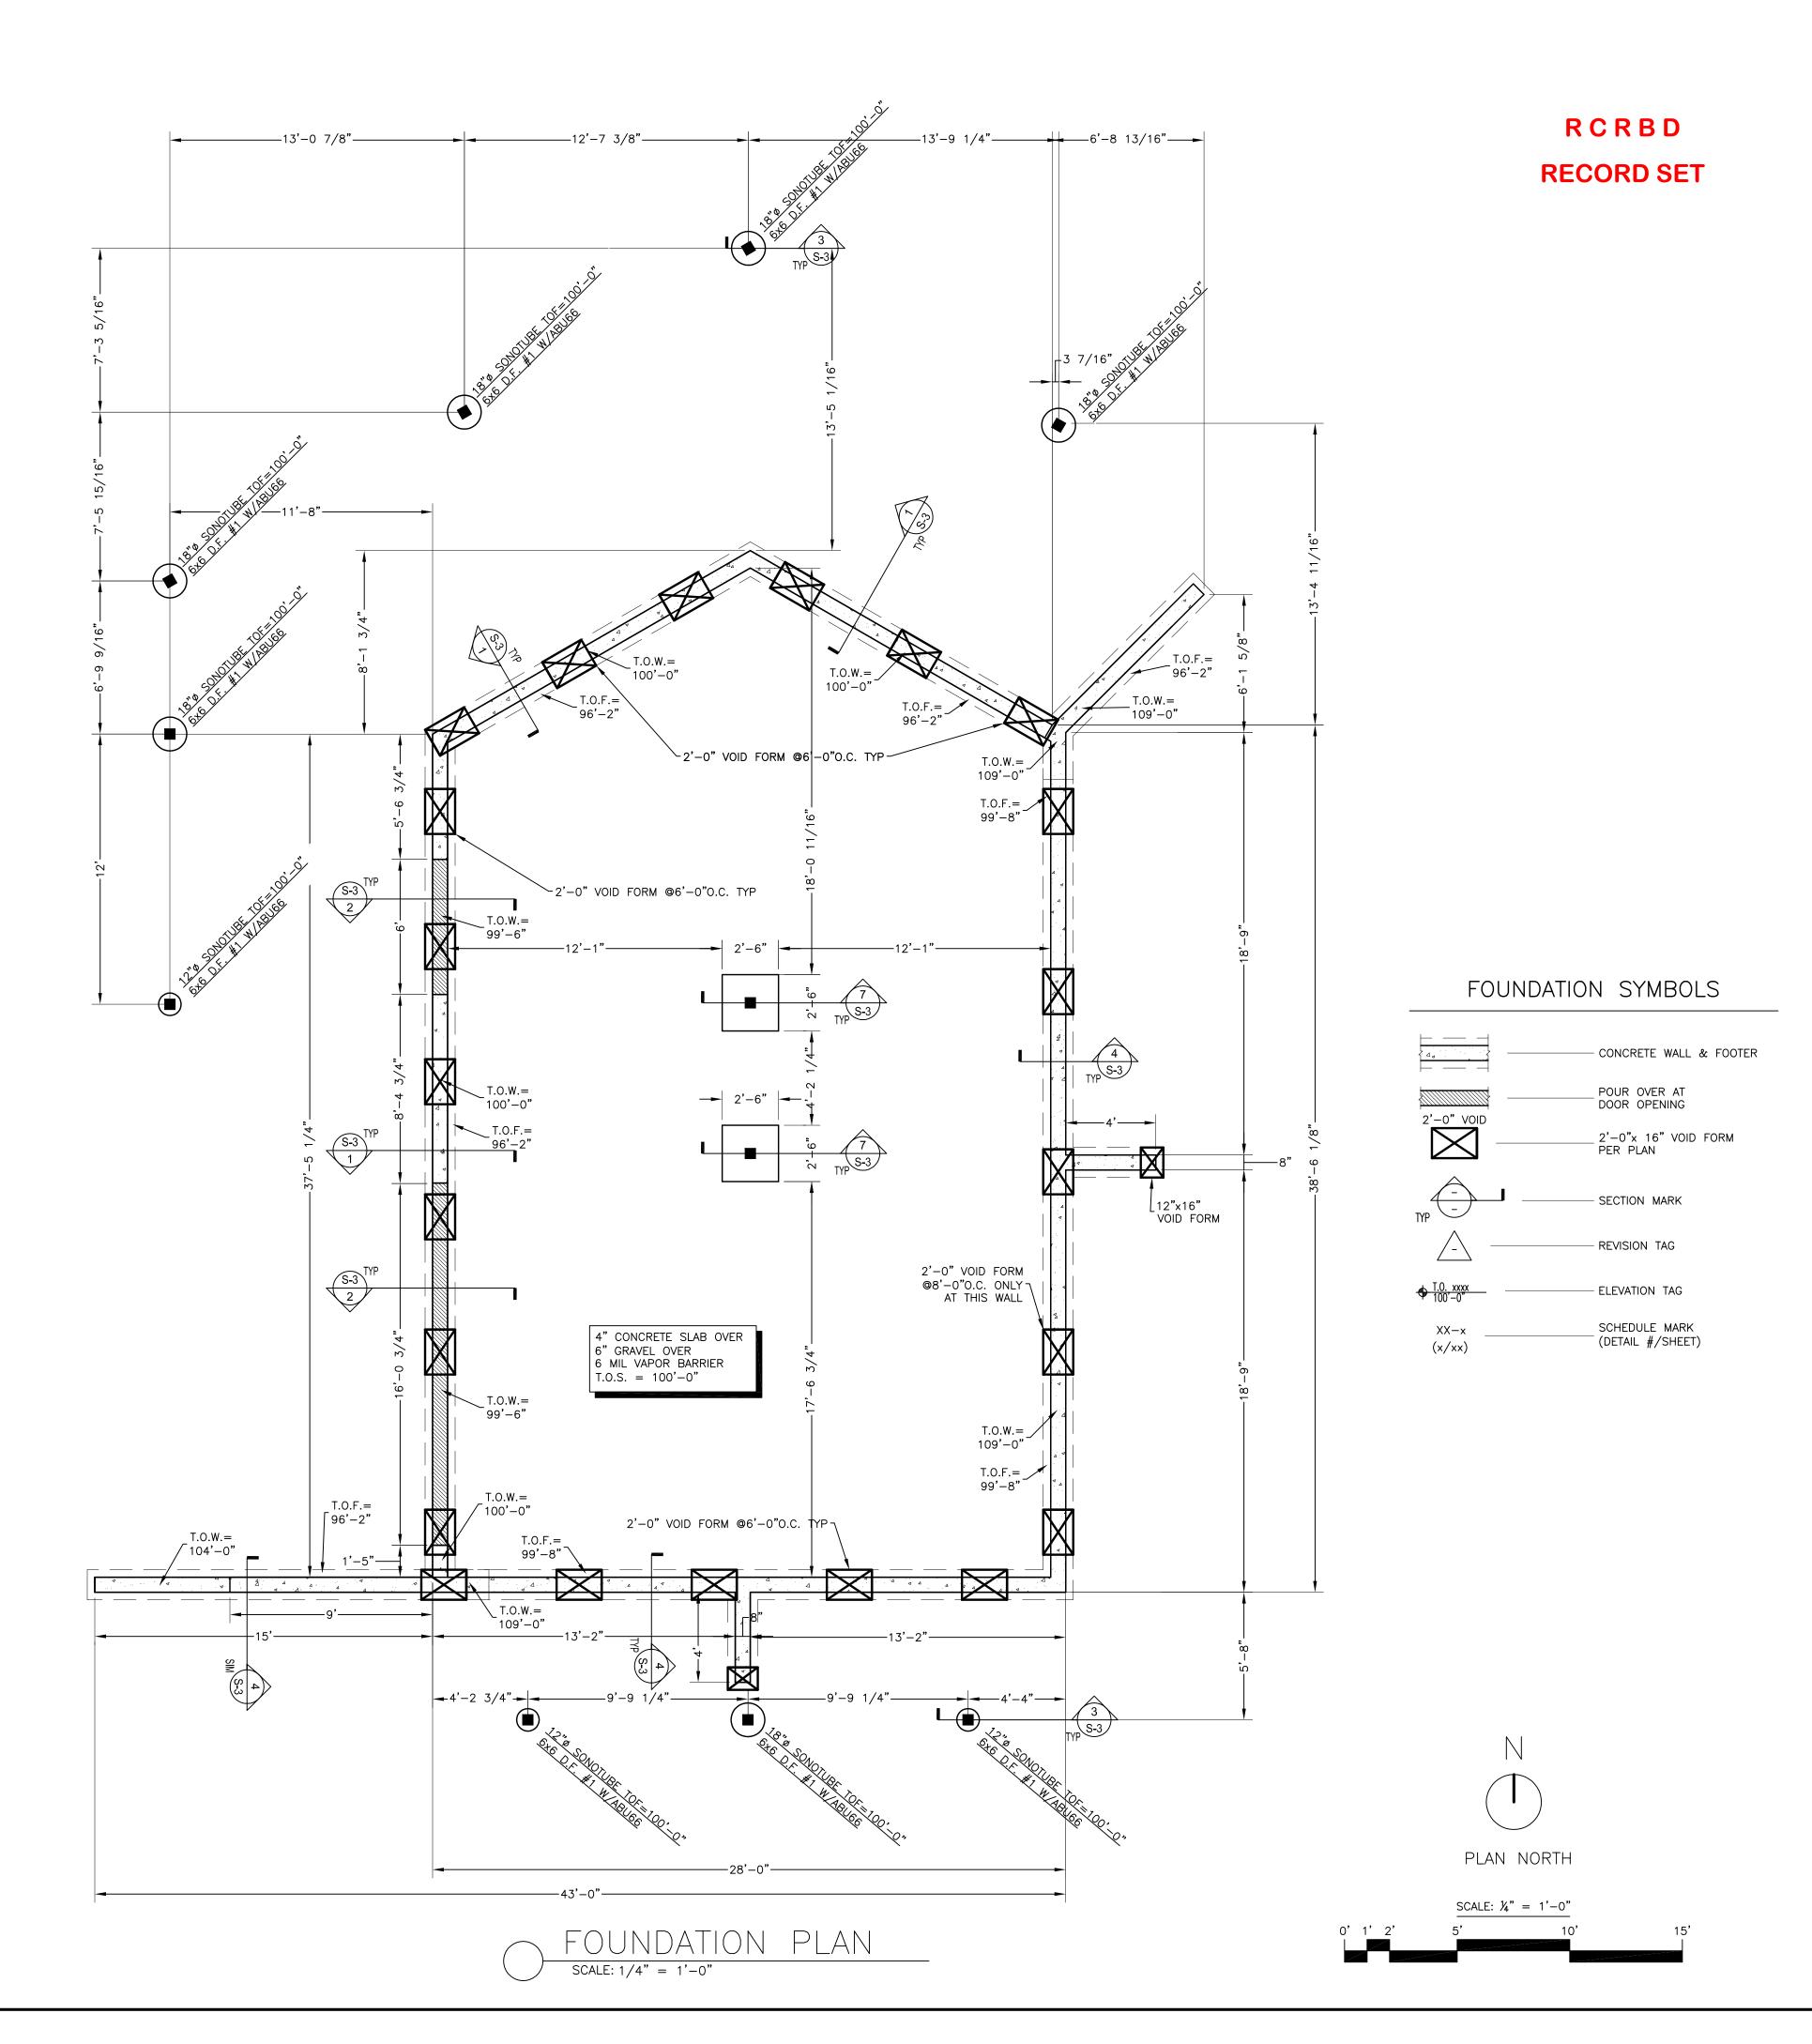

YAMPA VALLEY ENGINEERING, INC

STRUCTURAL MECHANICAL **ENGINEERING** DESIGN

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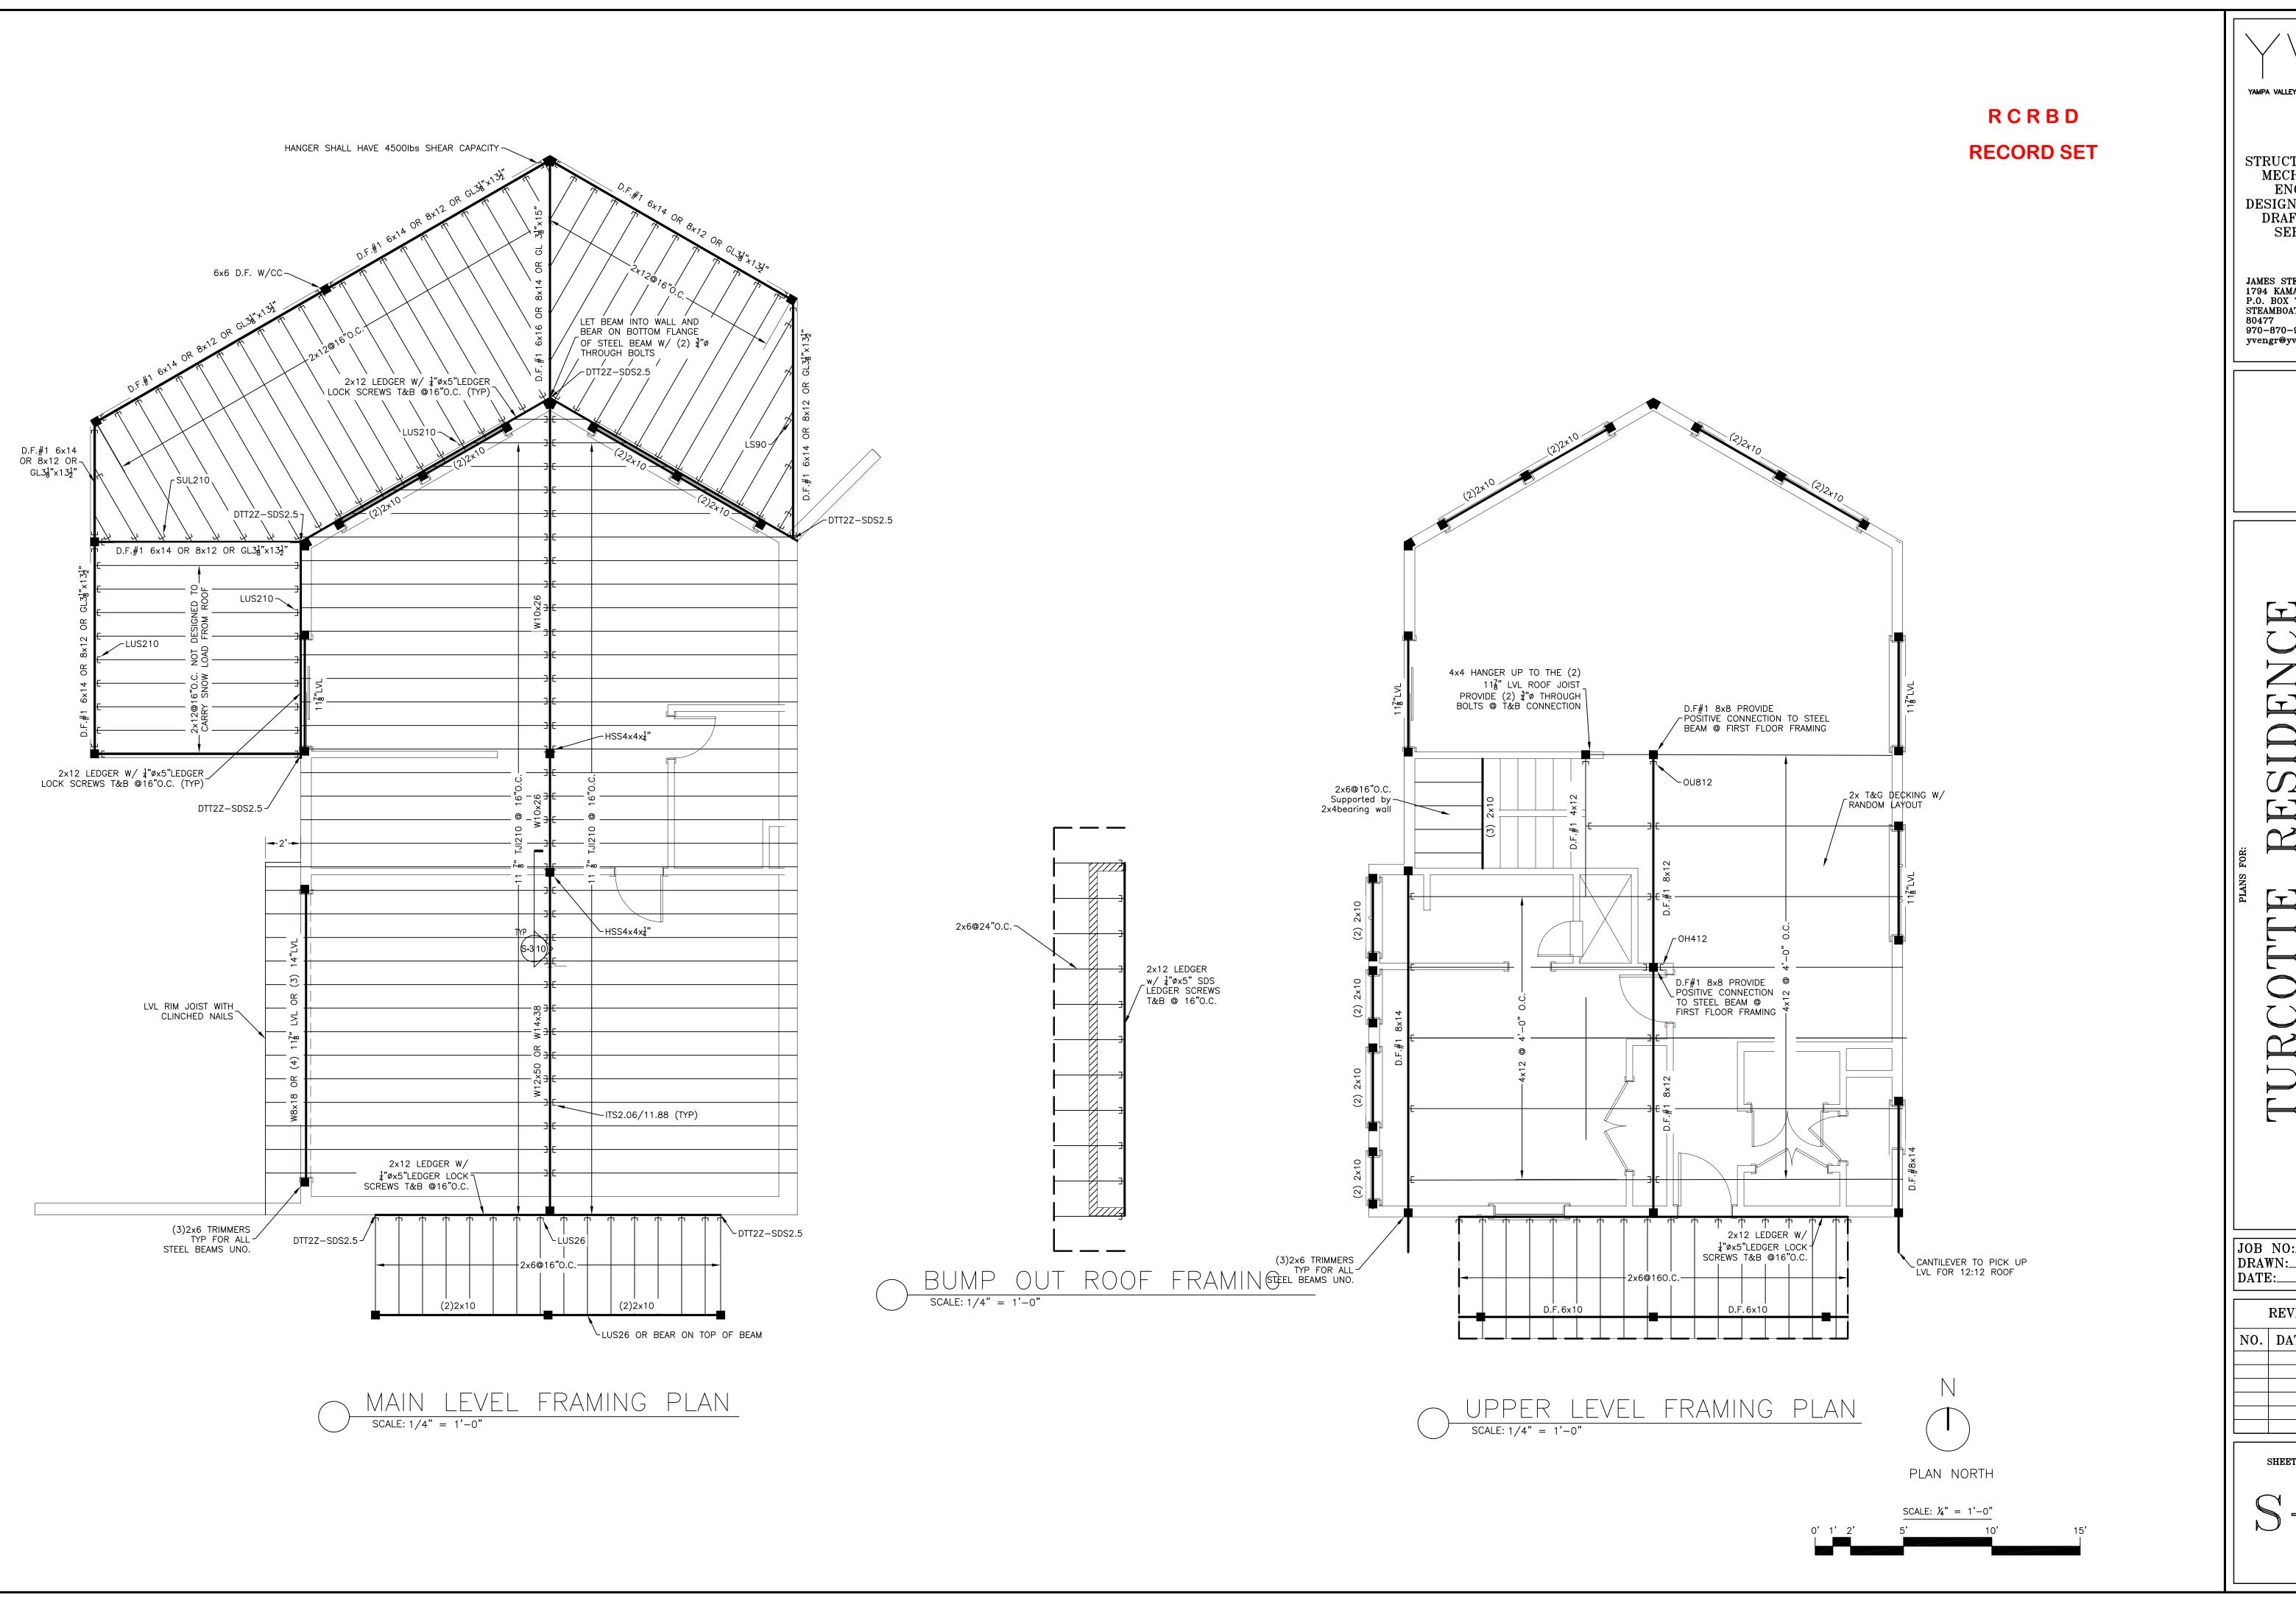
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JOB NO: 16-067 DRAWN: BAB **DATE:** 09-10-16

REVISIONS

NO. | DATE | DRAWN

SHEET NUMBER



YAMPA VALLEY ENGINEERING, INC.

STRUCTURAL MECHANICAL **ENGINEERING** DESIGN DRAFTING SERVICES

JAMES STEGMAIER, P.E. 1794 KAMAR PLAZA P.O. BOX 772192 STEAMBOAT SPRINGS, CO 970-870-9229 yvengr@yvengr.com

lD , Colorado LOT 11 County,


JOB NO: 16-067 DRAWN: BAB **DATE:** 09-10-16

REVISIONS

NO. DATE DRAWN


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SHED DOMER ROOF FRAMING PLAN

SCALE: 1/4" = 1'-0"

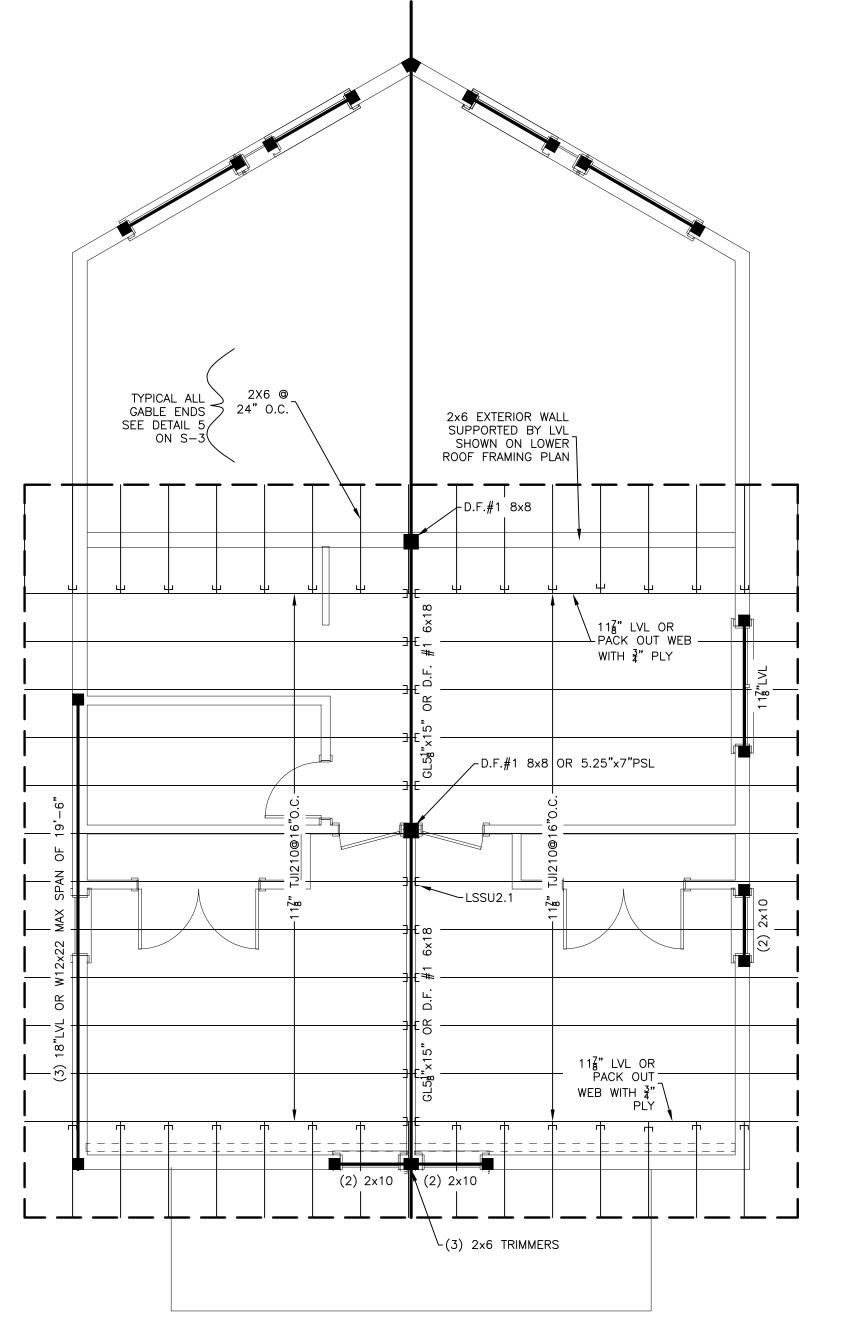

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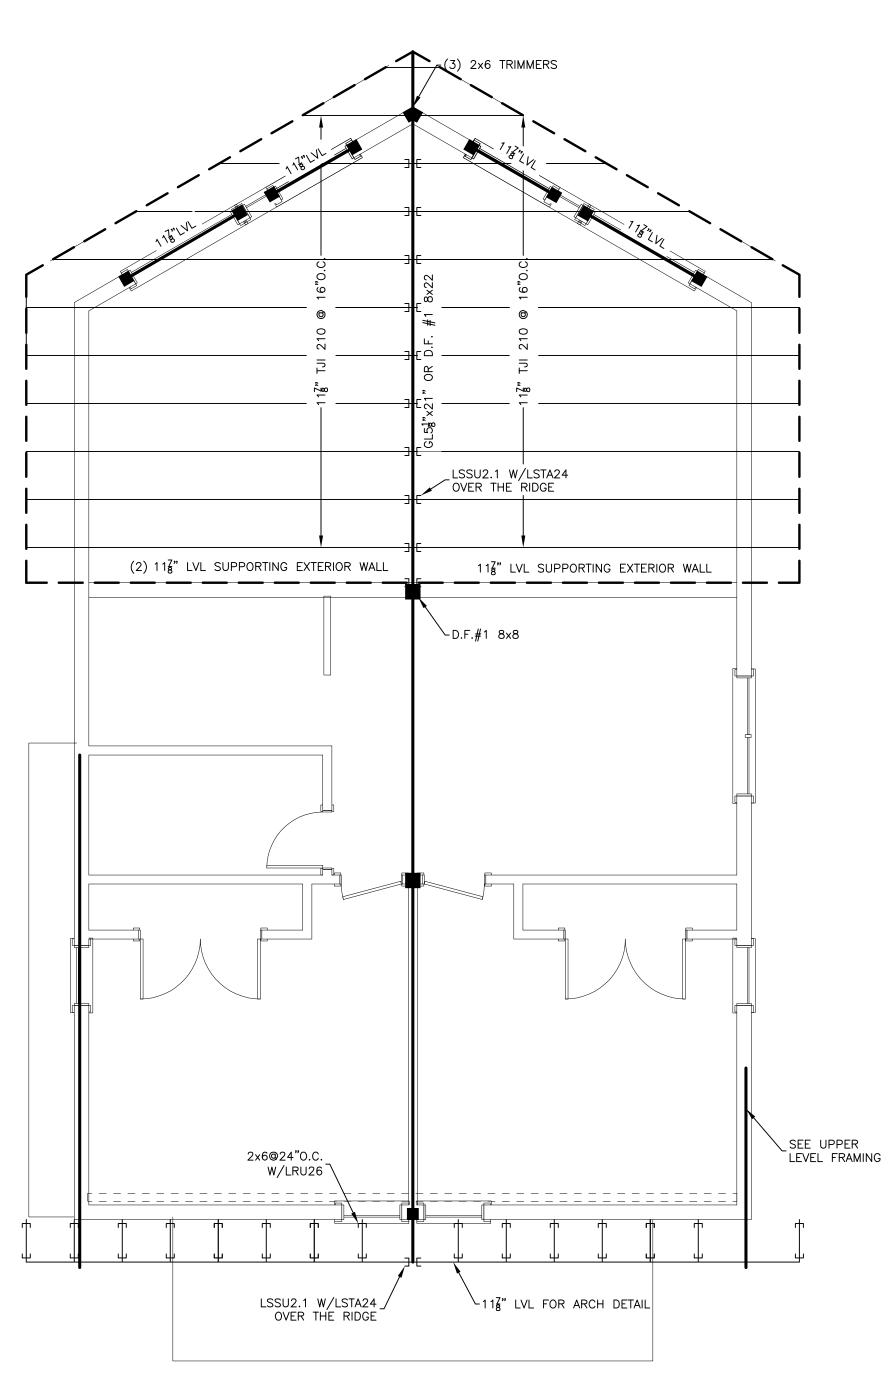
JOB NO: 16-067
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REVISIONS
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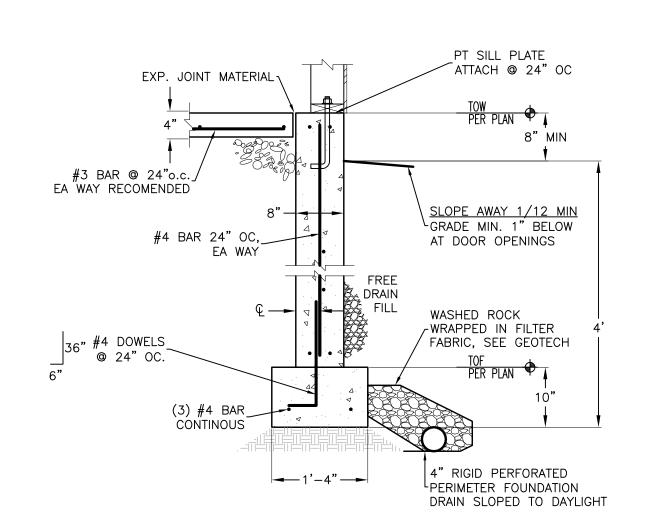
SHEET NUMBER

5-2

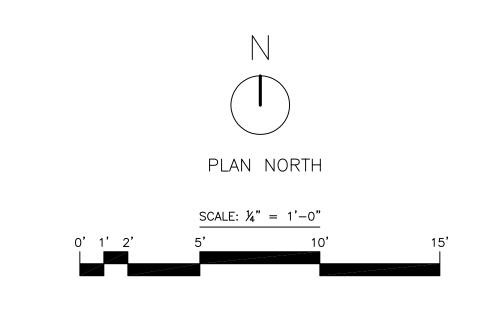

LOWER ROOF FRAMING PLAN

SCALE: 1/4" = 1'-0"




NOTES:

1. MAINTAIN 3" COVER FOR CONC. POURED ON EARTH. 2" FOR FORMED CONC.

2. ENERGY CODE DETAILS PER ARCHITECTUAL PLANS.

CONCRETE WALL

NO SCALE

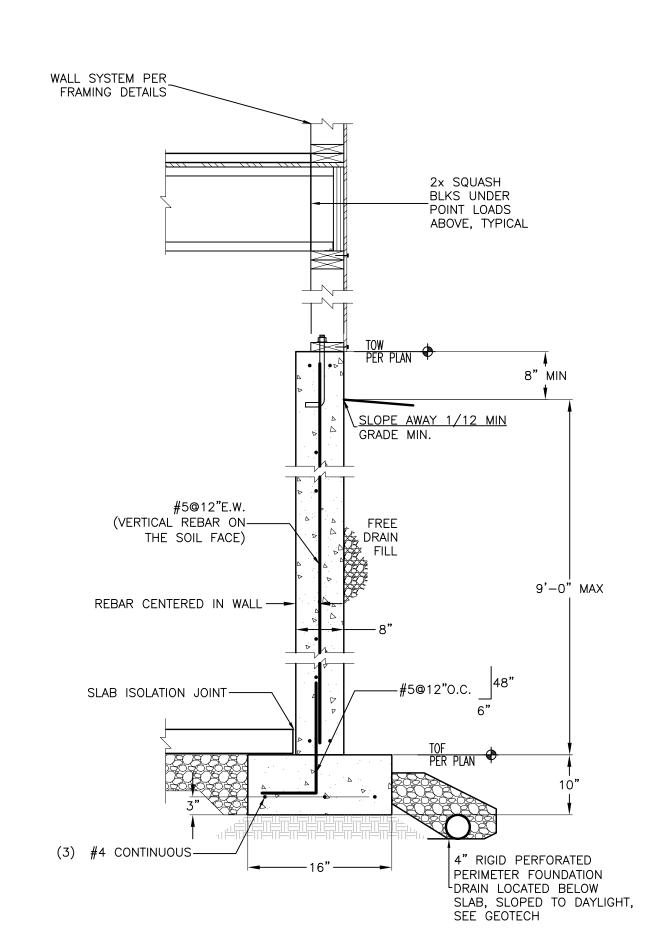


NOTES:

1. MAINTAIN 3" COVER FOR CONC. POURED ON EARTH. 2" FOR FORMED CONC.

2. ENERGY CODE DETAILS PER ARCHITECTUAL PLANS.

NO SCALE

8" CONCRETE WALL W/ CONTERFORTS

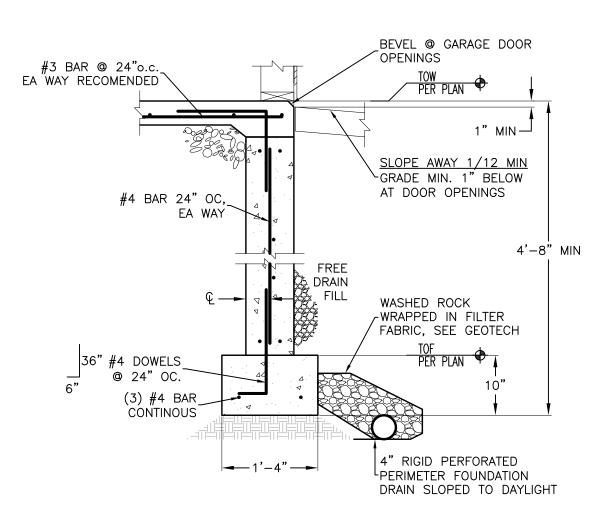


NOTES:

1. MAINTAIN 3" COVER FOR CONC. POURED ON EARTH. 2" FOR FORMED CONC.

2. ENERGY CODE DETAILS PER ARCHITECTUAL PLANS.

CONCRETE WALL @ DOOR OPENING


NO SCALE

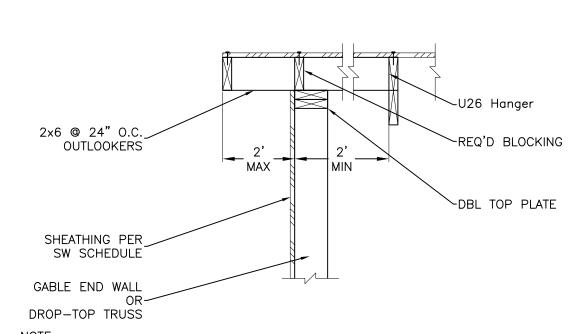

NOTE:

1. ENERGY CODE DETAILS PER ARCHITECTUAL PLANS

2. PROPER TOE—NAILING FROM BLOCKING TO TOP PLATE w/ 0.148ø (10d COMMON) NAILS AT 6" O.C. BOTH SIDES STAGGERED

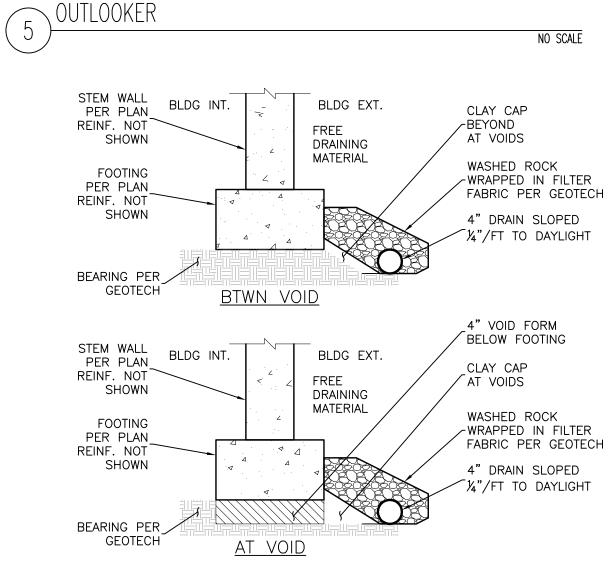

NOTES:


1. PLACE VOID FORM UNDER HEADERS OR PER PLAN IF SPECIFIED.

2. AVOID PLACING VOID UNDER POINT LOADS FROM ABOVE.

3. ENERGY CODE DETAILS PER ARCHITECTUAL PLANS.

6 TYP VOID FORM


NO SCALE

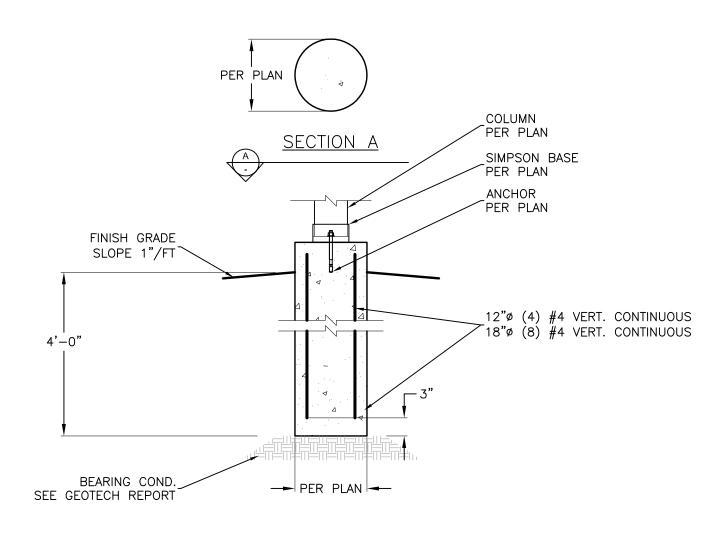

NOTES:

1. MAINTAIN 3" COVER TO CONC. POURED ON EARTH. 2" TO FORMED CONC.

SONOTUBE NO SCALE

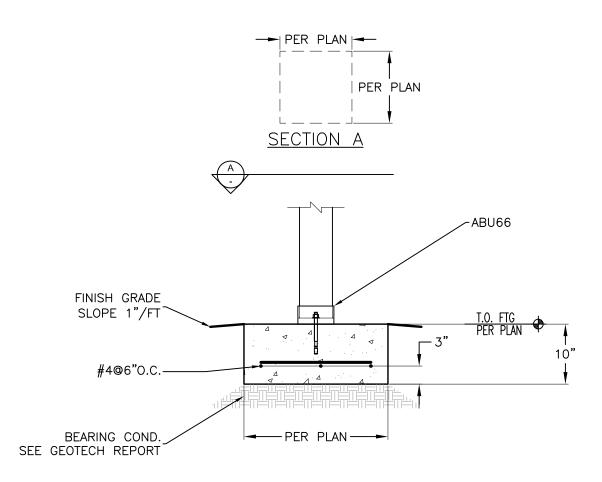



NOTES:

1. MAINTAIN 3" COVER FOR CONC. POURED ON EARTH. 2" FOR FORMED CONC.

2. ENERGY CODE DETAILS PER ARCHITECTUAL PLANS.


7 CONCRETE PAD NO SCALE

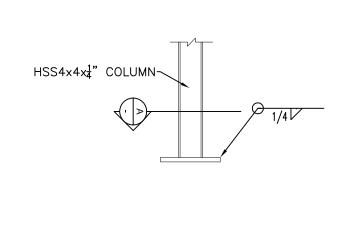

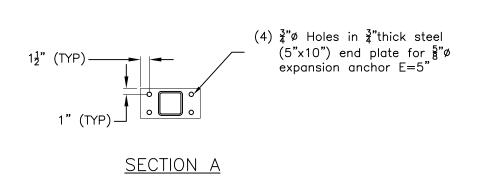


NO SCALE

STEEL COLUMN BASEPLATE FOR HSS4x4x1/4

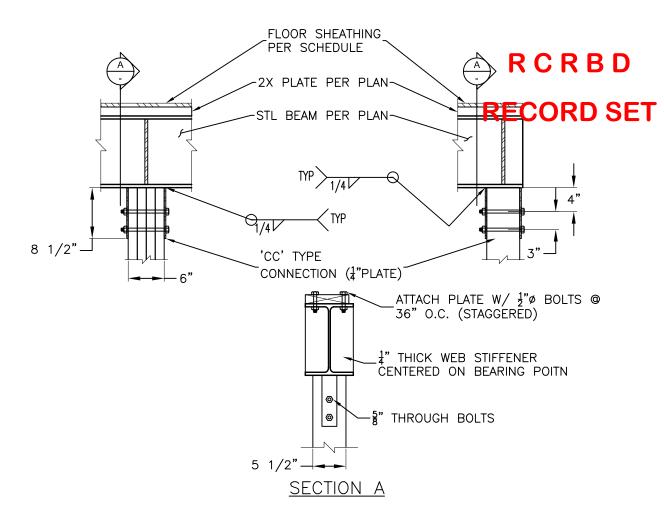

STEEL BEAM TO WOOD COLUMN

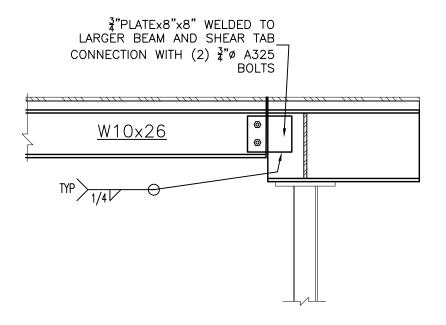

NO SCALE

NO SCALE

STEEL BEAM TO STEEL BEAM CONNECTION

TURCOTTE RESIDEL

LOT 1D

Routt County, Colorado

YAMPA VALLEY ENGINEERING, INC

STRUCTURAL

DRAFTING

SERVICES

JAMES STEGMAIER, P.E.

STEAMBOAT SPRINGS, CO

1794 KAMAR PLAZA P.O. BOX 772192

yvengr@yvengr.com

970-870-9229

DESIGN

MECHANICAL

ENGINEERING

JOB NO:	16-067							
DRAWN:_								
DATE:	09-10-1							
REV	REVISIONS							

REVISIONS

NO. DATE DRAWN

SHEET NUMBER

S-3