Restroom Building

Haymaker Golf Course

Code Compliance

Applicable Codes:

2012 International Building Code (IBC) 2012 International Plumbing Code (IPC) 2015 International Energy Conservation Code (IECC) 2014 National Electrical Code (NEC)

Type of Construction:

Park Restroom Description:

Occupancy:

Floor Area:


96 square feet

Job Number:

18883-86

General Notes

- The Structural Design Details Herein are Specific to the Building Size and Module Configuration Shown on the Floor Plan of These Drawings.
- No Authorization is Given or Implied for use of the Modules in the Initial or Subsequent Installation Which Results in a Building Size or Installed Module Configuration Different Than Shown on These Drawings.
- This Building will be sited a minimum of 10 feet from all Property Lines and 10 feet from any assumed Property Lines between existing structures on this site.
- Site contractor bears responsibility for providing handicap accessibility to this
- Note: The structure is being assembled & inspected in the factory and installed on top of the engineered precast vault / foundation.

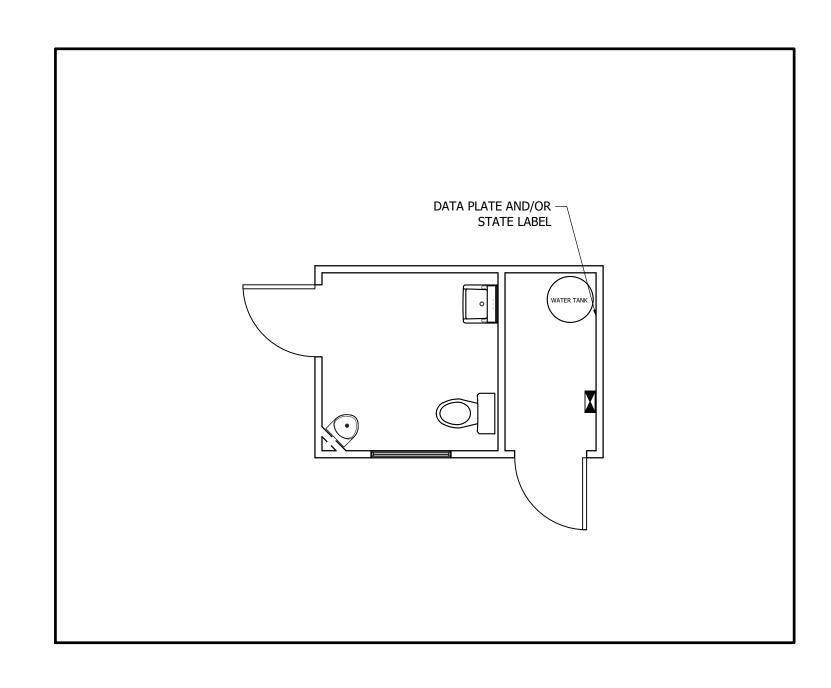

Index to Drawing

- T-1 Title Sheet.
- AC Accessibility Compliance.
- A-1 Floor Plan, Section, Roof Framing Plan, Structural Design, Door Schedule.
- A-2 Exterior Elevations, Exterior Finish Schedule, Interior Elevations, Interior Finish Schedule. Accessories Schedule.
- A-3 Details, Fastening Schedule.
- PE-1 Plumbing & Electrical Schematics and Information
- S-1 Vault Plan.
- S-2 Slab Plan, Rebar Plan

Project Information

Owner:

Haymaker Golf Course 34855 US Hwy. 40 East Steamboat Springs, CO 80487

Dealer:

Green Flush Technologies 10308 SE 15th St. Vancouver, WA 98664

Builder:

Blazer Industries, Inc. PO Box 489 Aumsville, OR 97325 Contact: John Roth Phone: (503) 749-1900 Fax: (503) 749-3969 E-mail: johnr@blazerind.com



DESIGN LOADS:

Design/Risk Cat II Site Elev. 6830'±

> Ground & Roof Snow (2016 SEAC Snow Loads) Load Duration Factor for Snow Roof Dead.

Wind Exposure Wind Speed ASD

Floor Live


90 mph (ASCE 7-05) 115 mph (ASCE 7-10)

Seismic ASCE 7 Simplified

Wind Speed, Ultimate

Site Class .. Seismic Design Category .. R (Wood Panel Walls) 1 Kip, 4.4%

NOTE: Vault & Foundation Designed & Certified by others.

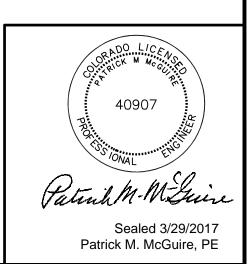

DATE REV# REVISION REVISION DATE REV#




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PROJECT NAME & LOCATION: Haymaker Golf Course Colorado


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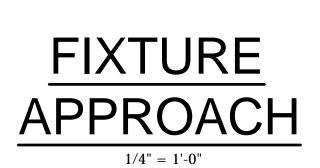
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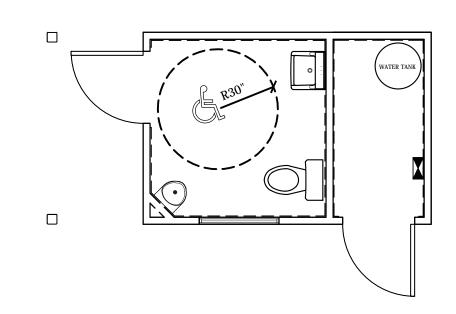
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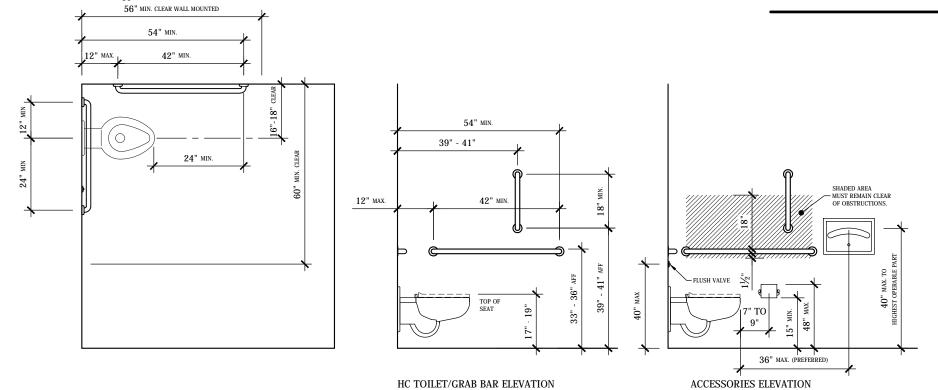






TURNING
RADIUS

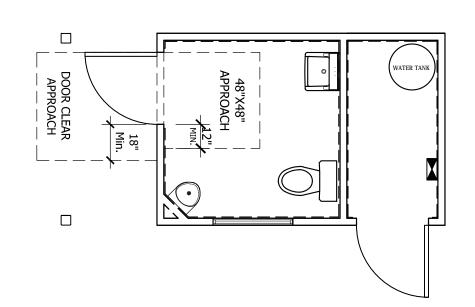COLORADO ACCESSIBILITY STANDARDS

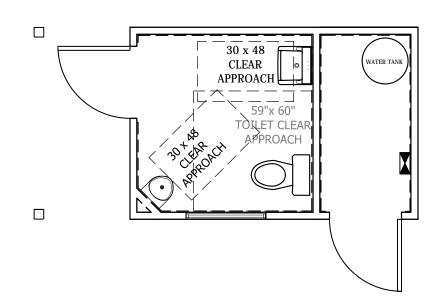


	CODE SUMMARY HEIGHT AFF/LOC	GREEN FLUSH TECHNOLOGIES STANDARDS
GRAB BARS	33" MIN. / 36" MAX. TO TOP	34" AFF. TO CENTER
CENTER OF TOILET FROM WALL	16" MIN. / 18" MAX.	17 1/2" TO CENTER
TOILET/SEAT	17" MIN. / 19" MAX.	18" TO TOP OF SEAT
TOILET FLUSH VALVE	44" MAX., MOUNTED ON OPEN SIDE	CENTERLINES TO BE 28" AFF AND 10" FROM CENTER OF WC
TP DISPENSER	BOTTOM TO BE 15" MIN. AFF TOP TO BE 48" MAX. AFF CENTER OF FURTHEST ROLL TO BE 7" TO 9" FROM FRONT OF WC.	8" NOM. IN FRONT OF TOILET TO CENTERLINE OF FRONT ROLL AND 30" TO TOP

NOTE: SPACE BETWEEN GRAB BAR AND WALL TO BE 1 1/2" CLEAR.
GRAB BAR DIAMETER TO BE 1 1/4" to 1 1/2".
GRAB BAR MUST BE ABLE TO SUPPORT 250 lb POINT LOAD AND NOT ROTATE WITHIN THE FITTINGS.


1-TOILET DESIGN CRITERIA: ICC / ANSI A117.1 - 2009

(SHOWING MINIMUMS & MAXIMUMS)

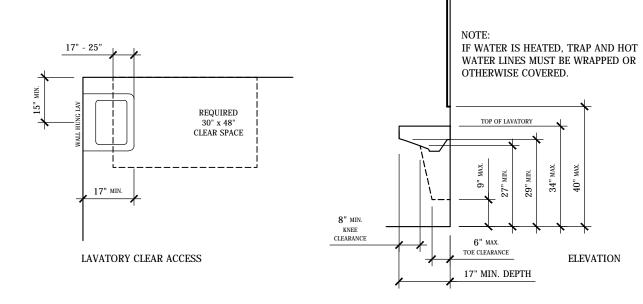


	CODE SUMMARY HEIGHT AFF/LOC	GREEN FLUSH TECHNOLOGIES STANDARDS
RIM HEIGHT (TOP OF LAV)	34" MAX	33" PREFERRED BUT MUST HAVE MIN. 29" KNEE SPACE
HEIGHT OF KNEE SPACE	29" MIN. AT FRONT APRON 27" MIN. AT 8" IN FROM FRONT	PER CODE
FRONT LAV TO TRAP	8" MIN	PER CODE
TOE SPACE UNDER TRAP	9" MIN	PER CODE
CONTROLS	DECK MT AT 34" MAX	33" PREFFERED
CLEAR SPACE	30" x 48"	PER CODE

2-LAVATORY DESIGN CRITERIA: ICC / ANSI A117.1 - 2009

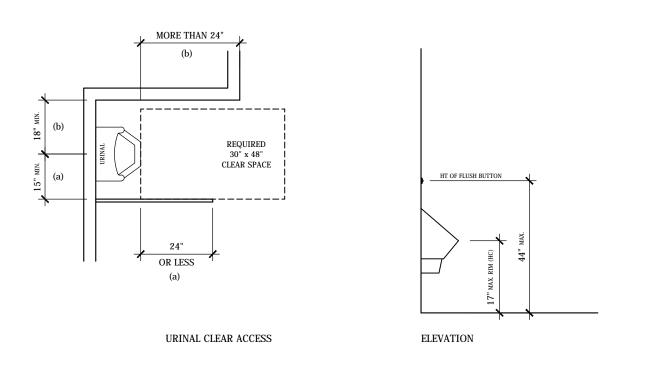

	CODE SUMMARY	GREEN FLUSH TECHNOLOGIES STANDARDS		
URINAL RIM	14" MIN. / 17" MAX. AFF.	16" AFF		
CONTROLS	44" MAX. AFF.	10" NOM. ABOVE TOP OF URINAL		
URINAL SCREENS (a)	15" MIN. CLEARANCE FROM CENTERLINE OF URINAL TO WALL OR PARTITION PROJECTING OUT 24" OR LESS FROM THE FRONT EDGE OF THE 30" x 48" CLEAR SPACE.	PER CODE		
(b)	18" MIN. CLEARANCE FROM CENTERLINE OF URINAL TO WALL OR PARTITION PROJECTING OUT MORE THAN 24" FROM THE FRONT EDGE OF THE 30" x 48" CLEAR SPACE.			


3-URINAL DESIGN CRITERIA: ICC / ANSI A117.1 - 2009

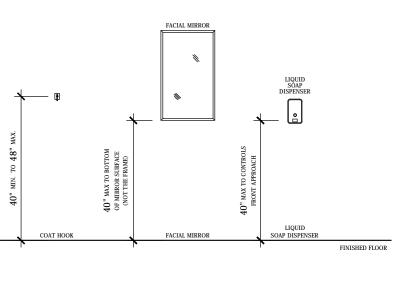

NOTES:

 NO FIXTURES IN THIS VIEW PROTRUDE MORE THAN 4"
 ALL ACCESSIBLE FIXTURES/ACCESSORIES SHALL BE MOUNTED W/ CODE COMPLIANT FORWARD AND/OR SIDE REACH RANGES

5-ACCESSORIES MOUNTING HEIGHT: ICC / ANSI A117.1 - 2009

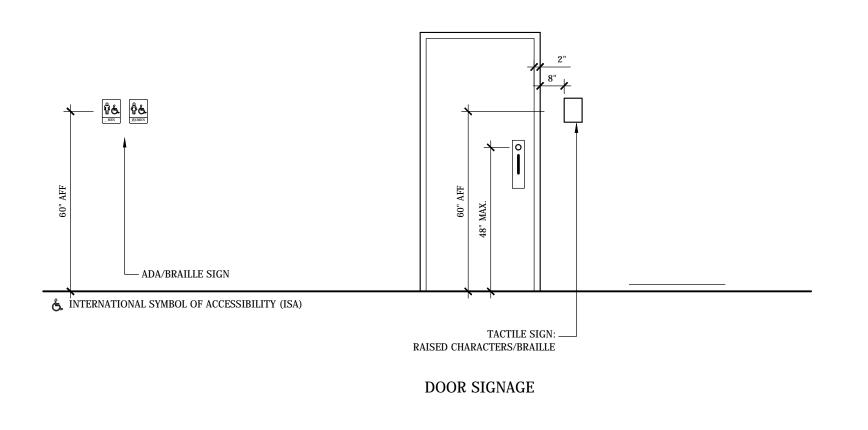

6-RESTROOM SIGNS AT DOORS & GATES: ICC / ANSI A117.1 - 2009


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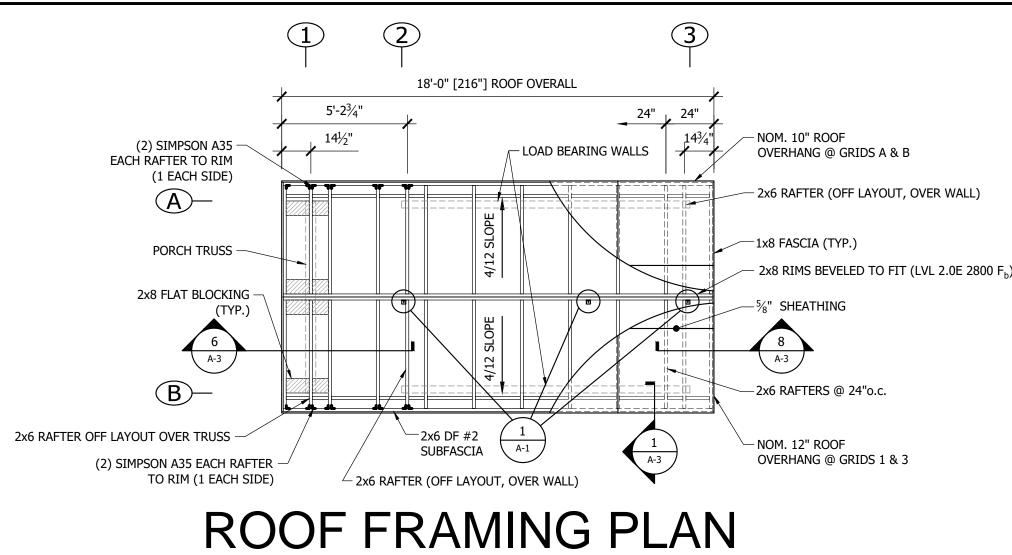
4-NOT USED

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PROJECT NAME & LOCATION:
Haymaker Golf Course
Colorado

ACCESSIBILITY



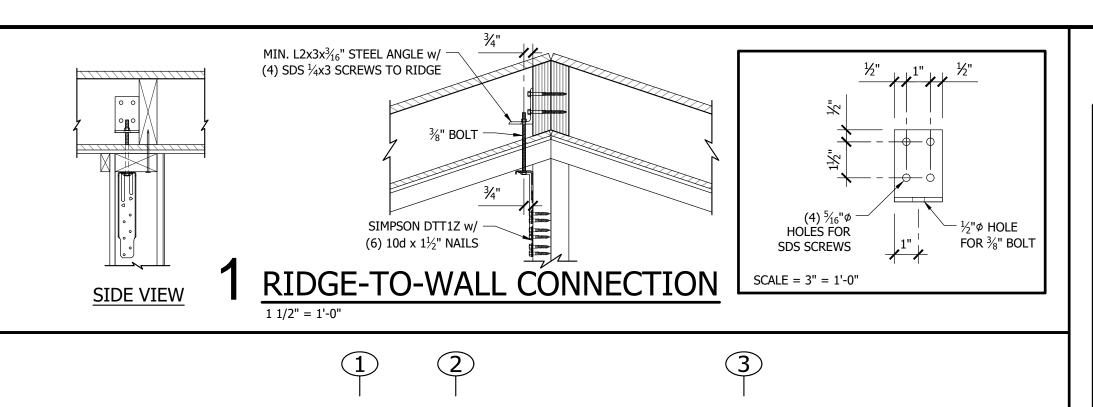

	DOOR, FRAME & HARDWARE SCHEDULE ~ALL DOORS OPERABLE~										
DOOR NO.	ROOM NAME	QTY	SIZE	1 & 2 TYPE	3 HINGE	4 LOCK	5a CLOSER	5b THRESH	5c SWEEP	^{5d} FINISH	6 NOTES
1	RESTROOM	1	3' x 6'-8"	НМ	BUTT	ND73PD	YES	NO	NO	PAINT	6a,b,c
2	MECH.	1	3' x 6'-8"	НМ	BUTT	B660R	DOOR CHAIN	NO	NO	PAINT	6a,b
3	WINDOW	1	40" x 18"	MILGARD - FIXED - DUAL GLAZING - VINYL FINISH - OBSCURE GLASS							

NO.	NAME	QTY	SIZE	TYPE	HINGE	LOCK	CLOSER	THRESH	SWEEP	FINISH	NOTES	
1	RESTROOM	1	3' x 6'-8"	НМ	BUTT	ND73PD	YES	NO	NO	PAINT	6a,b,c	
2	МЕСН.	1	3' x 6'-8"	НМ	BUTT	B660R	DOOR CHAIN	NO	NO	PAINT	6a,b	
3	WINDOW	1	40" x 18"	MILGARD - FIXED - DUAL GLAZING - VINYL FINISH - OBSCURE GLASS								
NOTE	<u>:S:</u>											
1. DC	OOR TYPES:									\neg		

NOTES:		
 DOOR TYPES: a) HM: GALVANIZED HOLLOW METAL, 18 ga. DOOR w/ 16 ga. FRAME. 		
3. HINGE SPECS: a) SS-BBH NRP	-	
4. LOCKS: a) DEADBOLT: SCHLAGE B SERIES w/ TEMPORARY CORE	RESTROOM	MECH (2)

FOUNDATION / FLOOR DECK:			
CONCRETE SLAB			#1
PERIMETER FRAMEWORK	STRUCTURAL STEEL	L6x6x5/16 (ASTM A36)	
REINFORCEMENT	REBAR MAT DESIGN	#4 MIN. ASTM GRADE 60	
CONCRETE (STANDARD WEIGHT)	8" MAT DESIGN	CUSTOM 4000 psi. (DESIGN BASIS IS 2500 psi.)	
WALLS:			
FRAMING (EXT):			
FULL HEIGHT	2x4 WOOD	2x4 DF STUDS @ 16"oc.; 2x4 PT BOTTOM PLATE	PG A-2
INSULATION	BATT	R-13 FIBERGLASS BATT	
SIDING USED AS STRUCTURAL SHEATHING	7/16" RATED SIDING	7/16" LP SMART PANEL T1-11 w/ GROOVES @ 8"oc.	
FRAMING (INT):			
FULL HEIGHT	2x4 WOOD	2x4 DF STUDS @ 16"oc.; 2x4 PT BOTTOM PLATE	
COLUMN & TRUSS	STEEL	HSS5x5x1/8" (ASTM A500 Grade B)	
ROOF:			
RAFTERS	2x6 WOOD RAFTERS	2x6 DF #2 RAFTERS @ 24" oc.	
SHEATHING (TOP OF RAFTERS)	5/8" CDX PLYWOOD	19/32 APA RATED (40/20)	
INSULATION	BATT	FIBERGLASS BATT (R-15)	
SHEATHING (BOTTOM OF RAFTER)	7/16" OSB	7/16 APA RATED (24/16)	#2
FASCIA	FINGER JOINTED CEDAR	1 x 8	

STRUCTURAL DESIGN

~SEE SHEETS A-2 & A-3 FOR INTERIOR AND EXTERIOR FINISHES~


SPECIFIC MATERIAL LIST

NOTES


GENERIC DESCRIPTION

NOTES:
1. COAT WITH WATER RESISTANT COATING.
2. SEE INTERIOR FINISH SCHEDULE FOR FINISHED CEILING CALLOUT.

COMPONENT

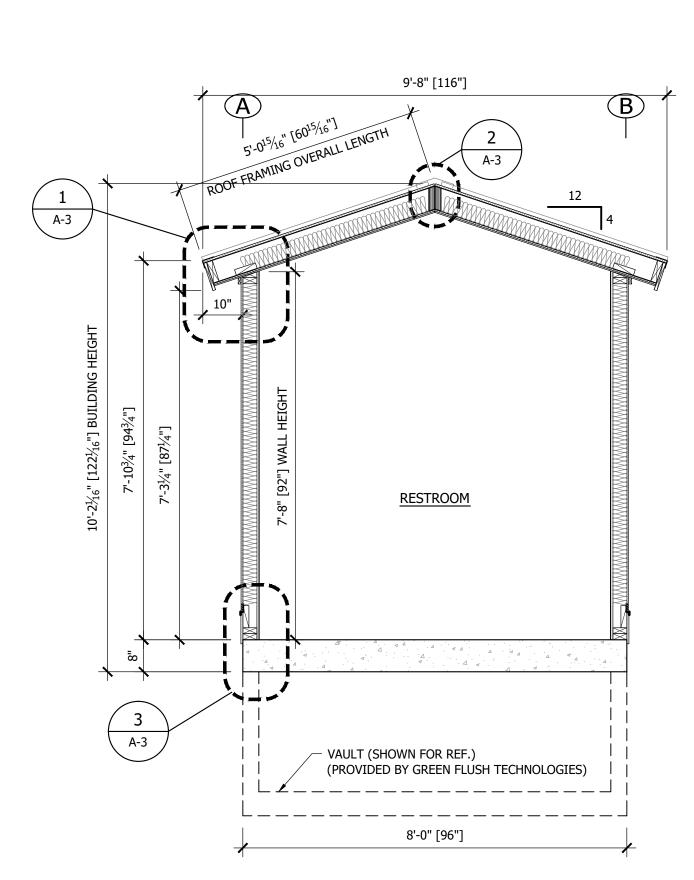



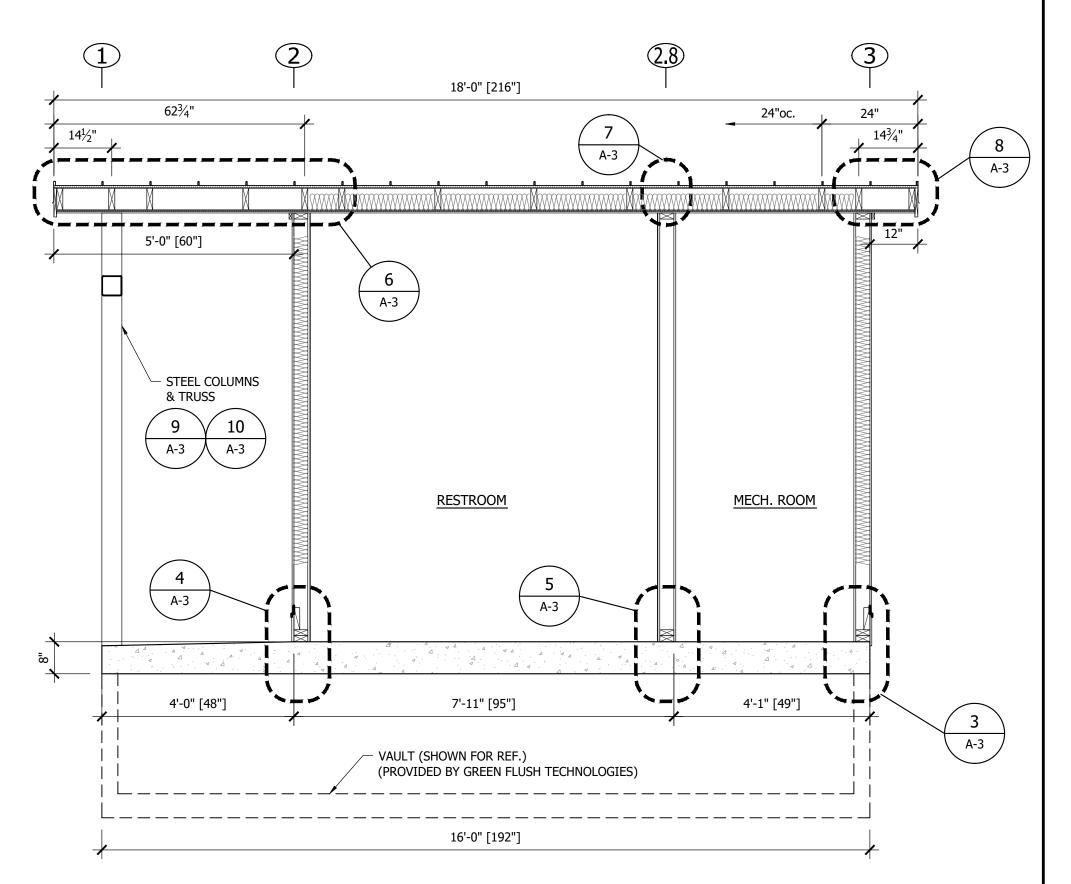

6. OTHER:

5. HARDWARE SPECS: a) CLOSERS 1) LCN 4040XP

2) DOOR CHAIN

d) FINISH: TEXTURED PAINT

c) KICK PLATE ON PUSH SIDE OF DOOR.


b) THRESH: - NONE

c) SWEEP: - NONE

a) WEATHERSTRIP b) PUSH PULL PLATE

1) B660R - KEY ONE SIDE, ADA TURN LEVER LOCKS AND UNLOCKS.



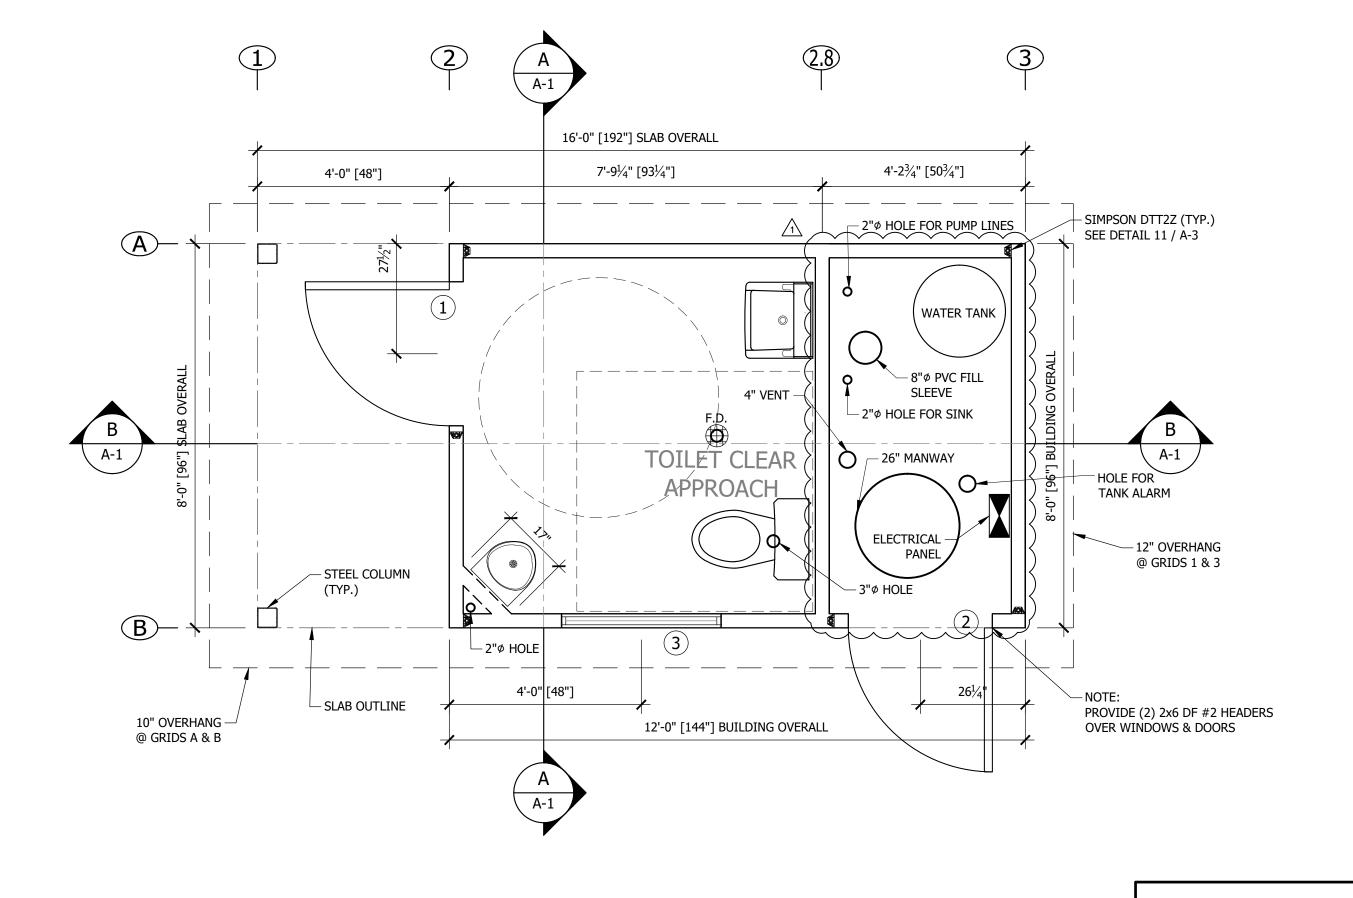

FLOOR PLAN

Sealed 3/29/2017 Patrick M. McGuire, PE

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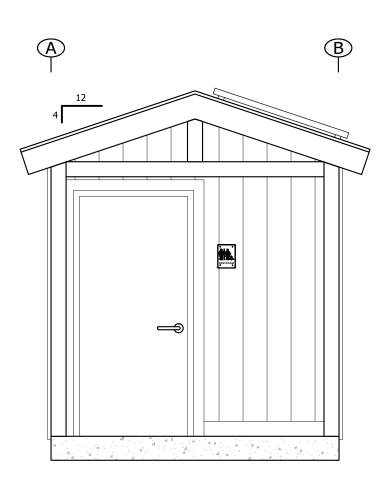
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PROJECT NAME & LOCATION: Haymaker Golf Course Colorado


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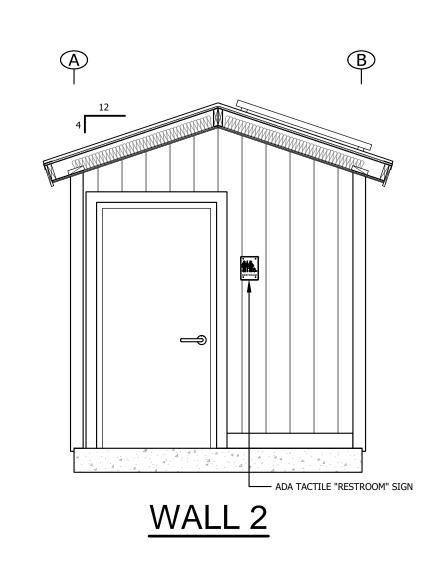
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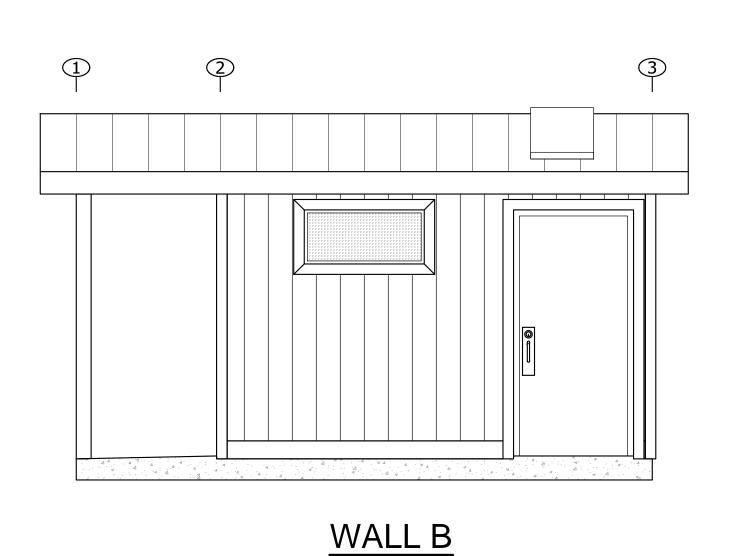
EXTERIOR FINISH SCHEDULE						
	DESCRIPTION	NOTES				
WALLS						
FULL HEIGHT	LP SMART PANEL T1-11 w/ GROOVES @ 8"oc.	1 COAT PRIMER ONLY				
STEEL TRUSS & POSTS	STEEL	1 COAT PRIMER, 2 COATS FINISH				
ROOF						
ROOFING	26 ga. STANDING SEAM METAL	OVER SINGLE LAYER MS-HT UNDERLAYMENT				
SOFFITS	JAMES HARDIE (OR EQUAL) - FRC (PERFORATED @ EAVES)	1 COAT PRIMER, 2 COATS FINISH				
FASCIA	1x8 FINGER JOINTED CEDAR	1 COAT PRIMER ONLY				
DOORS						
ALL DOORS AND FRAMES	GALVANIZED HOLLOW METAL	1 COAT PRIMER, 2 COATS FINISH				




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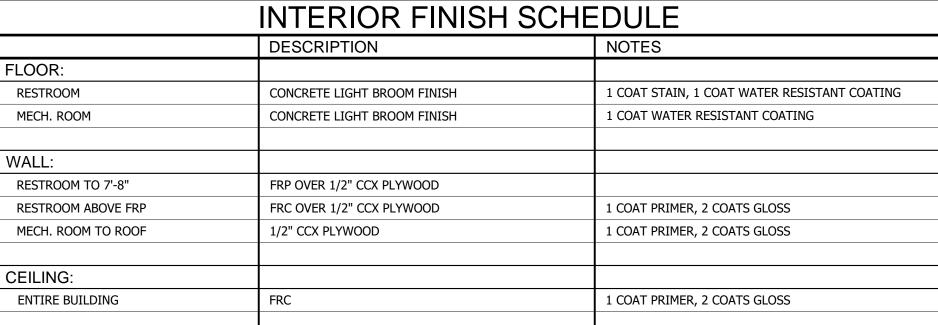







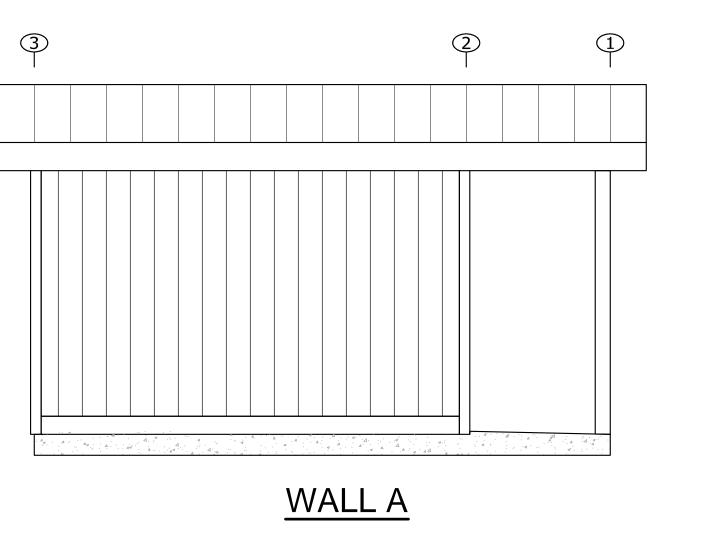

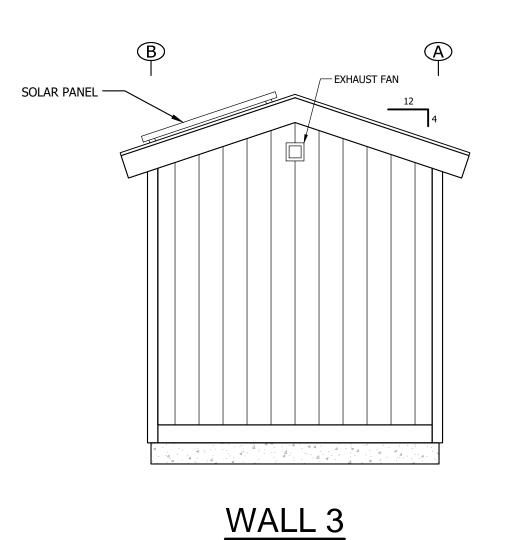INTERIOR FINISH SCHEDULE						
	DESCRIPTION	NOTES				
FLOOR:						
RESTROOM	CONCRETE LIGHT BROOM FINISH	1 COAT STAIN, 1 COAT WATER RESISTANT COATING				
MECH. ROOM	CONCRETE LIGHT BROOM FINISH	1 COAT WATER RESISTANT COATING				
WALL:						
RESTROOM TO 7'-8"	FRP OVER 1/2" CCX PLYWOOD					
RESTROOM ABOVE FRP	FRC OVER 1/2" CCX PLYWOOD	1 COAT PRIMER, 2 COATS GLOSS				
MECH. ROOM TO ROOF	1/2" CCX PLYWOOD	1 COAT PRIMER, 2 COATS GLOSS				
CEILING:						
ENTIRE BUILDING	FRC	1 COAT PRIMER, 2 COATS GLOSS				



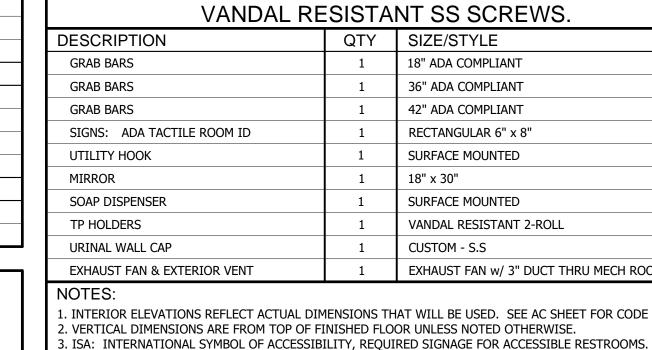

EXHAUST FAN w/ 3" DUCT THRU MECH ROOM 1. INTERIOR ELEVATIONS REFLECT ACTUAL DIMENSIONS THAT WILL BE USED. SEE AC SHEET FOR CODE CRITERIA. 2. VERTICAL DIMENSIONS ARE FROM TOP OF FINISHED FLOOR UNLESS NOTED OTHERWISE.

ACCESSORIES PROVIDE BLOCKING FOR ALL FIXTURES

AND ACCESSORIES AND MOUNT WITH

18" ADA COMPLIANT

36" ADA COMPLIANT

42" ADA COMPLIANT


RECTANGULAR 6" x 8" SURFACE MOUNTED

SURFACE MOUNTED


CUSTOM - S.S

VANDAL RESISTANT 2-ROLL


18" x 30"

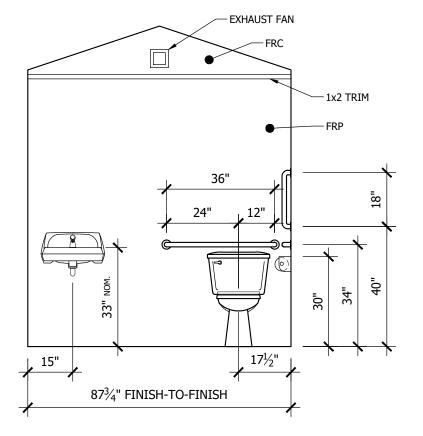




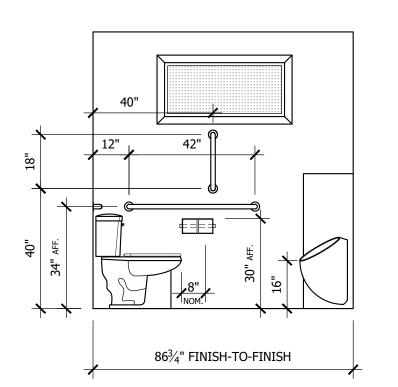



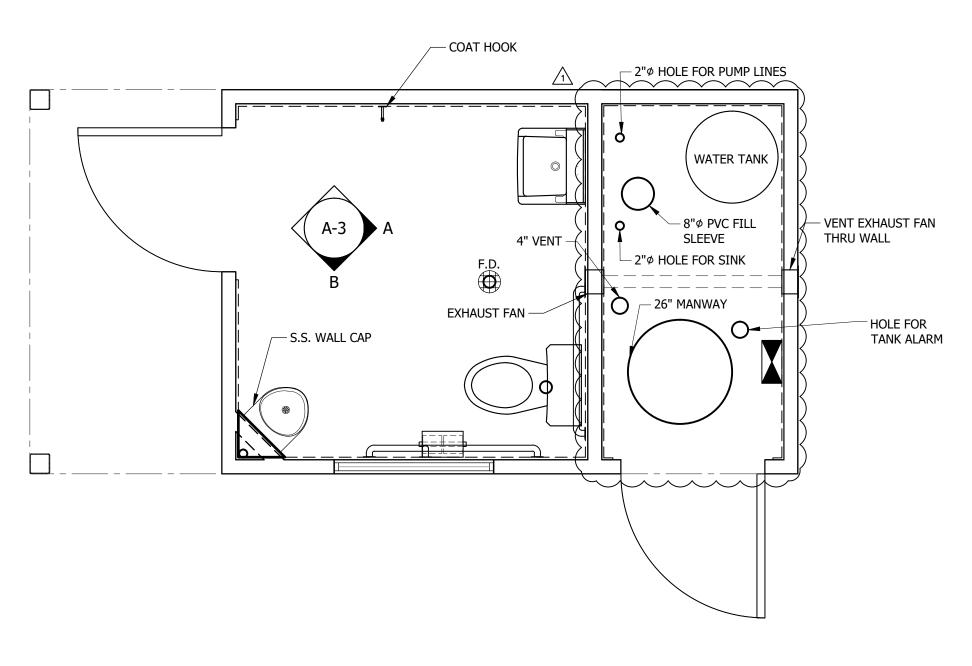

INTERIOR LAYOUT

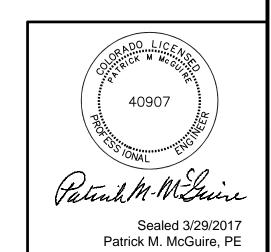


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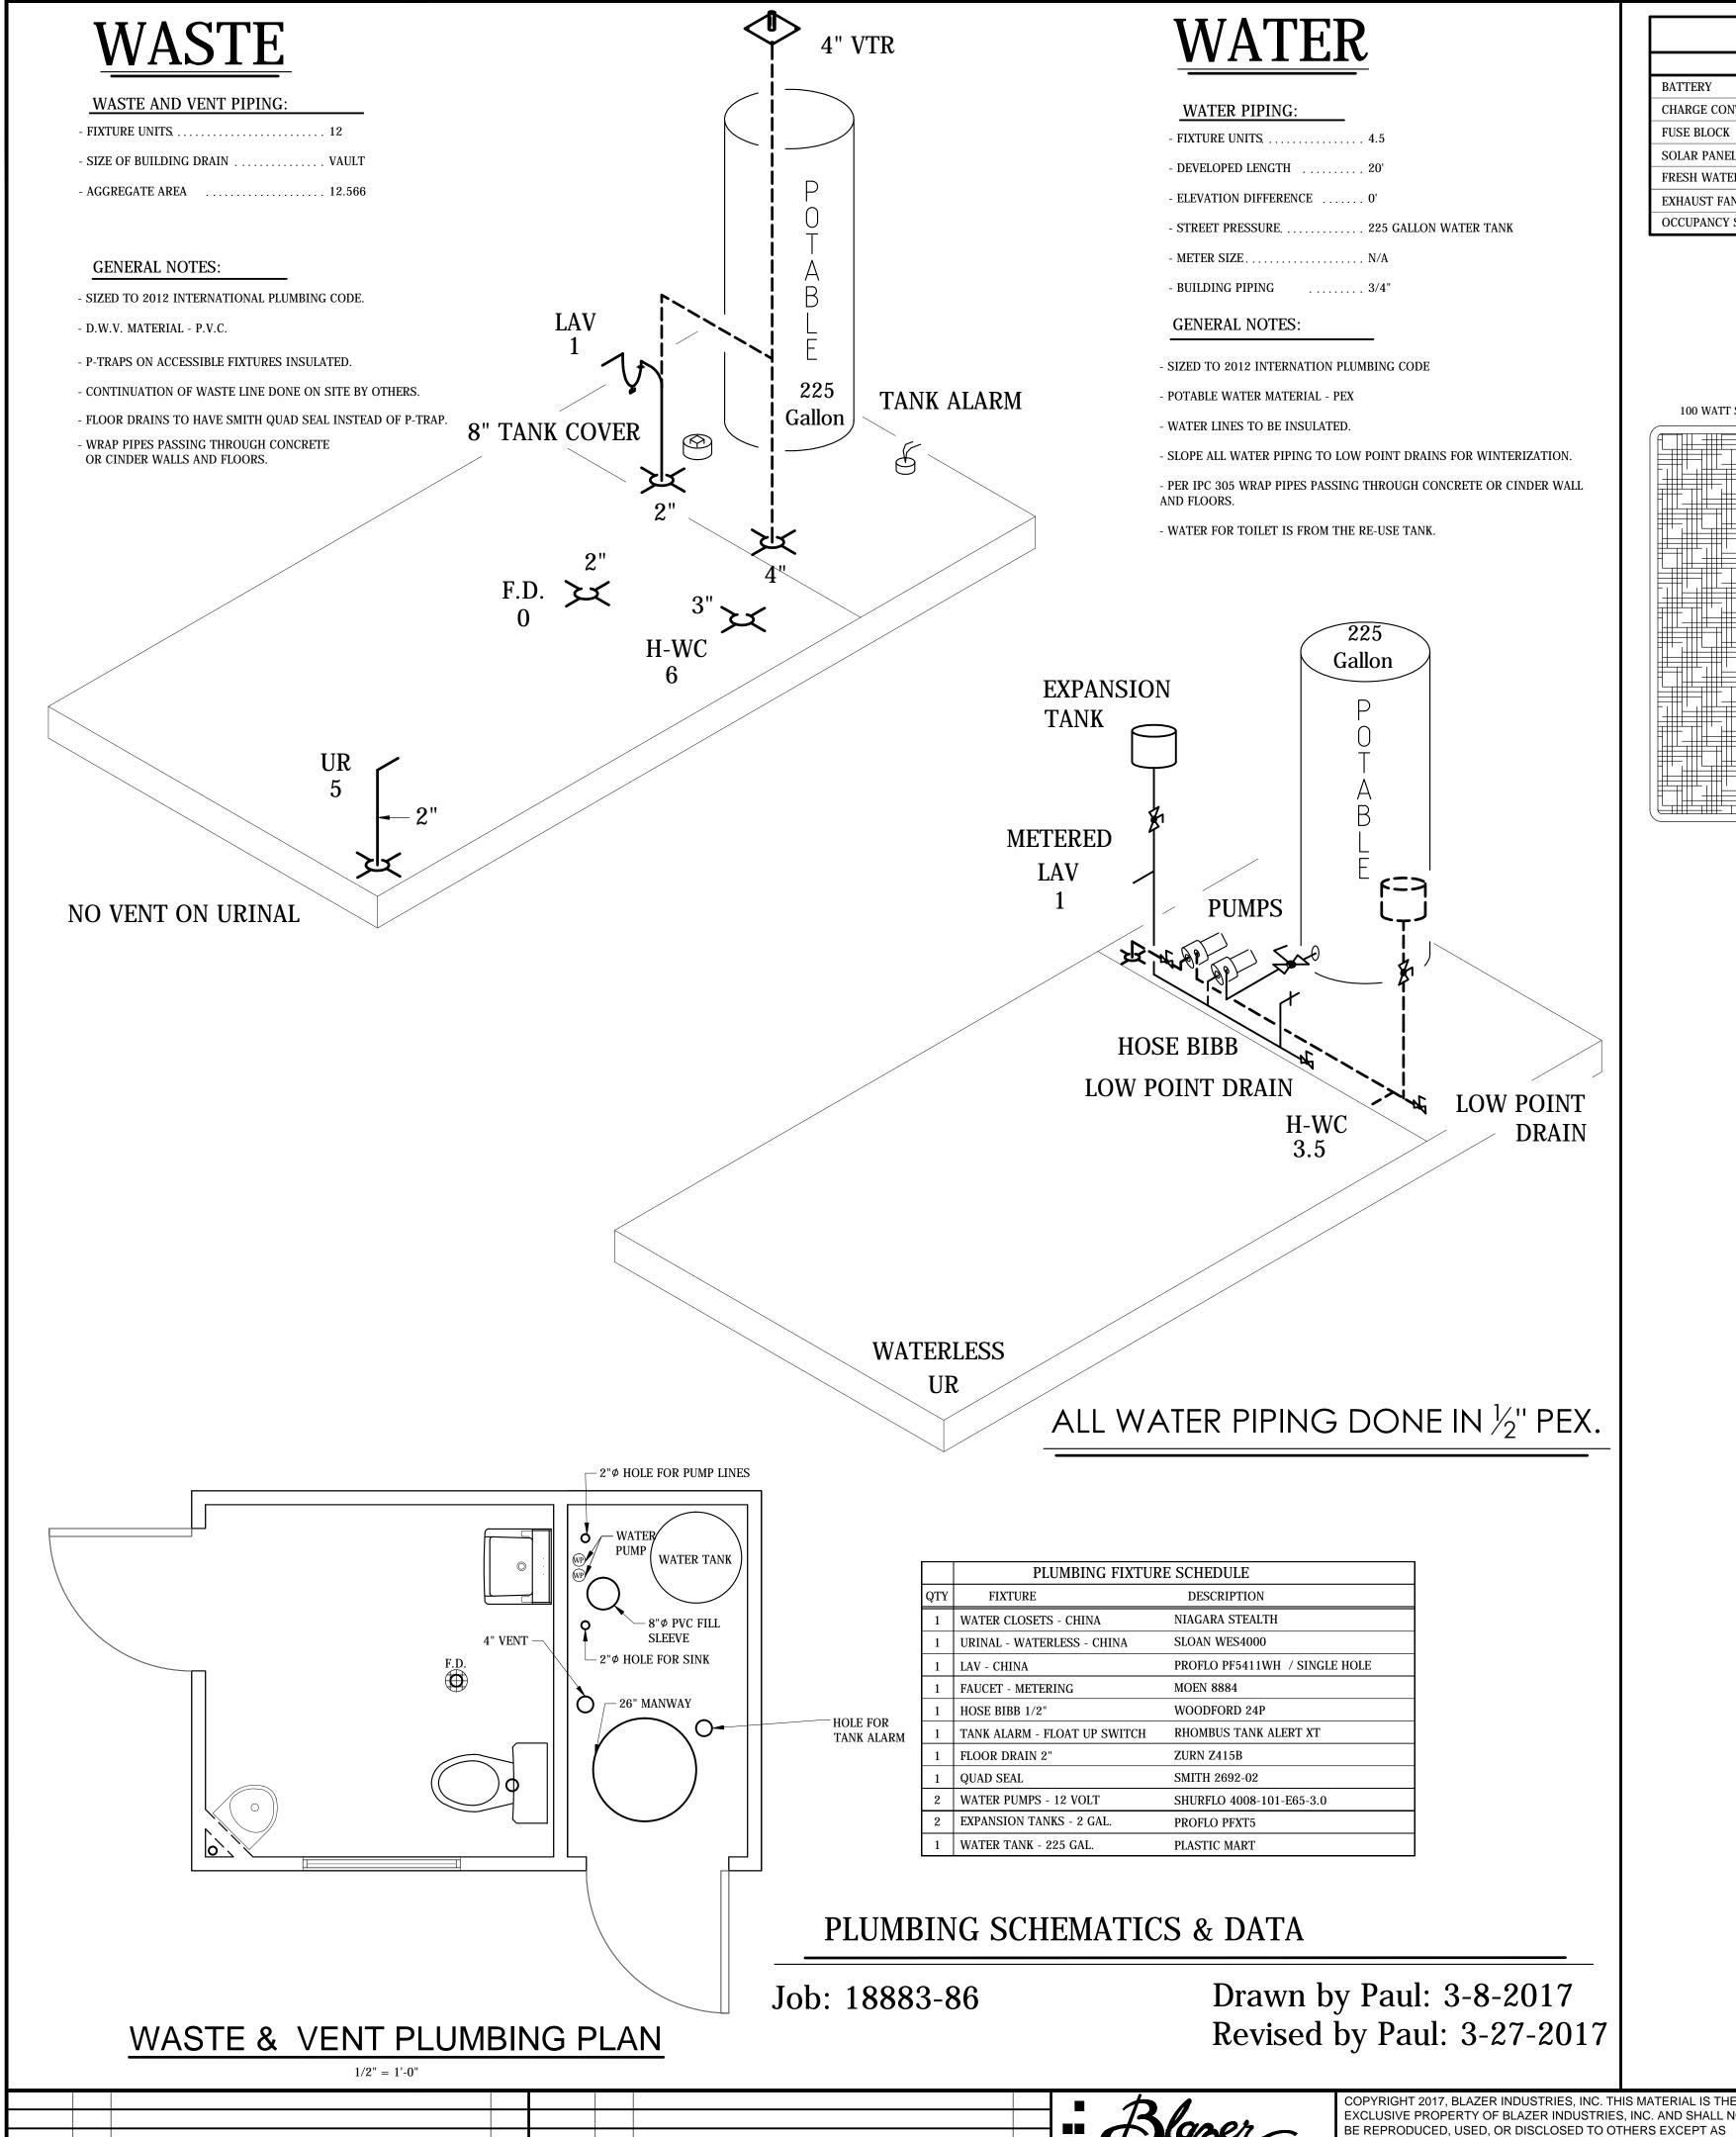
EXTERIOR ELEVATIONS



PROJECT NAME & LOCATION: Haymaker Golf Course Colorado

ELEVATIONS, FINISH SCHEDULES, ACCESSORIES Drawn By: Issue Date:



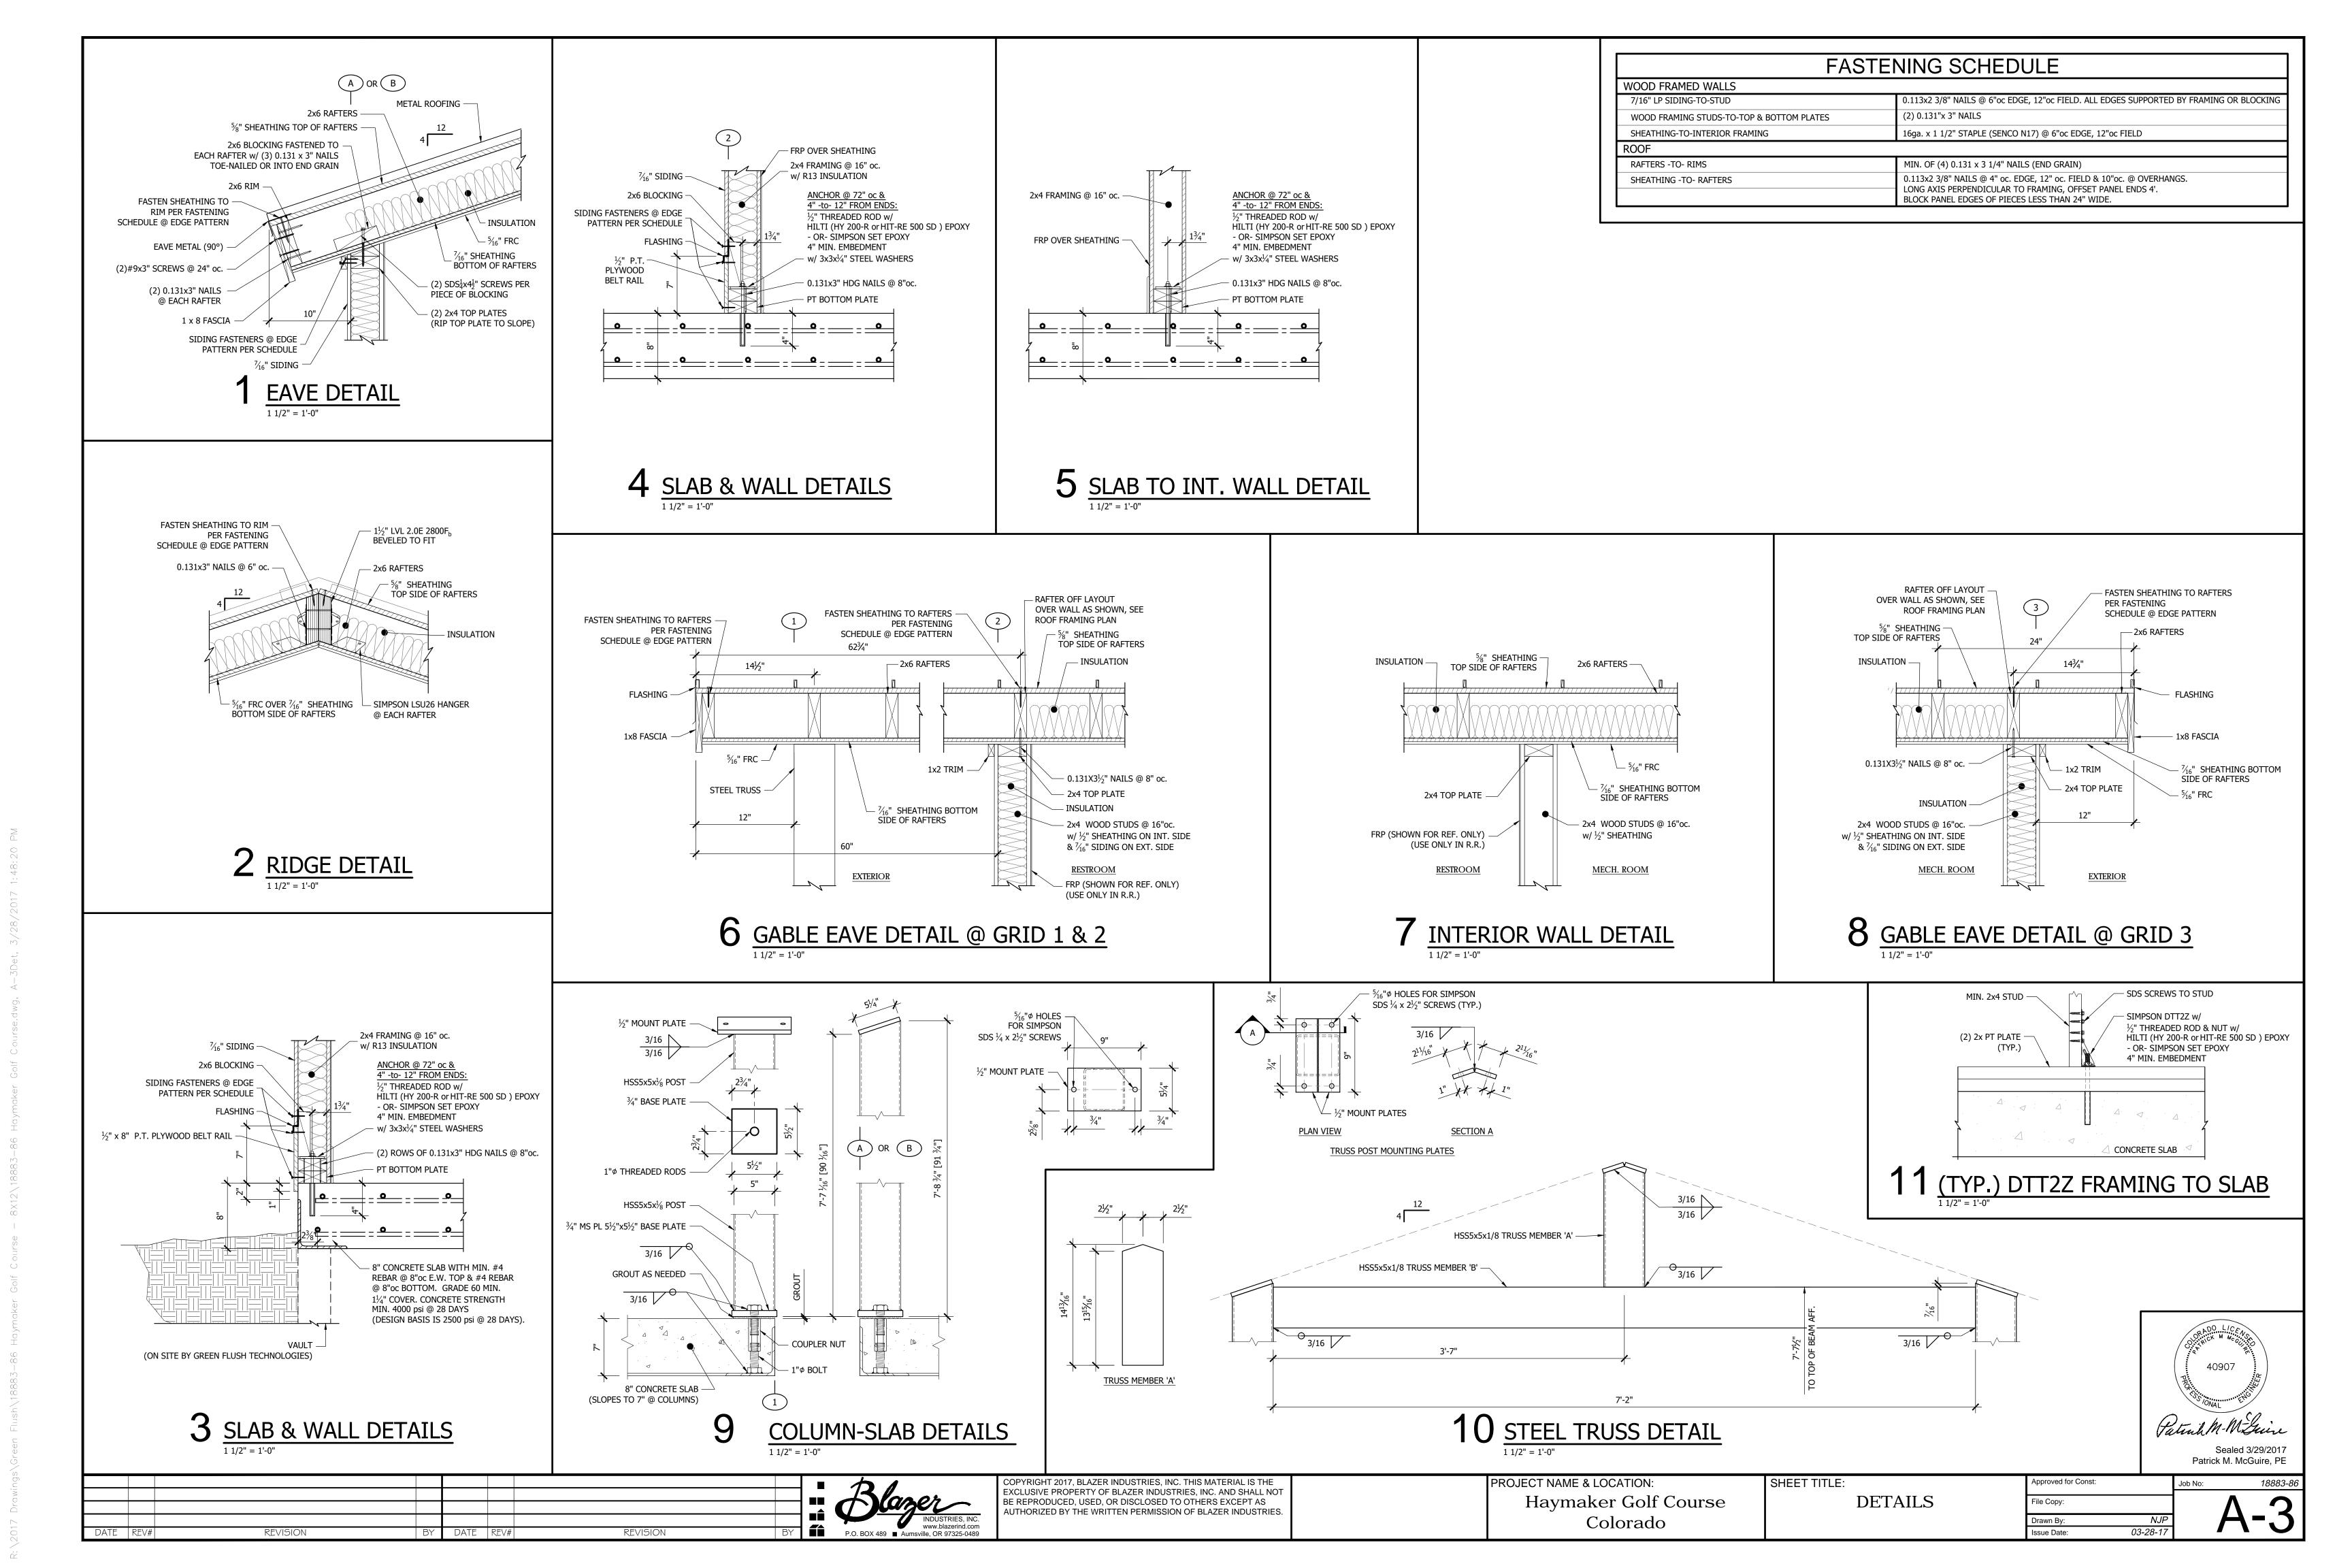



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DATE REV#

REVISION


ELECTRICAL FIXTURE/EQUIPMENT SCHEDULE & SYMBOLS									
	SYMBOL	QTY	DESCRIPTION	MODEL	HEIGHT TO TOP	COMMENTS			
BATTERY		1	100 AH 12 VOLT LEAD ACID BATTERY			LOCATE IN CUSTOM RACK AND BOX BELOW CONTROLLER			
CHARGE CONTROLLER		1	30 AMP SOLAR CHARGE CONTROLLER	MORNINGSTAR PS-30M	72"	ENCLOSED IN 12"x12" NEMA 1 JUNCTION BOX			
FUSE BLOCK		1	10 CIRCUIT FUSE BLOCK	ATC-10GANG					
SOLAR PANEL	[]	1	100 WATT MONOCRYSTALINE SOLAR PANEL	RENOGY RNG-100G	ON ROOF	FINAL LOCATION TO BE VERIFIED			
FRESH WATER PUMP		2	12 VOLT DC WATT FRESH WATER PUMP	SHURFLO 4008-101-E65-3.0					
EXHAUST FAN		1	EXHAUST FAN w/ EXTERIOR VENT	JABSCO 35115-7020	98" AFF	3" DUCT FROM RESTROOM TO EXT. WALL THRU MECH. ROOM			
OCCUPANCY SENSOR	ÓS	1	OCCUPANCY SENSOR	SENSOR SWITCH WV PDT 16	84" AFF	12 VOLT DC OPERATION - CORNER MOUNT			




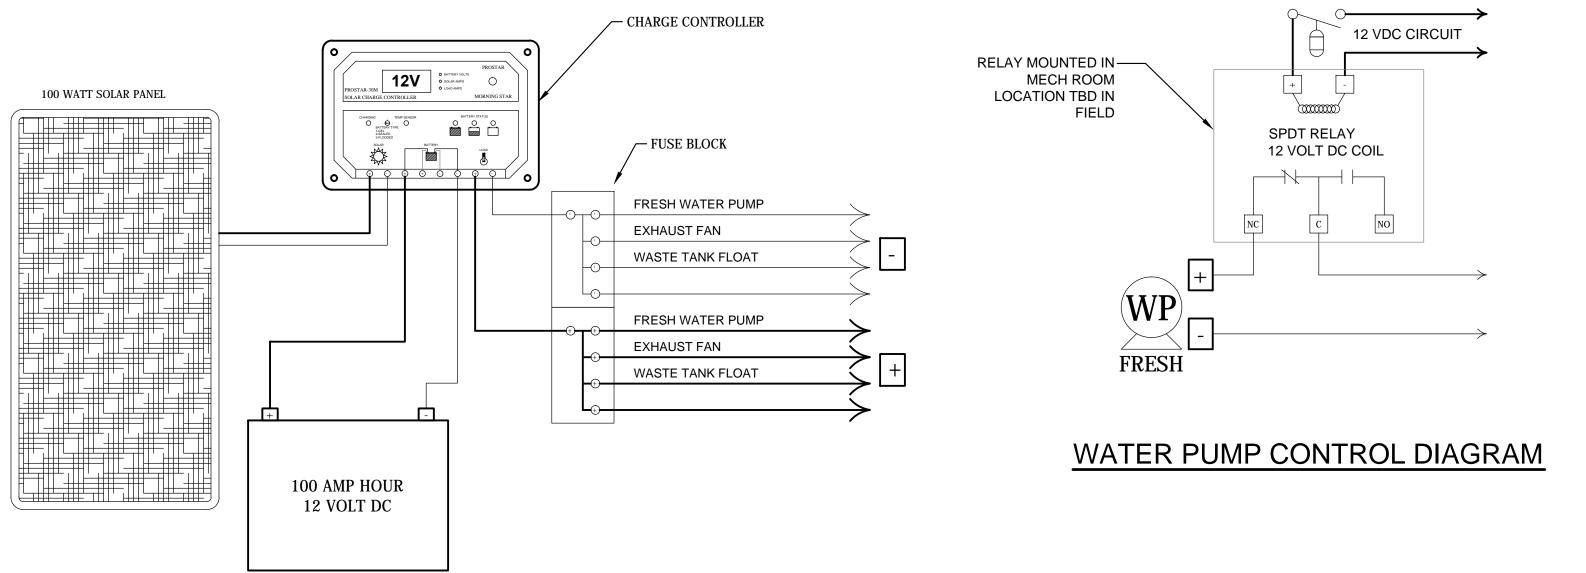


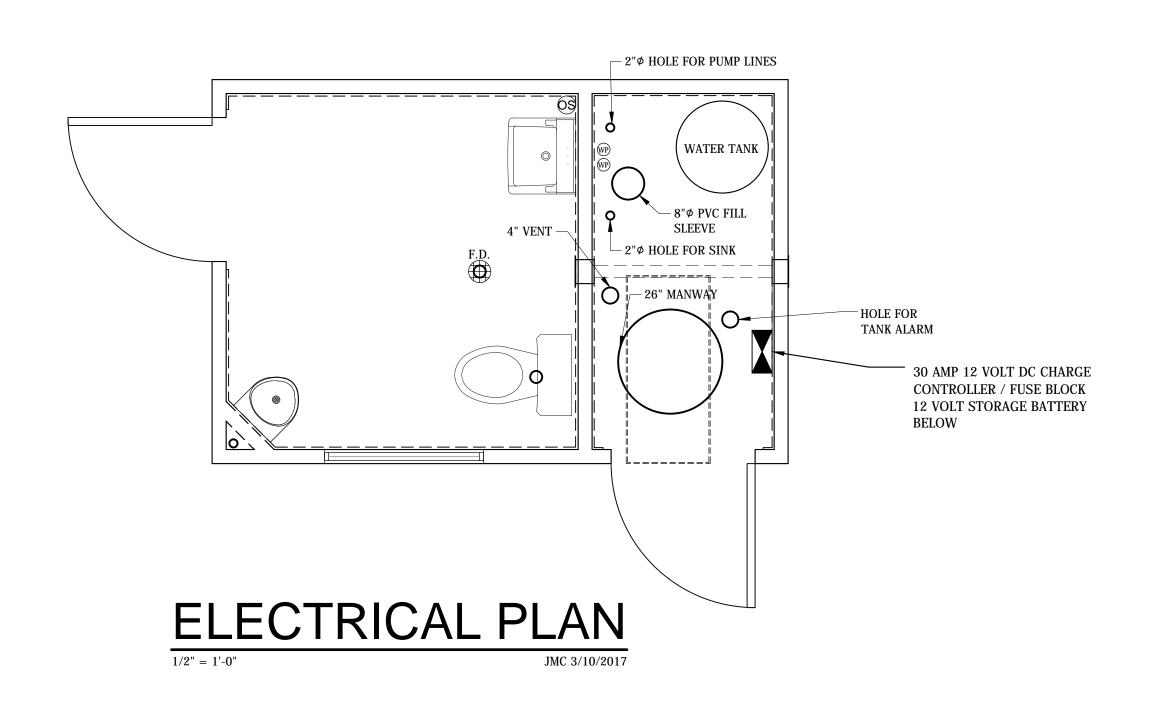
PROJECT NAME & LOCATION: Haymaker Golf Course Colorado

PLUMBING PLAN & INFORMATION

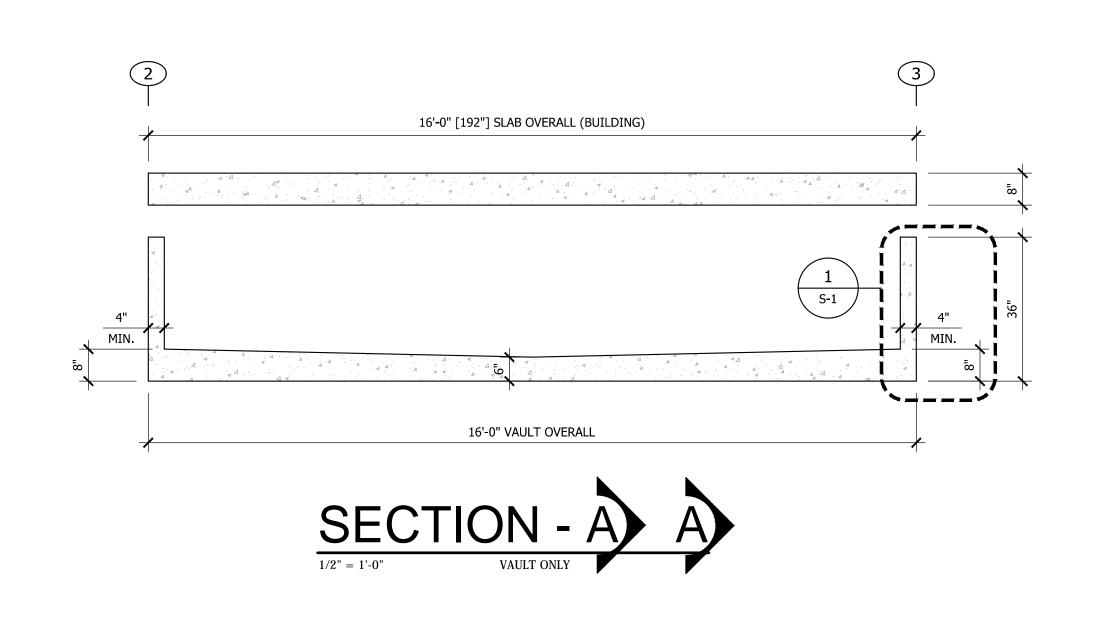

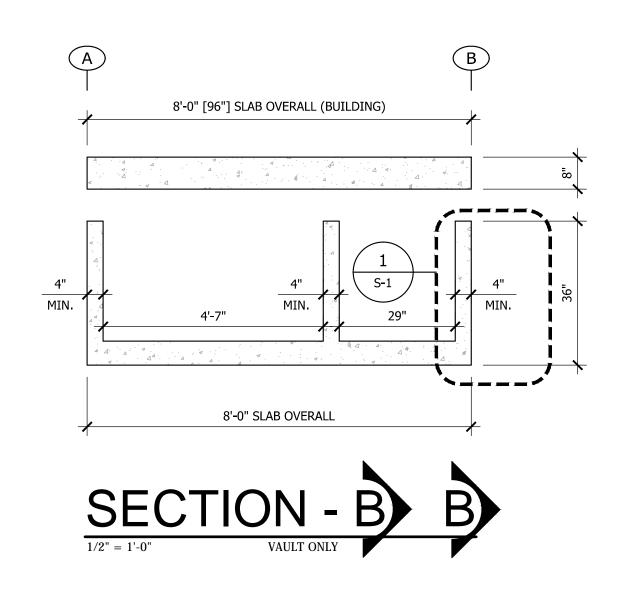

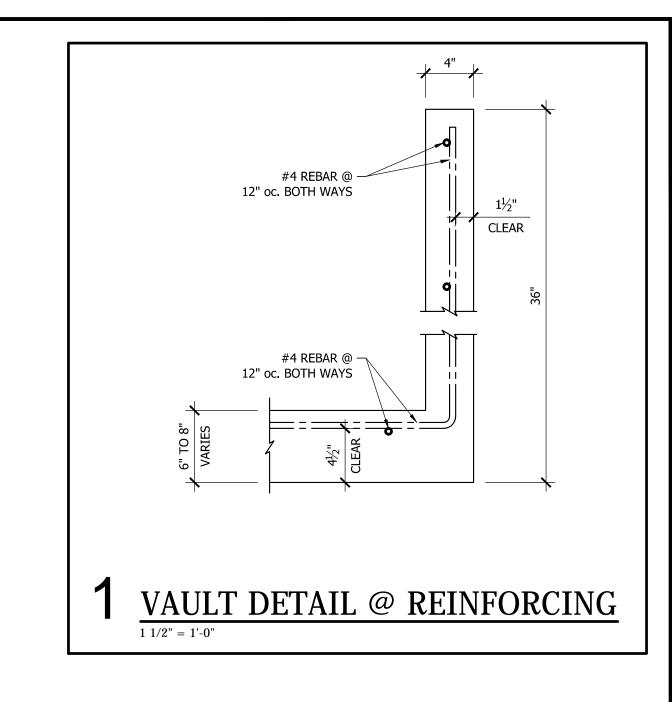

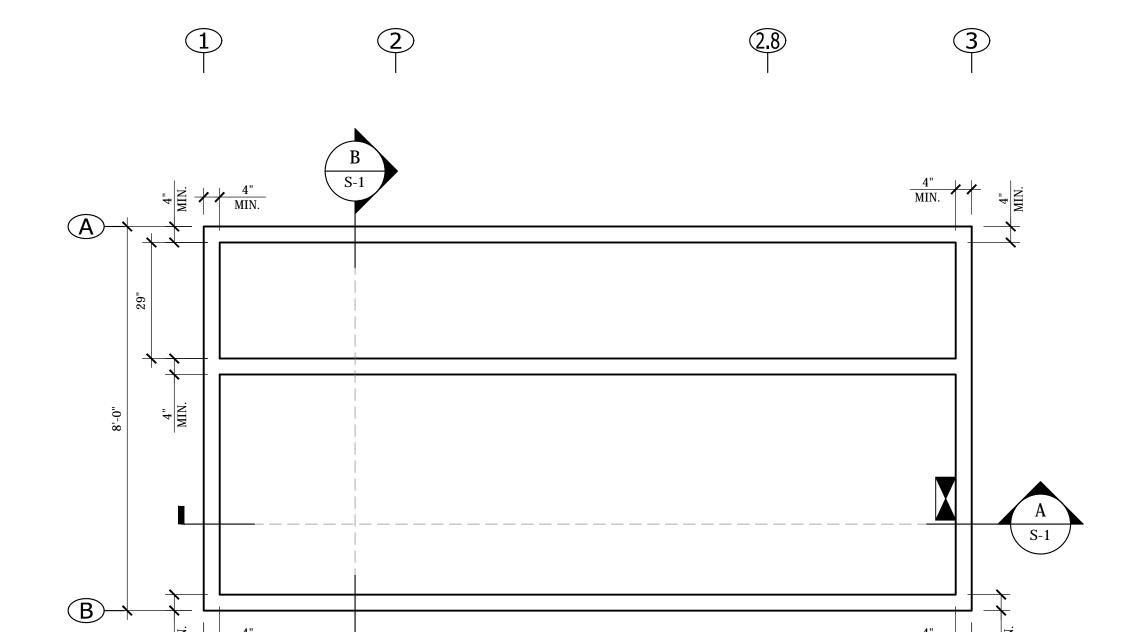

VAULT PLAN

1/2" = 1'-0"

16'-0"

Bayer INDUSTRIES, INC. www.blazerind.com

REVISION

DATE REV#

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PROJECT NAME & LOCATION:
Haymaker Golf Course
Colorado

SHEET TITLE:
VAULT PLAN

Gary K. Munkelt & Associates
Structural Consulting
Engineers
1180 Welsh Rd, Suite 190
North Wales, PA 19454

Ph: 215-855-8713 F: 215-855-8714


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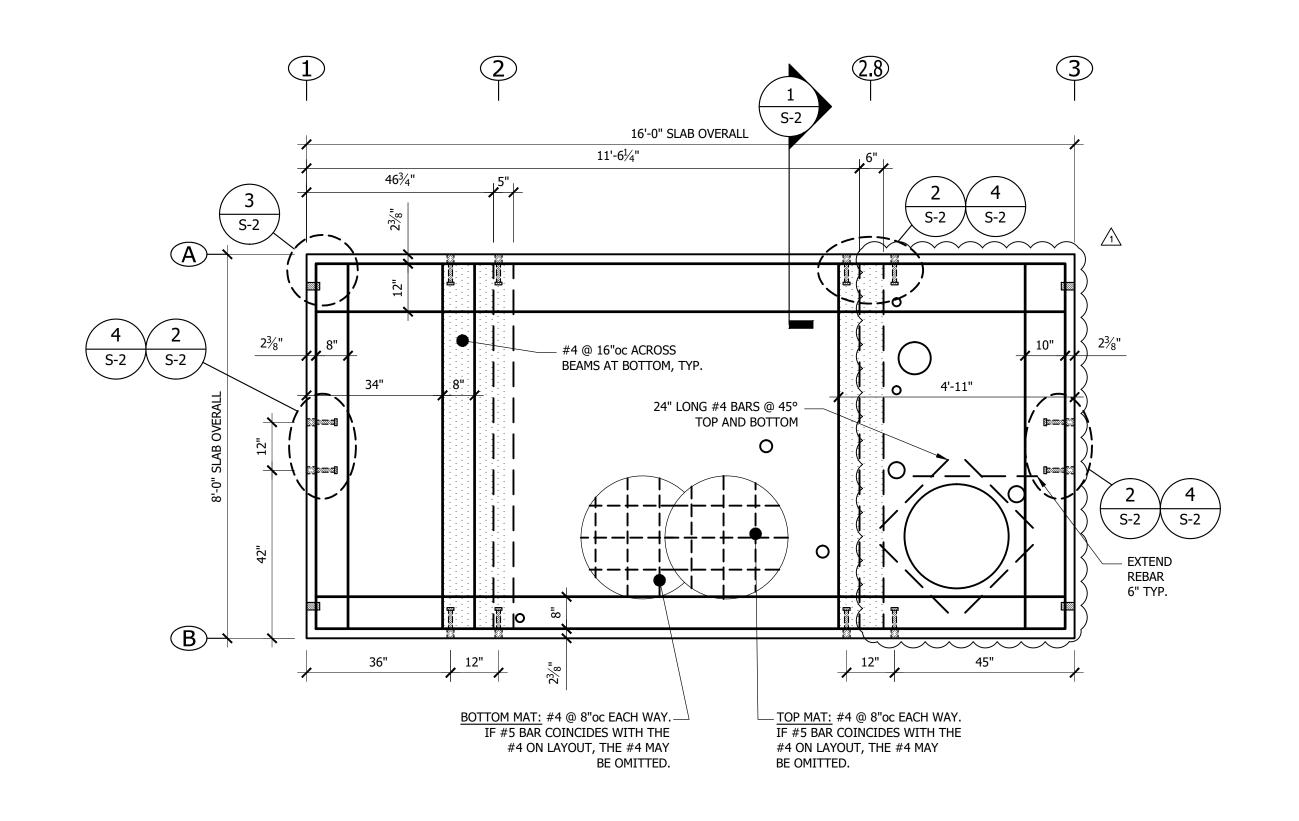
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Drawn By: NJP
Issue Date: 03-28-17


GENERAL NOTES:

1. DESIGN ASSUMES ONE STORY BUILDING ON TOP OF VAULT
2. CONCRETE $f_C = 4000$ psi
3. REINFORCING STEEL $f_V = 40000$ psi
4. VAULT WILL NOT BE MANUFACTURED BY BLAZER INDUSTRIES.




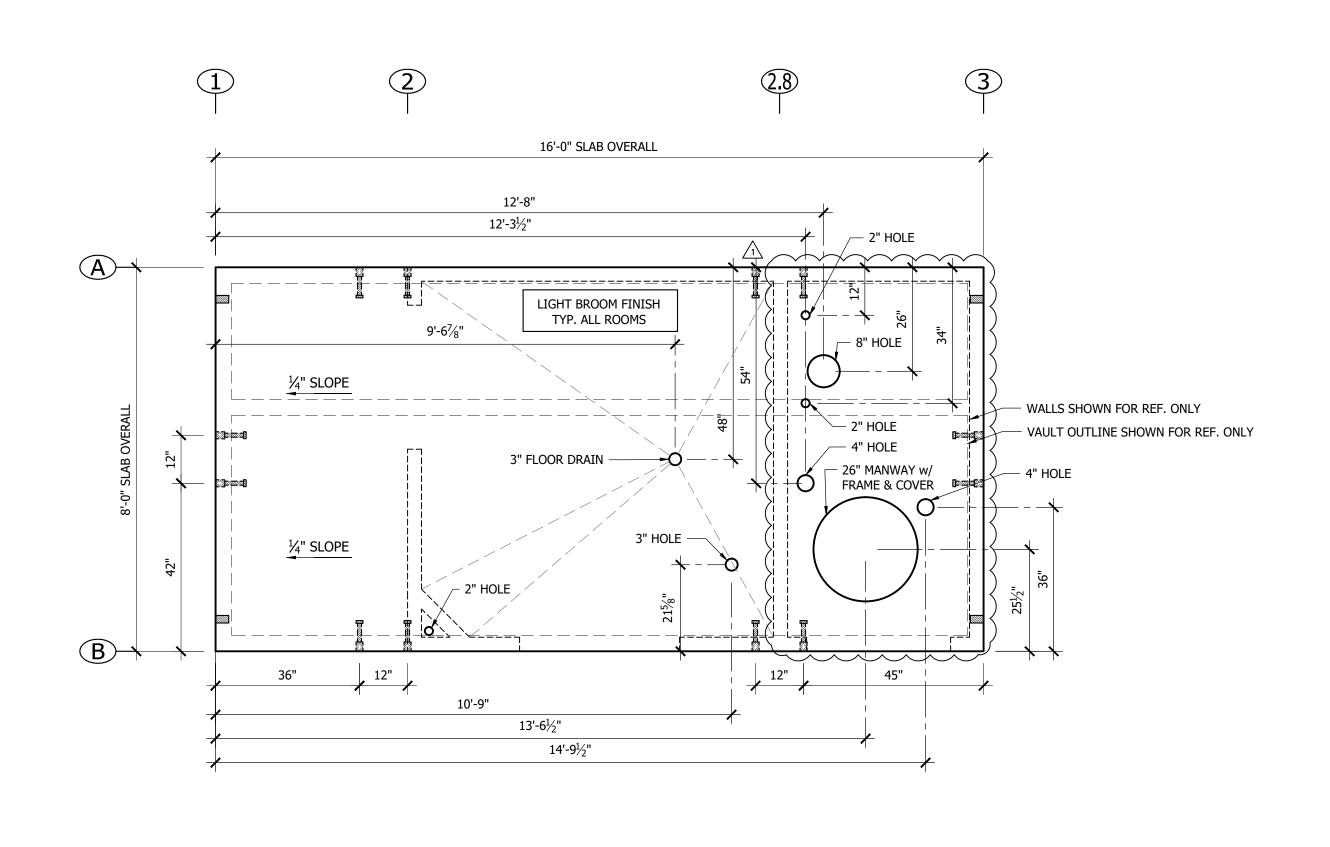

SLAB PLAN

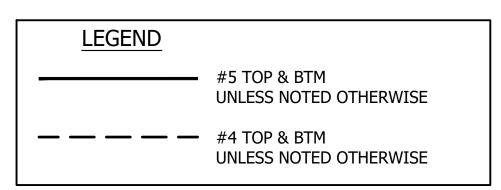


REBAR PLAN

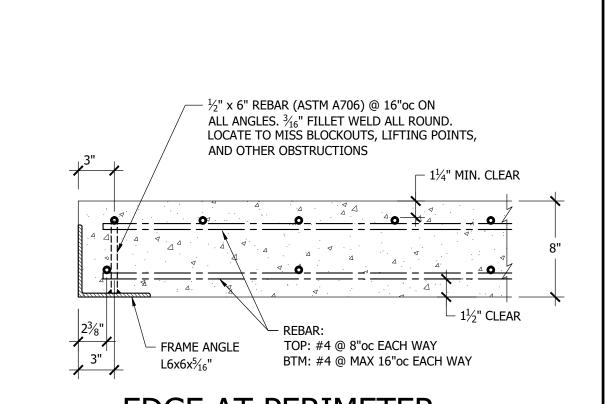

EDGE AT PERIMETER

STARTER BARS

1 1/2" = 1'-0" WHERE APPLICABLE (SIMILAR @ INTERIOR WALLS)

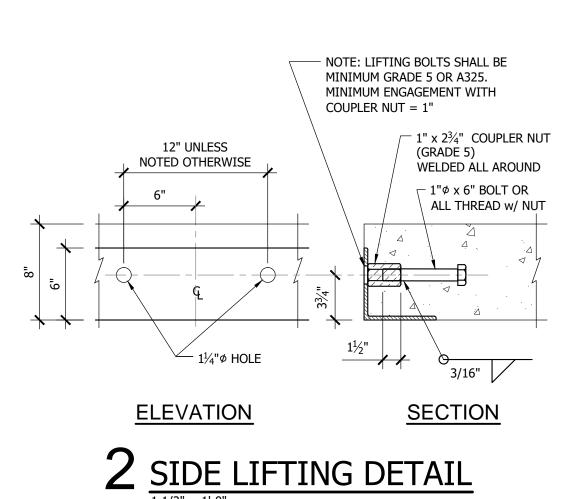

FRAME ANGLE L6x6x5/16"

HOLE IN ANGLE (SIZE TO ACCEPT COUPLER NUT)

SIDE


1" x 23/4" COUPLER NUT WELDED ALL AROUND

PLAN VIEW

SECTION

3 OUTSIDE CORNER
JIG SUPPORT DETAIL


1 1/2" = 1'-0"

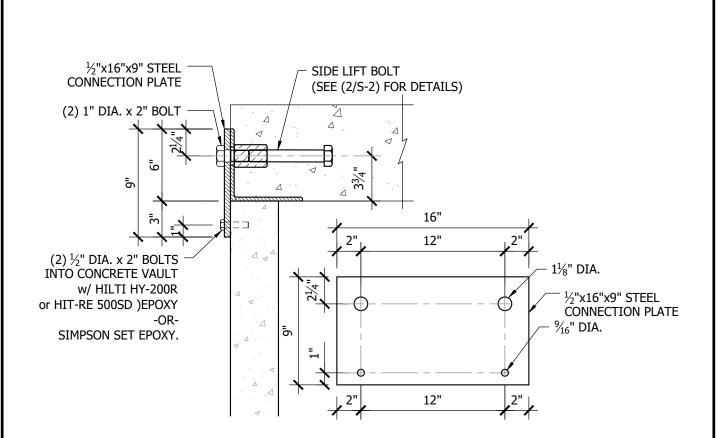

 $4_{\frac{11/2"=1'\cdot0"}{11/2"=1'\cdot0"}}$

NOTES: (STANDARD WEIGHT CONCRETE)

- 1. ALL REBAR TO BE GRADE 60.
- 2. CONCRETE STRENGTH TO BE 4000 PSI AT 28 DAYS.
- 3. MINIMUM CONCRETE COVER = 1 1/4" FOR #4 AND #5 BARS. PLACE REBAR AT HEIGHTS SHOWN ON DETAILS, EXCEPT TOP BARS MAY BE LOWER ONLY WHERE REQUIRED BY SPECIFIED SLOPES.
- 4. TOP MAT: ADD TRIMMER BARS NEXT TO BLOCK OUTS IF CLEARANCE TO REGULAR LAYOUT IS GREATER THAN 2". TRIMMER BARS EXTEND 18" PAST OPENING, OR TERMINATE WITH 90° HOOK AND 8" EXTENSION. CENTER OF TRIMMER BARS TO BLOCK OUTS TO BE 2", TYP.
- 5. SMALL BLOCK OUTS (8" x 8" MAX.) MAY BE ADDED AS REQUIRED FOR SERVICES. ADD TRIMMER BARS IF CLEARANCE TO REGULAR LAYOUT IS GREATER THAN 2".
- 6. SPLICES: #4 BARS 20" LAP #5 BARS - 24" LAP
- 7. PROTECT PIPE & FLOOR DRAINS THAT WILL BE ENCASED IN THE CONCRETE BY WRAPPING WITH AN APPROVED WRAP.
- 8. ONLY WHERE NOTED, IT IS ACCEPTABLE TO NOTCH HORIZONTAL LEG OF PERIMETER ANGLE.

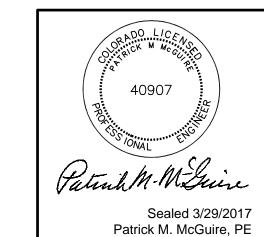

03-28-17



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PROJECT NAME & LOCATION:
Haymaker Golf Course
Colorado

SHEET TITLE:
REBAR PLAN

Approved for Const:

File Copy:

Drawn By:

S-2