

THE FOLLOWING PLANS ARE: CONSTRUCTION PLANS FOR

PLUS PUU - NATHAN & ALISON NICHOLAS

IN

STEAMBOAT SPRINGS, CO

* NOTE : * PLEASE PROVIDE NAME OF COUNTY WHERE BUILDING SITE IS LOCATED

					2 1/2" galv. roofing nails — ridge cap	- All exterior stud walls to be 16" o.c. unless noted otherwise	INDEX O	F DI ANG
					PORCH/DECK:	- All interior stud walls to be 16" o.c. unless noted otherwise		
			EVIATIONS & SYMBOLS		5/8" x 6" galv. bolt — ledger board to perimeter box connection	- All interior bearing walls to be 16" o.c. unless noted otherwise	DRAWING SHEET NAME	SHEET#
		COMMON ADDITE	LVIATIONS & STWIDOLS		3/8" x 12" galv. lags — heavy timber porch headers to post connections	— Standard 2x rafter/pre—fab truss spacing @ 16" o.c.	ELEVATIONS	1 OF 11
ABBREVIATION:	SYMBOL:	STANDS FOR:	STD.	Standard	3/8" x 5" galv. lags — double 2x header to post connections	- All pre-engineered structural components used in construction, including but not limited to; glu-lam beams, laminated veneer lumber, wood 'l' joists,	1st LEVEL FLOOR PLANS	2 OF 11
B.O. OR B/O		By Others/By Owner	T&G	Tongue & Groove	10" timber screws — porch post angle braces	rafters, trusses, etc, must be installed in full compliance with the manufacturer's installation requirements.	2nd LEVEL FLOOR PLANS	3 OF 11
B&P		Beam and Purlin	TYP.	Typical	3" deck screws — 2x6 decking	- Fireblocking to be installed to cut off all concealed draft openings & to form an effective fire barrier between stories, between a top	FOUNDATION PLAN	4 OF 11
CONC.		Concrete	U.N.O.	Unless Noted Otherwise	2" deck screws - 5/4 decking	story, roof space & for any continuous framing exceeding 10'-0".	FIRST FLOOR FRAMING PLAN	5 OF 11
CONT.		Continuous	W/	With	16d ardox nails — ACQ conventional framing	— Lag spacing for logs to be 30" o.c.	PORCH/DECK FRAMING PLAN	6 OF 11
CTR. LINE	—-—- or Q	Centerline	W.I.C.	Walk-in-closet	10d common galv. nail — joist hanger to header and joist connections	- Consult construction manual for additional information	SECOND FLOOR FRAMING PLAN	7 OF 11
DECO		Decorative	W.P.	White Pine	1 1/2" galv. joist hanger nails — A35Z anchors		ROOF FRAMING PLAN	8 OF 11
DIA.	ø	Diameter	W.W.F.	Welded Wire Fabric	16d galv. finish nails — railing		SECTIONS	9 OF 11
DIM.		Dimension	0	At	8d galv. finish — soffit, 1x8 t&g ceiling paneling, balusters, etc.		SECTIONS	10 OF 11
EGRESS		Emergency Exit Window	#5 BAR	Number 5 Round Bar (5/8" Rebar)			STAIR DETAILS	11 OF 11
ELEV.	•	Elevation Or Starting Point Symbol	GALV.	Galvanized				
GA.		Gauge						
HEM.		Hemlock						
INS. or INSUL.		Insulation						
INT. or EXT.		Interior Or Exterior						
LVL		Laminated Veneer Lumber						
MEAS.		Measurement						
MIN. or MAX.		Minimum Or Maximum						
MISC.		Miscellaneous						
N.T.S.		Not to scale						
0.C.		On Center		SHEET 9				
0.H.		Over hang	2					
P.T.		Pressure Treated	These symbols identify details that	These symbols identify cross sections through				
REF.		Reference	are drawn at a larger scale than plan view to depict how a particular	the entire home (roof to foundation) to depict what a particular area would look like				
REQ'D		Required	area is to be built. The letter identifies the name of the section.	if you sliced through it. The letter identifies the name of the section & the sheet number				
R.O. OR R/O		Rough Opening	The triangle points in the direction that the section is to be viewed.	tells you which sheet the section is located on. The triangle points in the direction that				
S.P.F.		Spruce/Pine/Fir		the section is to be viewed.				

COMMON FASTENERS

LOG WALLS:

3/8" x 12" lags - all full log courses & corners of swedish cope

3/8" x 8" lags - half log courses of all profiles & corners of dovetail profiles

10" timber screws - swedish cope log siding corner extensions & filler corners

8" polebarn nails — butt & pass corners of D profiles & all corner post connections

3/8" x 10" lags - for 8" laminated hemlock logs

1/2" x 8" lags - support posts to log wall connections

3" deck screws - corner extensions & filler corners

16d galv. finish — exterior trim

INTERIOR:

STAIRS:

Beam connections

ROOF SYSTEMS:

or framed wall connection

5/8" x 7" hex bolts — gusset plates 5/8" x 3" lags — single gusset plates

10" timber screws — heavy timber blocking

16d galv. finish nails — 2x fascia, 1x fascia

6d finish nails - 1x8 t&g (ceiling paneling)

1 1/4" galv. roofing nails - shingles

8d galv. finish nails — soffit

16d cement coated sinkers — conventional framing

10d galv. finish - all siding profiles

CONVENTIONAL 2x FLOOR SYSTEM:

16d cement coated sinkers - conventional framing

2" deck screws - swedish cope siding (fastened from interior)

16d galv. ardox nails - perimeter box/joist to ACQ sill plate

10d cement coated sinkers - precast foundation wall blocking

10d Common nails - joist hanger to header connection

3/8" x 8" lags - partition walls to log wall connection 16d cement coated sinkers - conventional framing

10d finish nails — interior door jambs

6d finish nails - 1x8 t&g wall finish

3/8" x 8" lags - (spiral) tread to post

10d finish nails — railing and balusters

to railing post, 6x6 and 8" round railing posts

HEAVY TIMBER LOFT FLOOR SYSTEM:

3/4" x 3" lags - BH68 hanger to beam connection

1 1/4" drywall screw - subflooring. (composition flooring)

16d cement coated sinkers - 2x6 t&g flooring

8d finish nails — interior trim

10d galv. common nails - precast foundation wall blocking to ACQ sill plate

1 1/2" galv. Joist hanger nails — A35Z anchors & joist hanger to joist connection

3/8" x 3" lags - (finihed and basement) landing and support posts, 4x4 railing posts

16d bright finish nails - (finished and basement) tread and riser nails

3/4" x 7" hex bolts - BH68 hanger to 6x8 joist connection or rafter connections

8d cement coated sinkers - 1x8 t&g (composition flooring), metal banding, etc.

1/2" x 8" lags - support posts & rafter supports to log wall connections

12" timber screws - built-up roof system insulation stop, filler rafters, furring strips

8d cement coated sinkers — 1x8 t&g (in built—up roof systems), sheathing, metal banding, etc.

3/8" x 10" lags - purlins, 6x8 decorative ceiling beams, 6x8 rafters to glulam ridge connection

3/8" x 8" lags - 6x8 skylight framing, 6x8 chimney framing, 6x8 rafters to log wall connection

3/8" x 5 1/2" lags — (heavy timber and 1/2 log) stringer and treads, landing, landing support posts, (spiral) tread

3/8" x 12" lags - 8x12 and/or glu-lam beams to 8x12 and/or glu-lam beams, 8x12 and/or glu-lam beams to post connections


3/8" x 12" lags - glu lam beams, 6x8 rafters notched into loft joists, 4x/6x12 exposed beams, & decro purlin to log wall

5/8" x 8" and/or 10" hex bolts - collar ties in 2x rafter roof system (refer to collar tie details for bolt lengths)

3/8" x 10" lags - 6x8/8" round loft joists to interior & exterior framed wall connections, log wall connections, &

3/8" x 8" lags - 6x8 joists to log wall (fastened from log toward joist refer to 6x8 joist to log wall detail)

8d cement coated sinkers - subflooring, metal banding, bridging, etc.

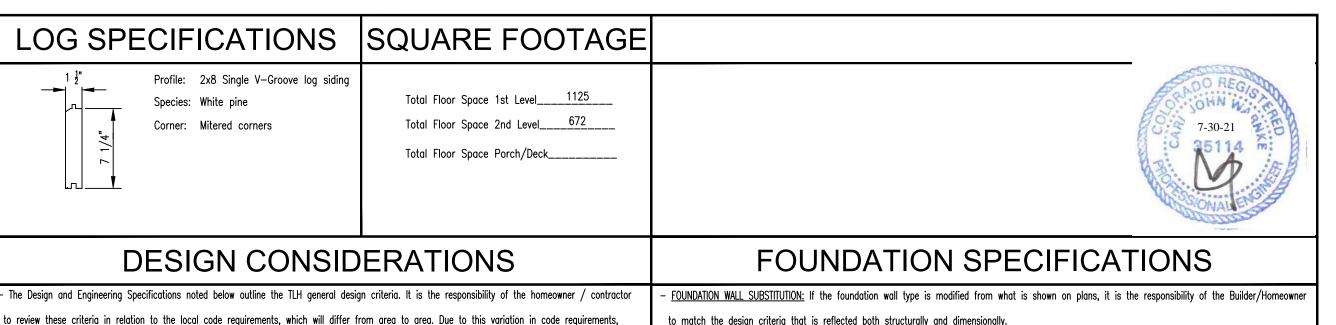

Poured wall width:

Poured wall height:

FIREPLACE

Poured wall:

Pre-cast wall:

PORCH/DECK

Post foundation type:

Heavy timber posts

Glued laminated beams

Conventional framing lumber

- WIND LOAD: .90 MPH

INSULATION VALUES

P.T. framing lumber

DESIGN LOADS

8x12 beams

STRUCTURAL COMPONENTS

Heavy timber joists, purlins & rafters

Pre-cast wall r-value:

result of the local code requirements or the review by the registered design professional may require a change in the package price.

- Metal roof considerations: all details and/or materials related to the installation, design and performance of metal roof system to be the sole

Venting drip edge is to be installed in conjunction with shingle roofs. If a metal roof is installed it is the responsibility of the contractor and/or

- Local codes may require an attic access for spaces with or without storage. Refer to local codes for the specifications to determine the required rough

ppening size and location of access opening. It is the responsibility of the contractor/ homeowner to verify this information prior to construction. For

truss roofs spaced at 24" o.c. the desired access location can be determined on site. For truss roofs spaced at 16" o.c. the desired access location

DESIGN SPECIFICATIONS

- High altitude glass: Andersen windows and doors with high altitude glass require a capillary breather tube. The use of this tube eliminates argon

Measurement from top of subfloor to bottom of 6x8 floor joists is 7'-9 3/4".

Measurement from top of subfloor to bottom of ceiling finish is 8'-5".

design approval of the home as well as the implementation of this design in relation to the above concerns.

not be totally compatible with metal roof manufacturer's specifications. Verify prior to installation.

must be provided to TLH to allow proper adjustment in the truss spacing/design to accommodate access.

- Stair landings $-3'-0" \times 3'-0"$ minimum square area (wall finish to wall finish)

gas fill and will result in a slightly lower thermal performance (approximately 0.02 increase in window u-factor).

- Stairs - minimum tread of 10" nose to nose - maximum rise of 7 3/4"

Finished stair - 10" nose to nose with 1" nosing

Exposed stair - 10" nose to nose with 1/4" nosing

- Standard (4) 2x12 girder beam with support posts @ 8'-0" o.c. maximum spacing

- Standard closet depth - 2'-1 1/2" - Standard laundry closet depth - 2'-9"

- Spacing between balusters — 4" maximum

- Fire doors between house/garage areas

- Egress windows (minimum one per bedroom)

* All roof windows/skylights

* All patio doors

Tempered windows required for the following areas:

- Hallway width -3'-0" minimum (wall finish to wall finish)

* All windows located within bath areas

* All windows located within 18" of floor

- 2nd floor joists are located in the 14th log course

- Standard 2x10 floor joist @ 16" o.c.

* All windows within 5'-0" of stair landings

* All windows located within 24" of a door

☐ 10" Block (std.)

□ 8" □ 10"

□ 8'-0" □ 9'-0"

☐ R-5 ☐ R-12.5

□ 8'-2" □ 9'-0"

□ 8'-0" □ 9'-0"

SECONDARY: (Example: Area: Mudroom / Type: Block / Width: 10" / Height: Crawlspace)

☐ Full foundation and footing required.

ENGINEERING SPECIFICATIONS

White pine laminated logs

Eastern white pine / spruce

Eastern white pine

Southern yellow pine

Southern yellow pine

S.P.F. (Spruce/Pine/Fir

- R-38 insulation minimum @ Beam and purlin roof system, 6x8 rafter roof system, 2x12 rafter roof system, and_

☐ 8" block w/6" top block (std.)

Spruce

- Floor load (1st and 2nd floor systems) — designed for 40 lb./sq. ft. live load

- Floor load (Porch/deck floor systems) - designed for 40 lb./sq. ft. live load

- Floor load (Balcony floor systems) - designed for 60 lb./sq. ft. live load

- All connections per applicable code unless otherwise noted

pre-fab truss roof systems (VERIFY PER LOCAL CODES)

- All connections specified are Simpson or equal

- R-21 insulation for exterior stud walls

☐ 8" Wide

☐ 4'-0" High

☐ Sonotube-size

☐ 2x8 @ 12" o.c.

☐ 8'-0" ☐ 9'-0" (std.)

☐ 10'-0" ☐ Other _____

☐ 10'-0" ☐ Other <u>CRAWLSPACE</u>

Zero clearance

☐ Other _

☐ Other _

☐ Other _

☐ Other _

☐ Pier-size

Header or #2

Header or #2

#2 or better


LIVE LOAD: .85 . PSF

Architectural 24FV4


| Wall log, header grade or #2

☐ 10'-0" ☐ Other _____


☐ 10'-0"
☐ 0ther _

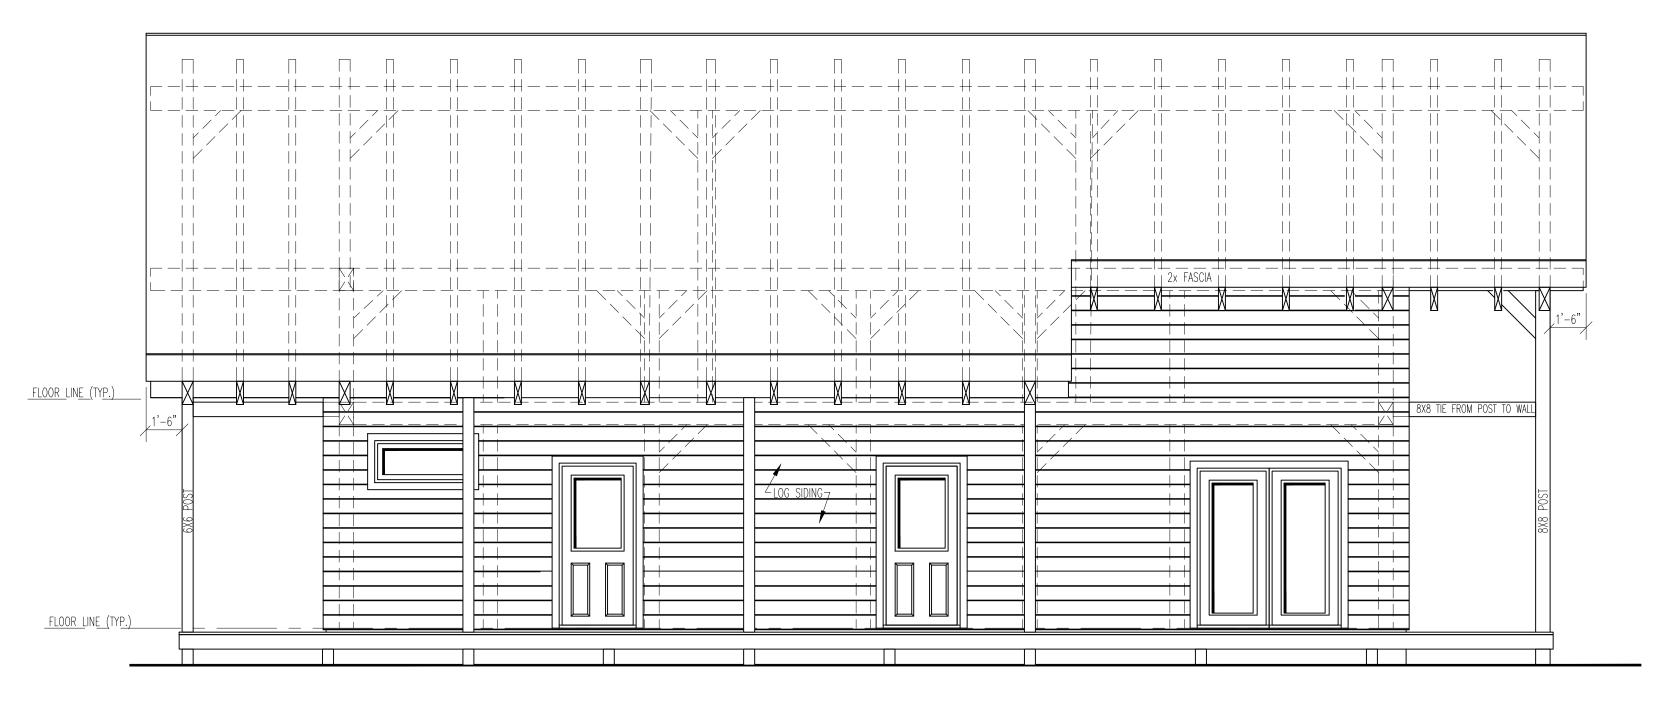


FRONT ELEVATION

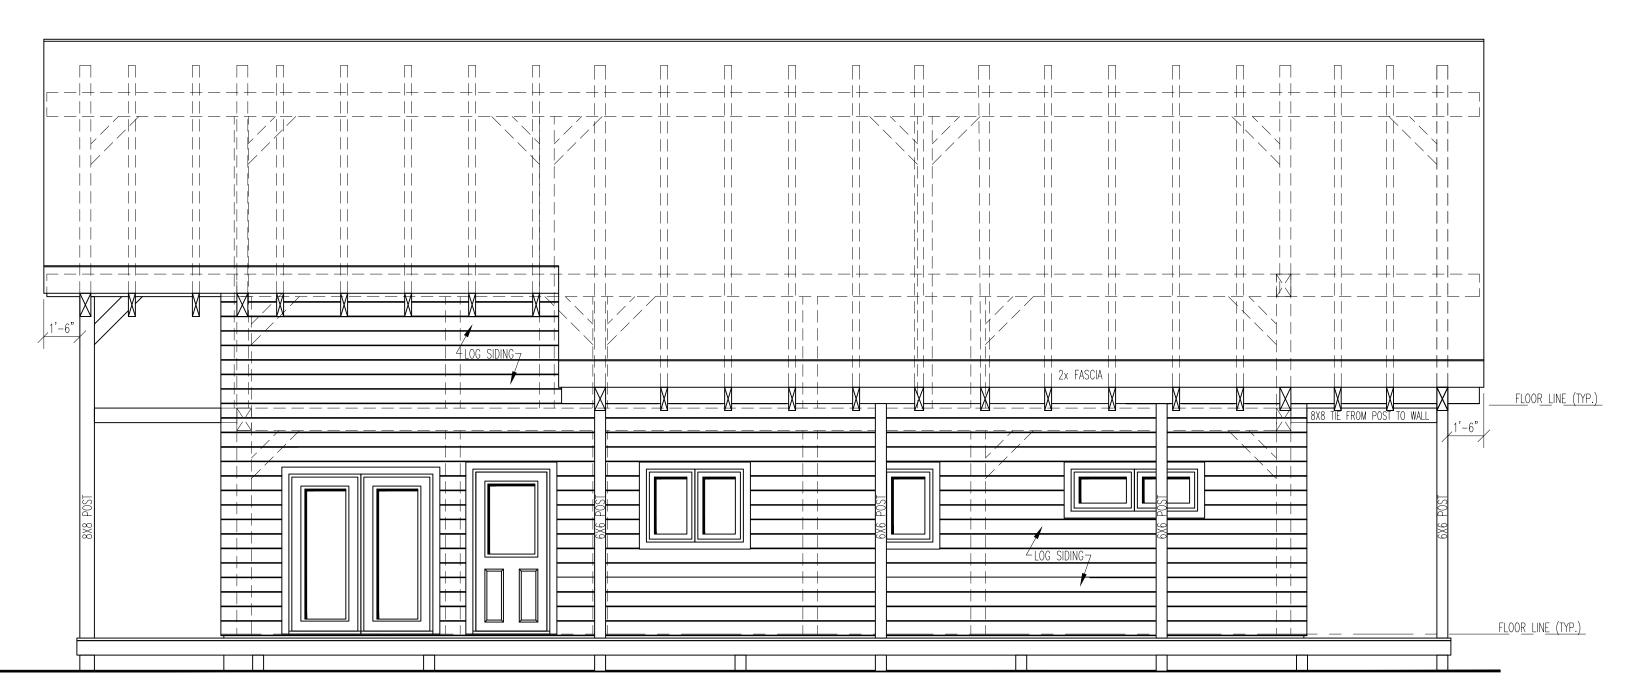

REAR ELEVATION

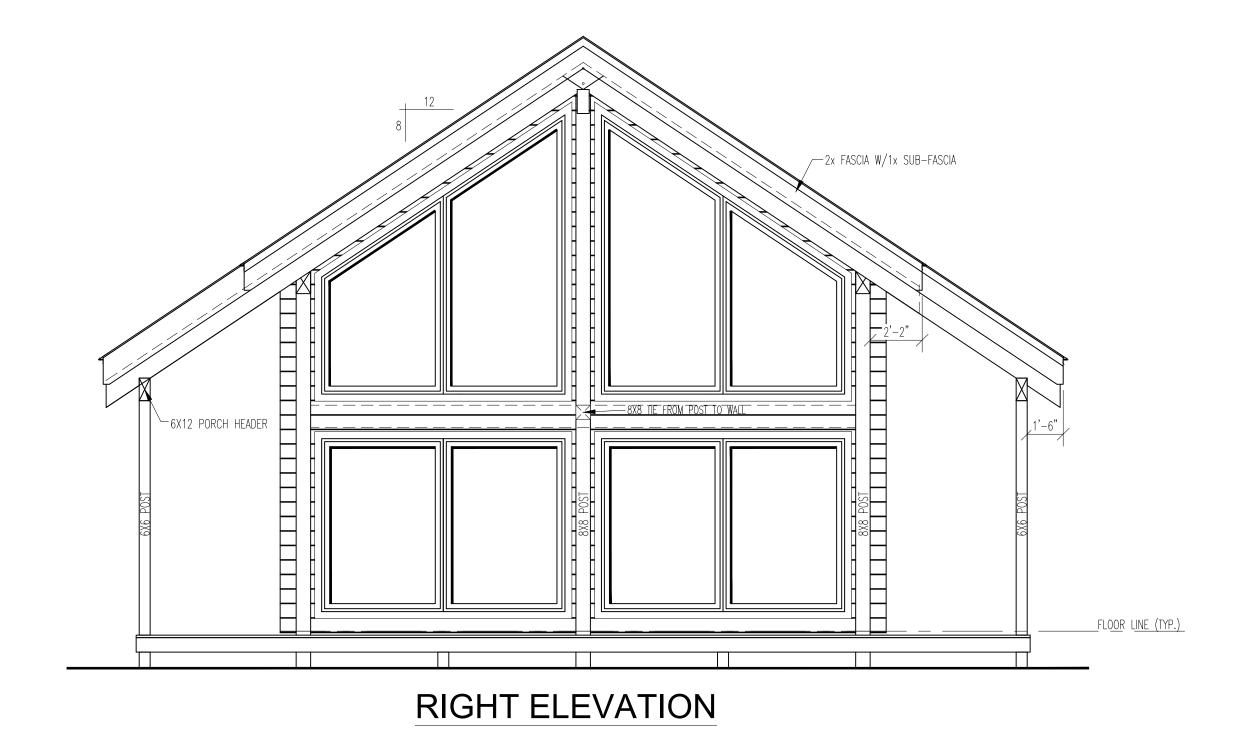

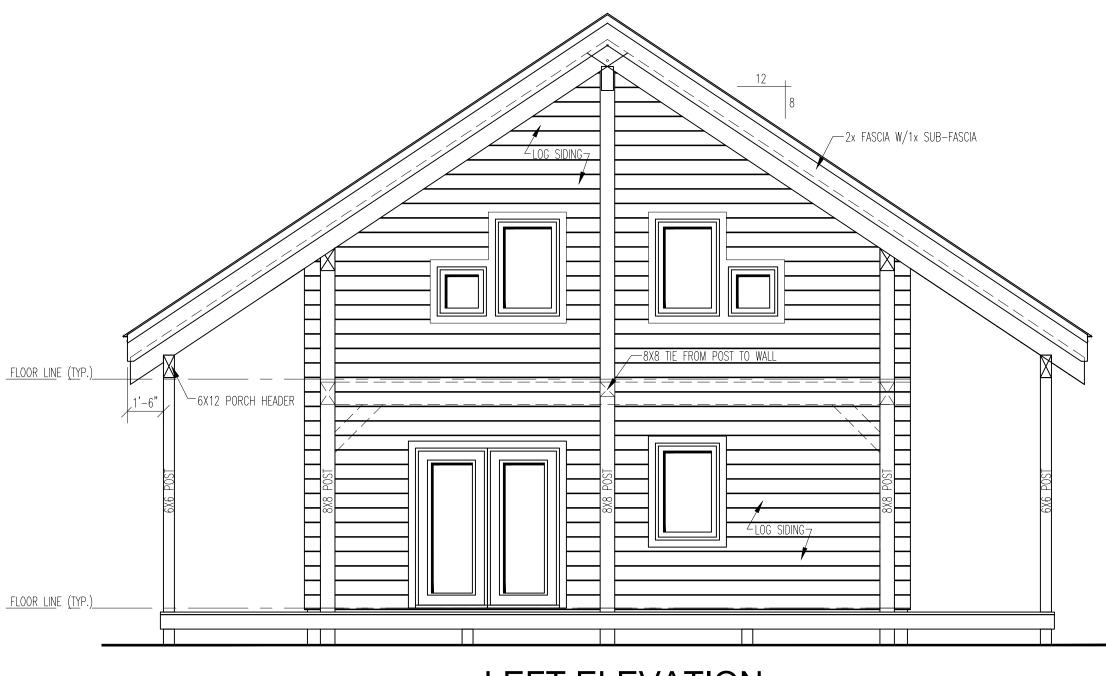

LEFT ELEVATION

ELEVATION GENERAL NOTES

- GENERAL SPECIFICATONS : SEE COVERSHEET.

- **DETAILS**: REFER TO APPLICABLE DETAILS FOR ELEVATION INFORMATION

- <u>SHINGLE NOTE</u>: ADHERE TO MANUFACTURERS INSTRUCTIONS TO APPLY SHINGLES TO A ROOF WITH LESS THAN 4/12 PITCH

- OVERHANGS : ALL OVERHANGS ARE 2'-0" UNLESS NOTED OTHERWISE (SEE ROOF FRAMING PLAN)

- VERIFY GRADE ON SITE: STEPS & POSTS TO GRADE BY OTHERS.


- <u>PIER SIZE</u>: SPECIFICATIONS FOR SIZE OF PIERS & PIER PADS, SONOTUBES ECT., IS TO BE DETERMINED BY OTHERS IN RELATION TO LOCAL CODES AND SOIL CONDITIONS. PROVIDED BY OTHERS.

- LOG SIDING SKIRT BOARD: LOG SIDING SKIRT BOARD IS NOT PROVIDED BELOW PORCHES & DECKS. 2 ROWS OF LOG SIDING SKIRT BOARD PROVIDED FOR 6x8 & 8x8 LOG PROFILES WITH MORTISE AND TENON CORNERS. FLASHING PROVIDED (IN LIEU OF LOG SIDING SKIRT BOARD) FOR SWEDISH COPE AND ALL LOG PROFILES WITH DOVETAIL & SADDLE NOTCH CORNERS.

- **DETAILS**: ALL DETAIL REFERENCES NOT NOTED ARE FOUND WITHIN THE DETAIL SHEETS AND TIMBERHAVEN CONSTRUCTION MANUAL. PLEASE REFER TO THE OTHER SHEETS AND MANUAL, TYPICAL.

- MATERIALS INCLUDED: ALL DETAILS PERTAINING TO MATERIAL NOT SUPPLIED BY TLH MUST BE VERIFIED PRIOR
TO ACTUAL CONSTRUCTION. SEE APPROPRIATE QUOTE AND ALL APPLICABLE CHANGE ORDERS FOR
MATERIALS TO BE SUPPLIED BY TLH.

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DO NOT	CALE DRAWING -contractor to verify all dimensions in field
1	RESIDENCE FOR:

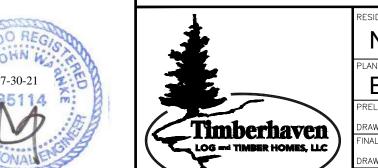NATHAN & ALISON NICHOLAS - PLUS PUU

PLAN NAME:

ELEVATIONS

PRELIMINARY DATES: 3/19/21 FINAL PRELIM. DATES: ____ FINAL DATES: 7/27/21


DRAWN BY: WRZR

FINAL REV. DATES: ____ BODEL:

OUGTON

OUGTON

DWG. NO. TLH-10454 SHEET NO. 1 OF 11

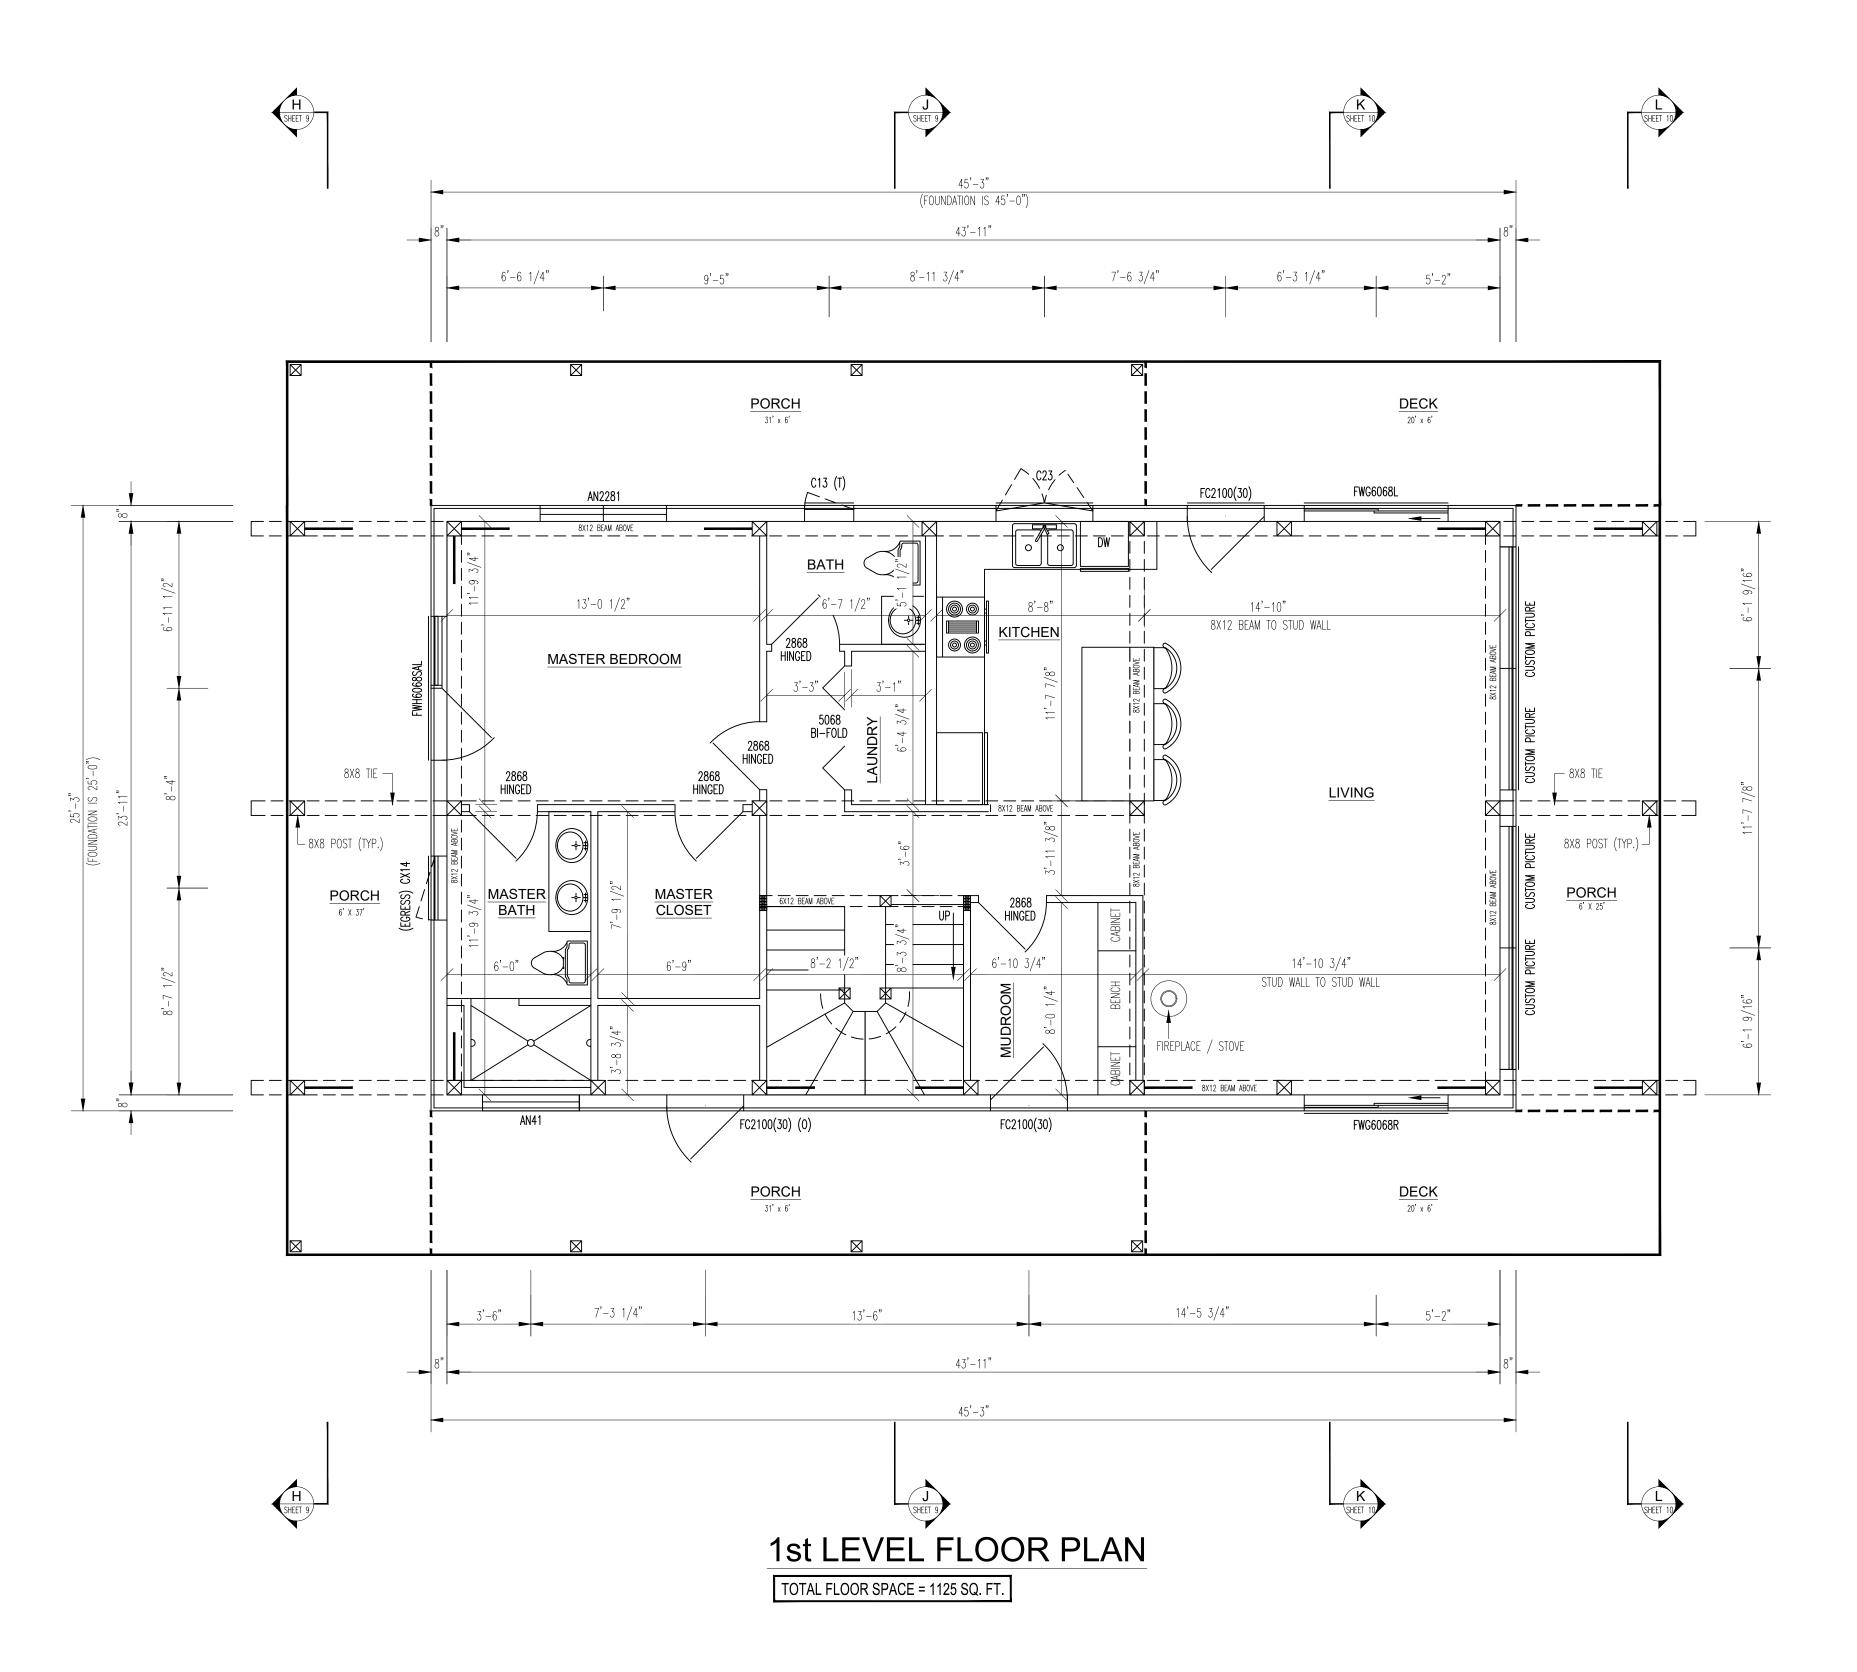

FLOOR PLAN GENERAL NOTES

- **GENERAL SPECIFICATONS** : SEE COVERSHEET.

- $\underline{\textbf{DETAILS}}$: REFER TO APPLICABLE DETAILS FOR FLOOR PLAN INFORMATION

- <u>INTERIOR PARTITION HEIGHTS</u>: REFER TO SECTIONS FOR APPROPRIATE HEIGHT.

- MULLED WINDOWS: WINDOWS MAY NEED MULLED ON SITE DUE TO SIZE OR TYPE.

- <u>DETAILS</u>: ALL DETAIL REFERENCES NOT NOTED ARE FOUND WITHIN THE DETAIL SHEETS AND TIMBERHAVEN CONSTRUCTION MANUAL. PLEASE REFER TO THE OTHER SHEETS AND MANUAL, TYPICAL.
- <u>MATERIALS INCLUDED</u>: ALL DETAILS PERTAINING TO MATERIAL NOT SUPPLIED BY TLH MUST BE VERIFIED PRIOR TO ACTUAL CONSTRUCTION. SEE APPROPRIATE QUOTE AND ALL APPLICABLE CHANGE ORDERS FOR MATERIALS TO BE SUPPLIED BY TLH.

INTERIOR FASTENERS

- 3/8" x 8" LAGS : PARTITION WALLS TO LOG WALL CONNECTION

- 16d CEMENT COATED SINKERS: CONVENTIONAL FRAMING

- 10d FINISH NAILS: INTERIOR DOOR JAMBS

- 8d FINISH NAILS: INTERIOR TRIM

- 6d FINISH NAILS: 1x8 T&G WALL FINISH

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DO NOT SCALE DRAWING -CONTRACTOR TO VERIFY ALL DIMENSIONS IN FIELD





NATHAN & ALISON NICHOLAS - PLUS PUU
PLAN NAME:

1ST LEVEL FLOOR PLAN

 PRELIMINARY DATES: 3/19/21
 FINAL PRELIM. DATES: ____
 FINAL DATES: 7/27/21


 DRAWN BY: WRZR
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 FINAL REV. DATES: ____
 MODEL: SCALE: 1/4" = 1'-0"


 DRAWN BY: -- PROJ. NO. ---

 SALES REP. / DEALER: ____
 DWG. NO. TLH-10454

SHEET NO. 2 OF 11

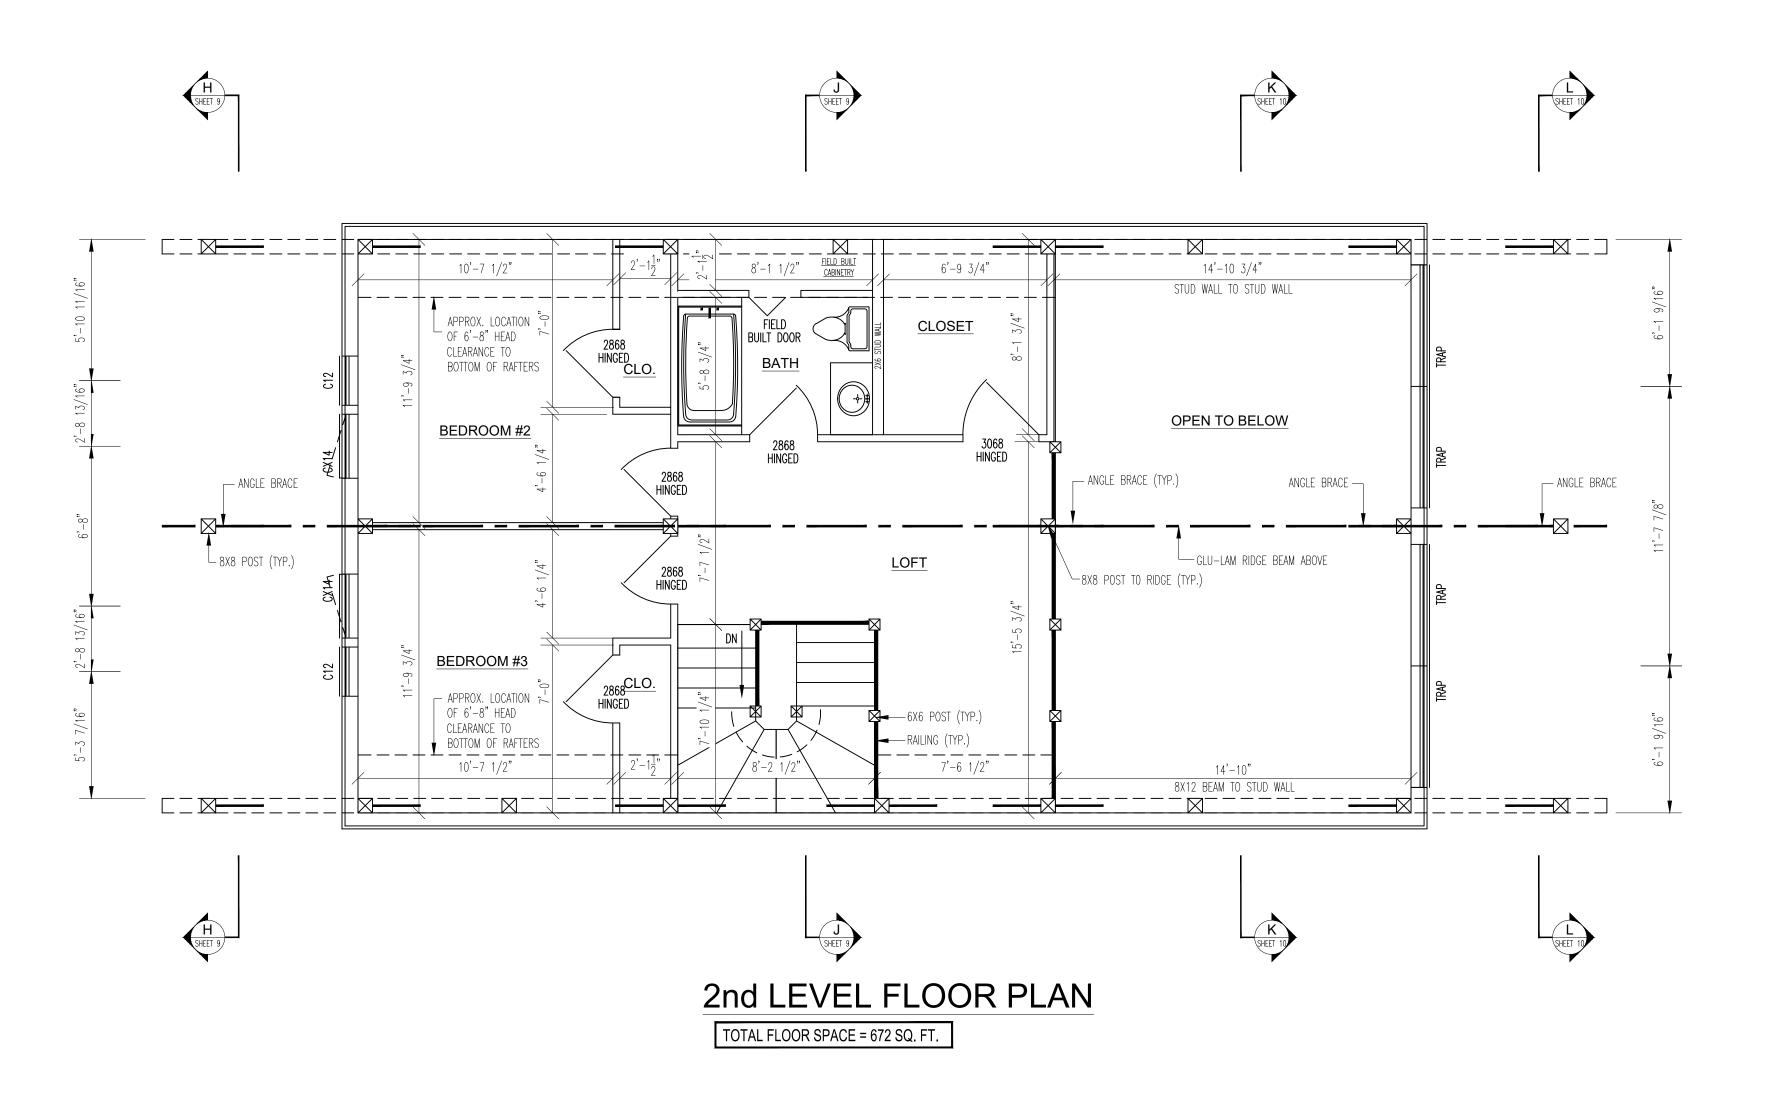

		WINDOW & D	OOR SCHEDULE	
MODEL#	QTY	ROUGH OPENING	DESCRIPTION	COMMENTS
FC2100(30) (0)	1	3'-2 1/2" x 6'-9 1/4"	THERMA-TRU OUTSWING ENTRY DOOR	
FWG6068R	1	6'-0" x 6'-8"	ANDERSEN FRENCHWOOD GLIDING PATIO DOORS	
FC2100(30)	2	3'-2 1/2" x 6'-10 1/2"	THERMA-TRU OUTSWING ENTRY DOOR	
FWG6068L	1	6'-0" x 6'-8"	ANDERSEN FRENCHWOOD GLIDING PATIO DOORS	
FWH6068SAL	1	6'-0" x 6'-8"	ANDERSEN FRENCHWOOD HINGED PATIO DOOR	
CX14	3	2'-8" x 4'-0 1/2"	ANDERSEN CASEMENT WINDOW	
C12	2	2'-0 5/8" x 2'-0 5/8"	ANDERSEN CASEMENT WINDOW	
C13 (T)	1	2'-0 5/8" x 3'-0 1/2"	ANDERSEN CASEMENT WINDOW (TEMPERED)	
C23	1	4'-0 1/2" x 3'-0 1/2"	ANDERSEN CASEMENT WINDOW	
CUSTOM PICTURE	4	3'-8 13/16" x 7'-0"	CUSTOM PICTURE WINDOW	
AN2281	1	5'-3 1/4" x 1'-9"	ANDERSEN TWIN AWNING WINDOW	
AN41	1	4'-0 1/2" x 1'-9"	ANDERSEN TWIN AWNING WINDOW	
TRAP	4	SEE WNDOW DETAIL	CUSTOM TRAPEZOID	
2868	10	2'-10" x 6'-10"	RAISED PANEL WHITE PINE INTERIOR HINGED DOOR	
3068	1	3'-2" x 6'-10"	RAISED PANEL WHITE PINE INTERIOR HINGED DOOR	
5068	1	5'-2" x 6'-10"	RAISED PANEL WHITE PINE BI-FOLD DOORS	
FIELD BUILT DOOR	1	FIELD BUILT DOOR	RAISED PANEL WHITE PINE BI-FOLD DOORS	

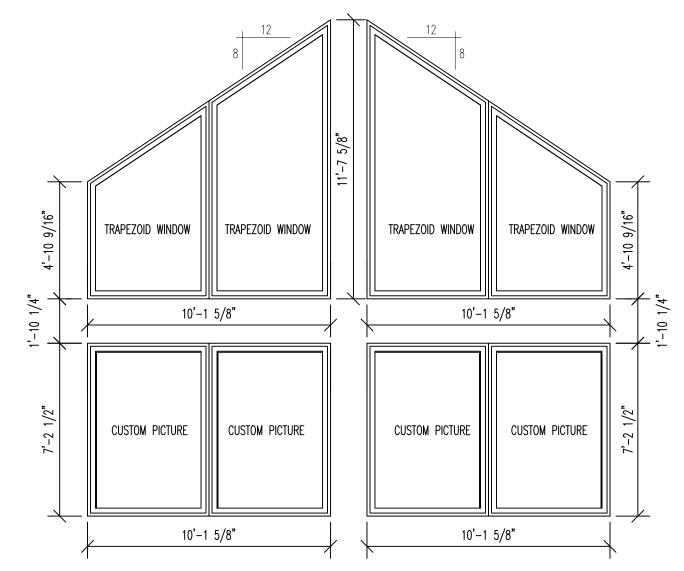


CUSTOM WINDOW DETAILS

3/8" = 1'-0"

* NOTE: WINDOW DIMENSIONS SHOWN ARE FOR ROUGH OPENINGS (FROM BUCK TO BUCK)

* * VIEWED FROM OUTSIDE OF HOME LOOKING INSIDE * *

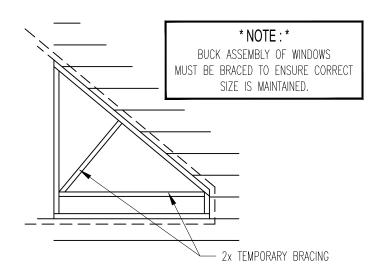

BRACING DETAIL

NOT TO SCALE


** NOTE **

SOME BUILDERS PREFER TO SHEET ASSEMBLY
SOLID WITH PLYWOOD OR OSB TO MAINTAIN
SIZE OF ASSEMBLY AND TO OFFER SOME
WEATHER PROTECTION UNTIL WINDOWS ARE
INSTALLED.

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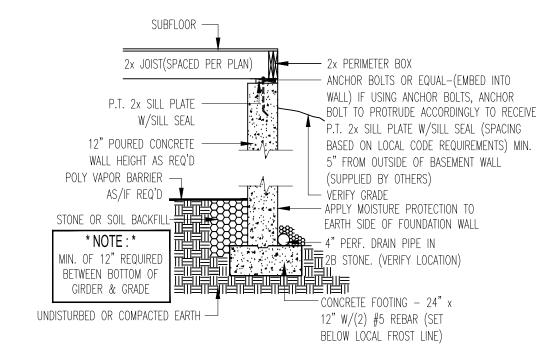
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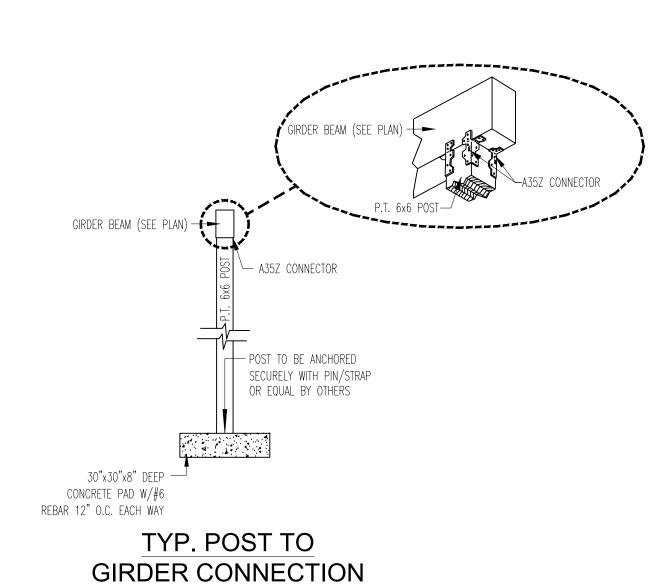



RESIDENCE FOR: NATHAN & ALISON NICHOLAS - PLUS PUU PLAN NAME: 2ND LEVEL FLOOR PLAN

	PRELIMINARY DATES: 3/19/21	FINAL PRELIM. DATES:	FINAL DATES: 7/27/21
)	drawn by: WRZR	DRAWN BY:	drawn by: WRZR
	FINAL REV. DATES:		SCALE: $1/4" = 1'-0"$
	DRAWN BY:	CUSTOM	PROJ. NO
	SALES REP. / Dealer: TILI		dwg. no. TLH-10454
	ľ ILM	SHEET NO. 3 OF 11	

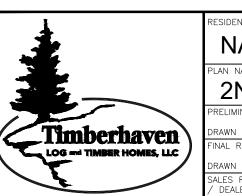

SECTION A-A NOT TO SCALE



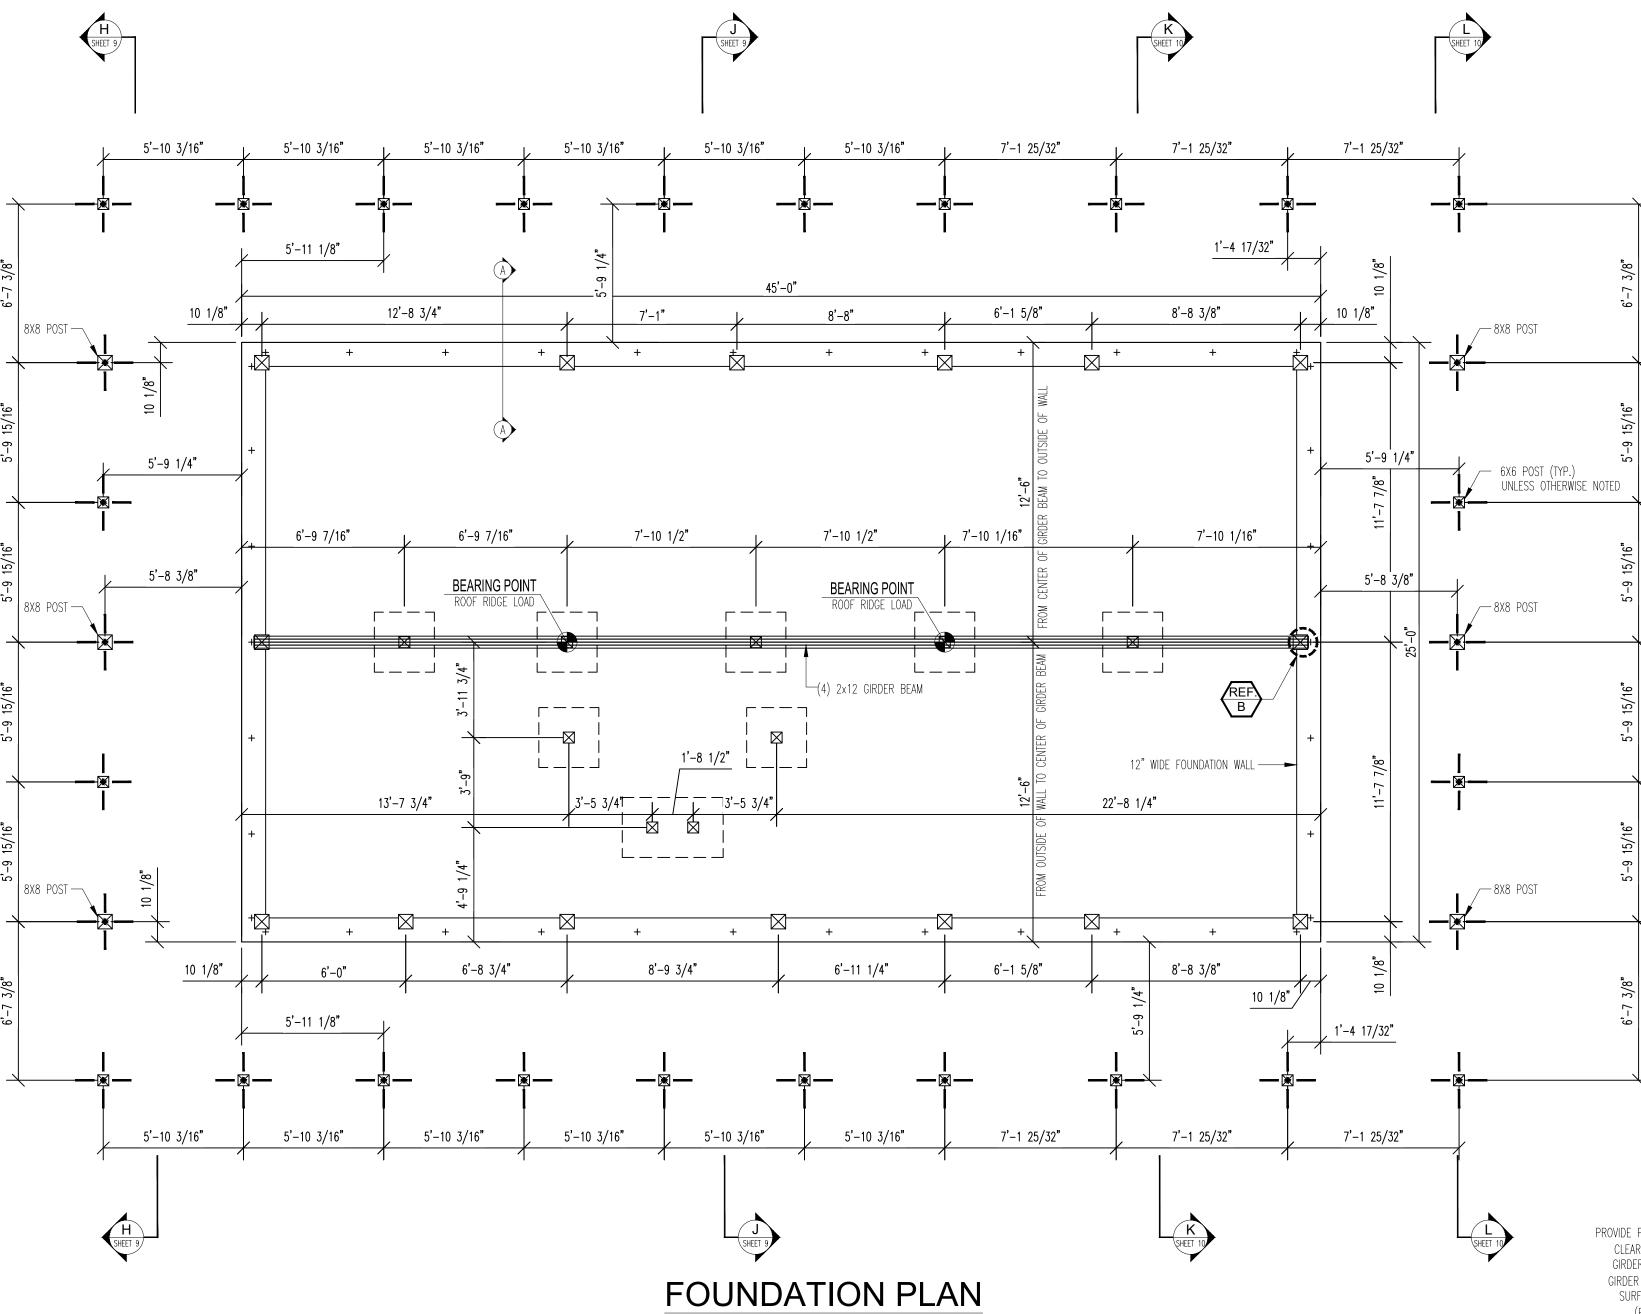

— - INDICATES CENTERLINES FOR POST PIERS

51'-5 3/4"

FOUNDATION DIAGONALS SCHEMATIC

NOT TO SCALE

DARKENED LINE REPRESENTS OUTSIDE OF FOUNDATION WALL (DIM. TO OUTSIDE OF WALL)

DIAGONAL MEASUREMENTS MUST BE AS NOTED

FOUNDATION PLAN GENERAL NOTES

- **GENERAL SPECIFICATONS** : SEE COVERSHEET.

- **DETAILS**: REFER TO APPLICABLE DETAILS FOR FOUNDATION INFORMATION

- <u>CRAWL SPACE</u>: PROPER CROSS VENTILATION AND ACCESS TO CRAWL SPACE AREA TO BE PROVIDED BY OTHERS/ CONTRACTOR. VENTILATION REQUIREMENTS SHOULD BE DETERMINED PRIOR TO CONSTRUCTION.

- PRECAST FOUNDATION WALLS: FOUNDATION PLAN IS DRAWN AS IF CONVENTIONAL BLOCK WALLS ARE TO BE USED. IT IS THE RESPONSIBILITY OF THE SUPPLIER OF THE PRECAST WALLS (IF USED) TO MATCH THE DESIGN CRITERIA THAT IS REFLECTED ON PLANS BOTH STRUCTURALLY AND DIMENSIONALLY.

- FRAMED FOUNDATION WALLS: ACTUAL DETAILS PERTAINING TO WOOD FOUNDATION CONSTRUCTION AND ACTUAL MATERIALS REQUIRED ARE SOLE RESPONSIBILITY OF OTHERS. FOUNDATION WALL MUST BE CONSTRUCTED IN SUCH A WAY AS TO MEET OR EXCEED THE STRUCTURAL INTEGRITY OF A CONVENTIONAL 10" CONCRETE BLOCK.

PILASTERS/ REINFORCEMENT FOR FOUNDATION WALLS: FOUNDATION WALLS MAY REQUIRE ADDITIONAL REINFORCEMENT IN THE FORM OF PILASTERS, ADDITIONAL REBAR, ETC.. CONSULT LOCAL CODE, SOIL CONDITIONS, FROST LINE DEPTH, AND GRADE VARIATIONS FOR FINAL DETERMINING FACTORS IN SIZING PILASTERS AND/OR ADDITIONAL REINFORCEMENT. THE ABOVE IS TO BE VERIFIED /DETERMINED PRIOR TO CONSTRUCTION AND IS NOT THE RESPONSIBILITY OF TLH.

- <u>BASEMENT GARAGE</u>: REFER TO LOCAL CODES PERTAINING TO THE REQUIREMENTS FOR BASEMENT GARAGES. VERIFY PRIOR TO CONSTRUCTION.

- FIREPLACE/CHIMNEY STRUCTURE NOTE: THE ACTUAL/FINAL SIZE & LOCATION OF THE FIREPLACE/CHIMNEY STRUCTURE TO BE DETERMINED IN THE FIELD PRIOR TO CONSTRUCTION. THE REQUIRED FOOTING TO BE INSTALLED BASED ON THE FIREPLACE/CHIMNEY REQUIREMENTS IN ACCORDANCE WITH LOCAL CODE, SOIL CONDITIONS, ETC. (NOTE: MINIMUM #5 BAR @ 1'-0" O.C. INSTALLED BOTH DIRECTIONS TO FORM GRID.)


- <u>FOOTINGS & RELATED DETAILS</u>: LOCAL CODE, SOIL CONDITIONS, FROST LINE DEPTH AND GRADE VARIATIONS TO BE FINAL DETERMINING FACTORS IN SIZING OF FOOTINGS & RELATED DETAILS. FOOTING & DETAILS SHOWN ARE RECOMMENDED MINIMUM STANDARDS ONLY FOR CONDITIONS CONDUCIVE TO THEIR USE.


- 8" CONCRETE BLOCK: TLH RECOMMENDS A MINIMUM OF 10" CONCRETE BLOCK. IF 8" CONCRETE BLOCK IS UTILIZED, CELLS MUST BE FILLED ENTIRELY WITH CONCRETE AND REBAR INSTALLED WITHIN THE CELLS. PILASTERS SHOULD BE INCORPORATED AS/IF REQUIRED. CONSULT LOCAL CODES, FOOTING REQUIREMENTS, SOIL CONDITIONS, FROST LINE DEPTH AND GRADE VARIATIONS FOR THE FINAL DETERMINING FACTORS IN SIZING PILASTERS AND/OR ADDITIONAL REINFORCEMENT. THE ABOVE TO BE VERIFIED/DETERMINED PRIOR TO CONSTRUCTION, AND IS NOT THE RESPONSIBILITY OF TLH.

- <u>DETAILS</u>: ALL DETAIL REFERENCES NOT NOTED ARE FOUND WITHIN THE DETAIL SHEETS AND TIMBERHAVEN CONSTRUCTION MANUAL. PLEASE REFER TO THE OTHER SHEETS AND MANUAL, TYPICAL.

- MATERIALS INCLUDED: ALL DETAILS PERTAINING TO MATERIAL NOT SUPPLIED BY TLH MUST BE VERIFIED PRIOR TO ACTUAL CONSTRUCTION. SEE APPROPRIATE QUOTE AND ALL APPLICABLE CHANGE ORDERS FOR ALL MATERIALS TO BE SUPPLIED BY TLH.


- POURED WALL REINFORCEMENT: POURED WALL MAY REQUIRE ADDITIONAL REINFORCEMENT IN THE FORM OF POURED PILASTERS, ADDITIONAL REBAR ETC. CONSULT LOCAL CODE, SOIL CONDITIONS, FROST LINE DEPTH AND GRADE VARIATIONS FOR THE FINAL DETERMINING FACTORS IN SIZING PILASTERS AND/OR ADDITIONAL REINFORCEMENT. THE ABOVE TO BE VERIFIED/DETERMINED PRIOR TO CONSTRUCTION, AND IS NOT THE RESPONSIBILITY OF TLH.

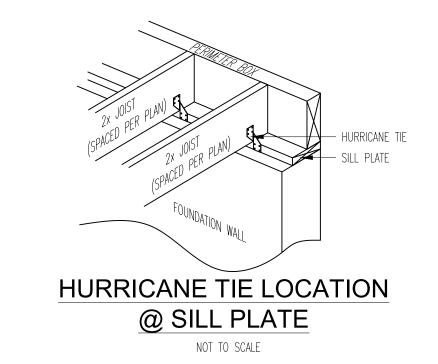


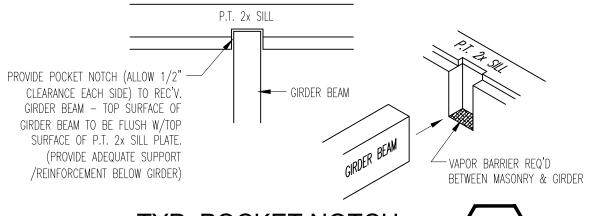



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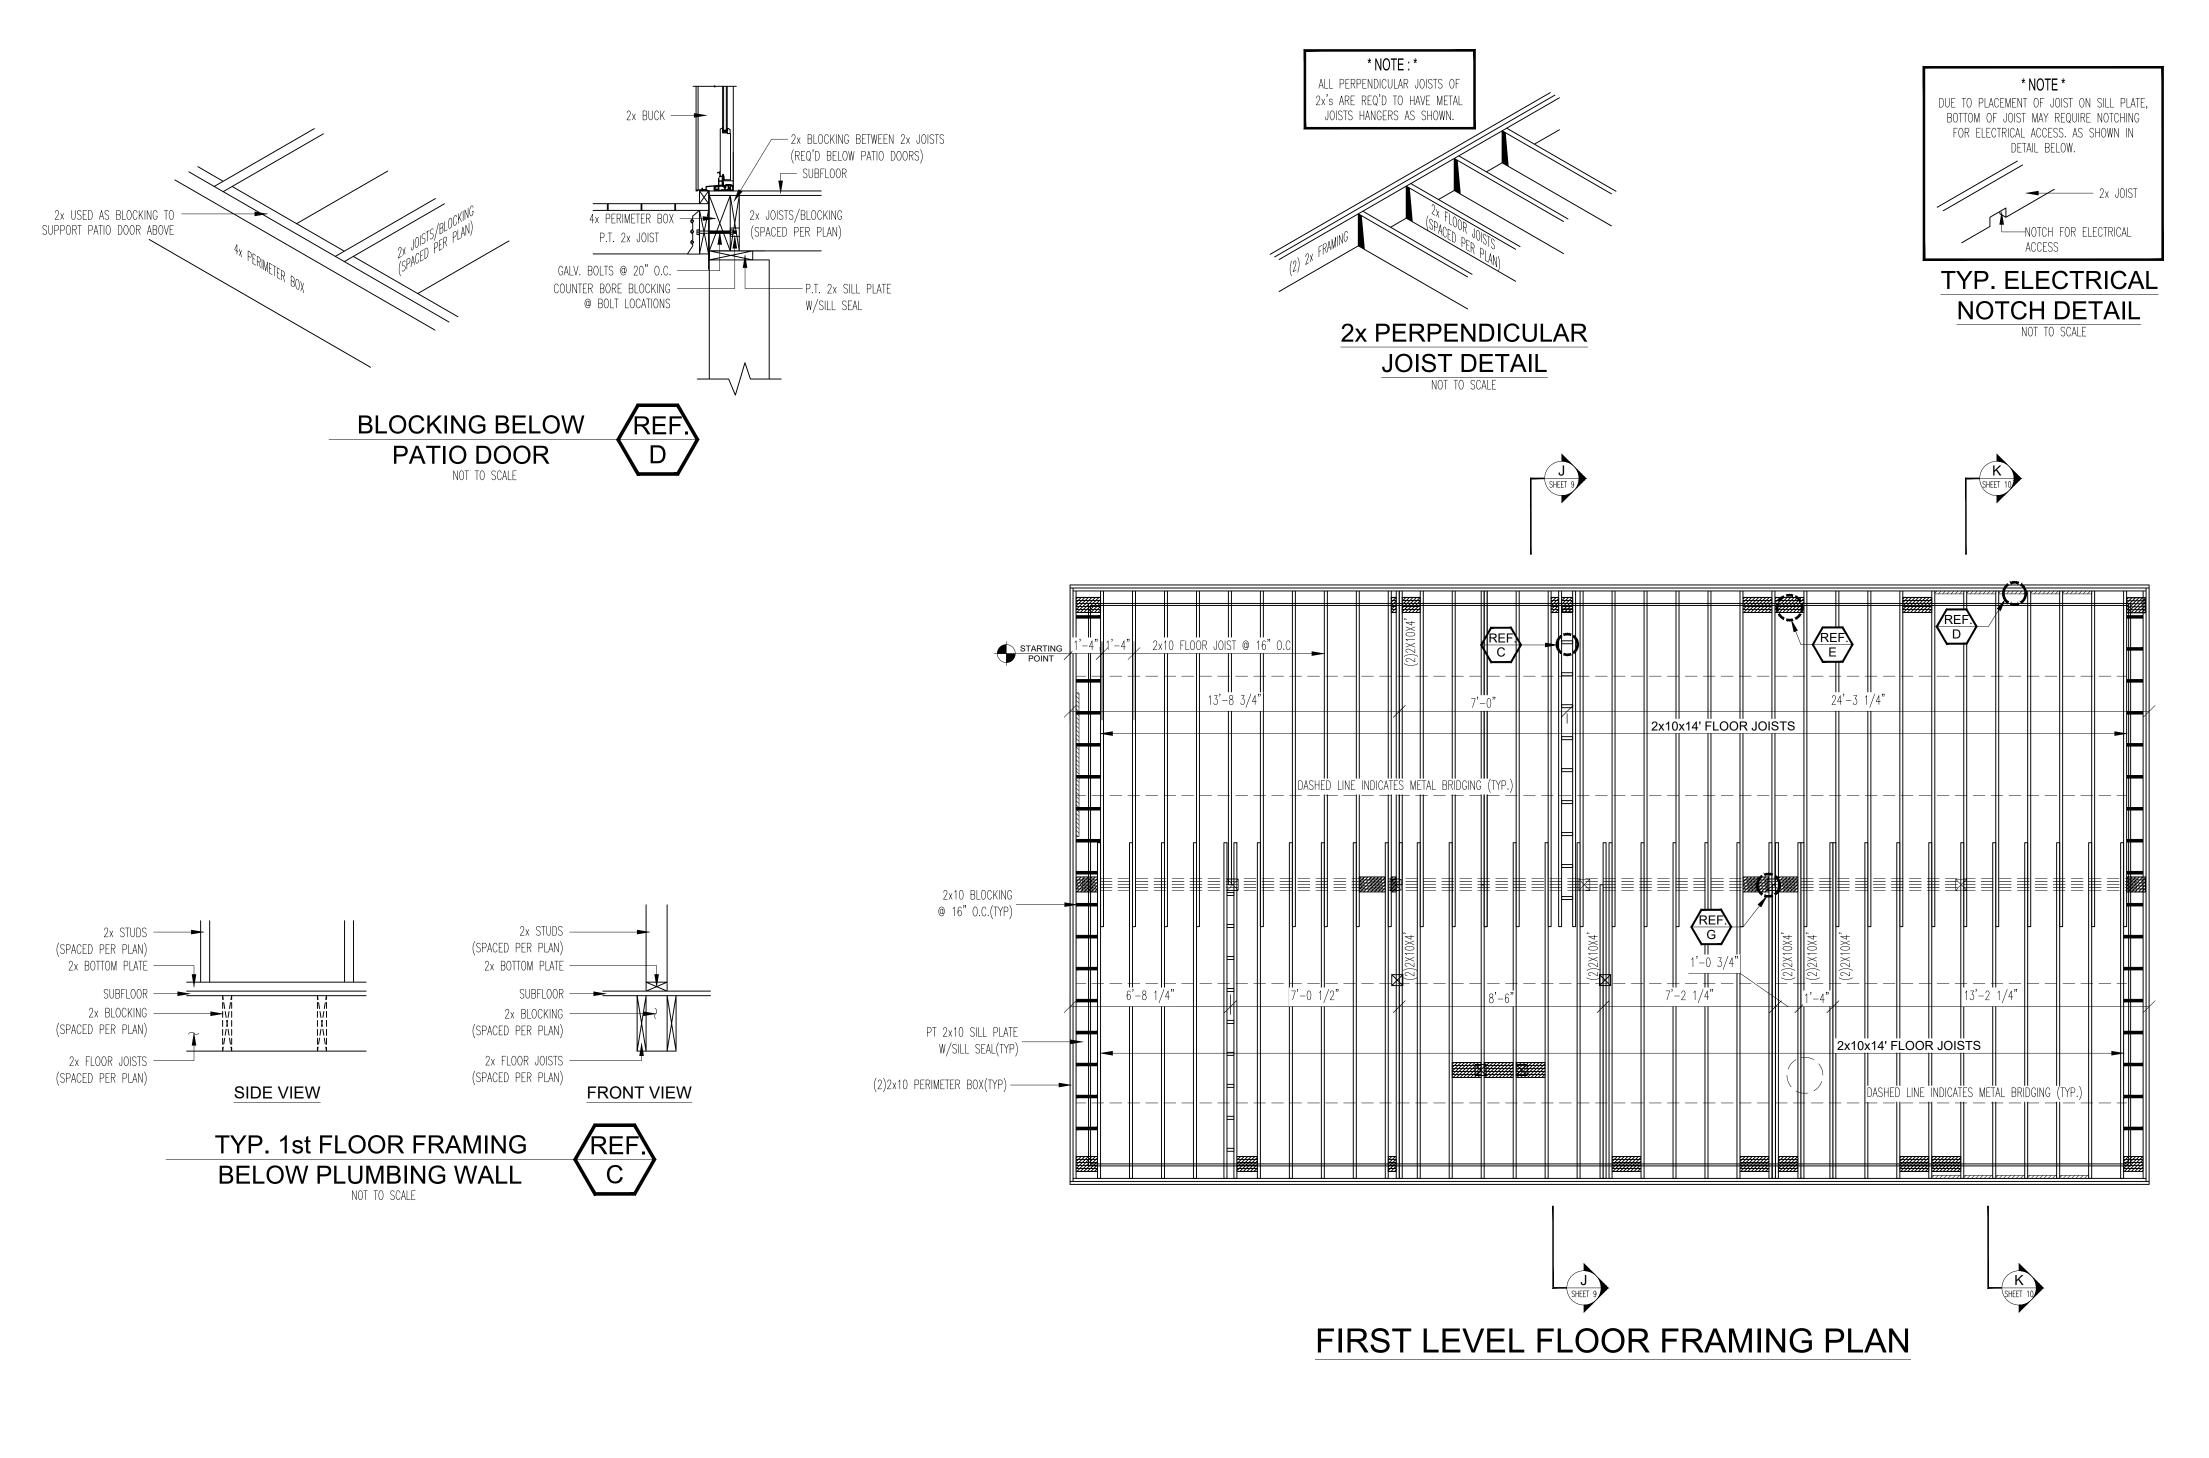
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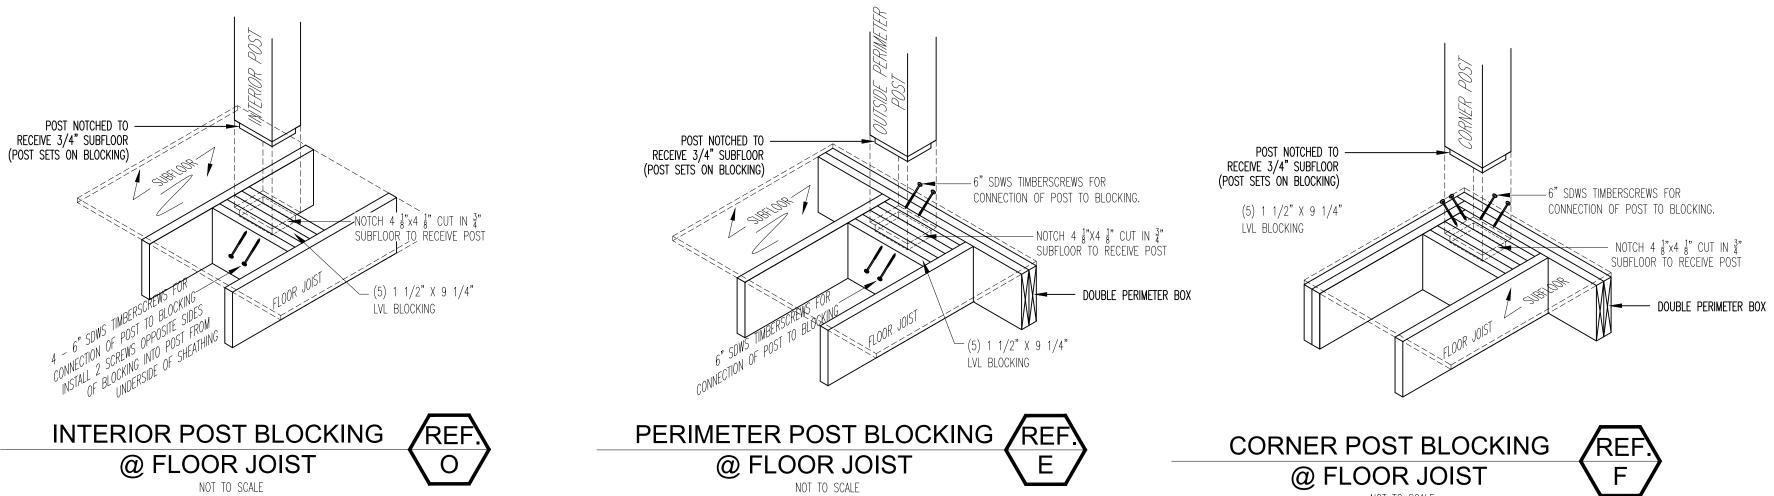
NATHAN & ALISON NICHOLAS - PLUS PUU
PLAN NAME:

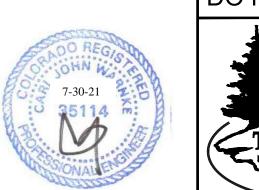FOUNDATION PLAN

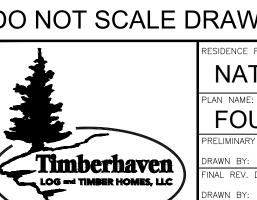PRELIMINARY DATES: 3/19/21 | FINAL PRELIM. DATES: ____ | FINAL DATES: ____ |
DRAWN BY: WRZR | DRAWN BY: ---- | DRAWN BY: WRZR

FINAL REV. DATES: ____ | MODEL: | SCALE: 1/4" = 1'-0" |
DRAWN BY: ---- | CUSTOM | PROJ. NO. ---- |
SALES REP. | DWG. NO. TLH-10454 |
SHEET NO. 4 OF 11





CONVENTIONAL 2x FLOOR SYSTEM FASTENERS

- 16d GALV. ARDOX NAILS: PERIMETER BOX/JOIST TO ACQ SILL PLATE

- 16d CEMENT COATED SINKERS: CONVENTIONAL FRAMING

- 10d CEMENT COATED SINKERS: PRE-CAST FOUNDATION WALL BLOCKING

- 10d GALV. COMMON NAILS: PRE-CAST FOUNDATION WALL BLOCKING TO ACQ SILL PLATE

- 10d COMMON NAILS: JOIST HANGER TO HEADER CONNECTION.

- 8d CEMENT COATED SINKERS: SUBFLOORING, METAL BANDING, BRIDGING, ETC.

- 1 1/2" GALV. JOIST HANGER NAILS: A35Z ANCHORS AND JOIST HANGER TO JOIST CONNECTION.

1st FLOOR FRAMING GENERAL NOTES

- GENERAL SPECIFICATONS : SEE COVERSHEET.

MATERIALS TO BE SUPPLIED BY TLH.

- **DETAILS**: REFER TO APPLICABLE DETAILS FOR 1ST FLOOR FRAMING INFORMATION

- FLOOR FRAMING: JOISTS DOUBLED UNDER PARTITION WALLS ABOVE

- STAIR OPENING: (2) 2X JOISTS REQUIRED AROUND STAIR OPENING


- OWNER SUPPLIED FLOOR SYSTEMS : A SOLID/SUBSTANTIAL PERIMETER BOX IS REQUIRED TO RECEIVE THE 3/8X12" LAG UTILIZED FOR CONNECTION OF 1st LOG ROW TO THE SUBFLOOR SYSTEM, AS WELL AS PROVIDING THE REQUIRED SUPPORT FOR THE LOG WALL SYSTEM ABOVE.

- **DETAILS**: ALL DETAIL REFERENCES NOT NOTED ARE FOUND WITHIN THE DETAIL SHEETS AND TIMBERHAVEN CONSTRUCTION MANUAL. PLEASE REFER TO THE OTHER SHEETS AND MANUAL, TYPICAL.

- MATERIALS INCLUDED : ALL DETAILS PERTAINING TO MATERIAL NOT SUPPLIED BY TLH MUST BE VERIFIED PRIOR TO ACTUAL CONSTRUCTION. SEE APPROPRIATE QUOTE AND ALL APPLICABLE CHANGE ORDERS FOR


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RESIDENCE FOR:
NATHAN & ALISON NICHOLAS - PLUS PUU
PLAN NAME:
FIRST FLOOR FRAMING PLAN

PRELIMINARY DATES: 3/19/21	FINAL PRELIM. DATES:	FINAL DATES: 7/27/21
drawn by: WRZR	DRAWN BY:	drawn by: WRZR
FINAL REV. DATES:	MODEL:	SCALE: $1/4$ " = $1'-0$ "
DRAWN BY:	CUSTOM	PROJ. NO
SALES REP. / DEALER: TILI		dwg. no. TLH-10454
ľ Tarana I LM	SHEET NO. 5 OF 11	

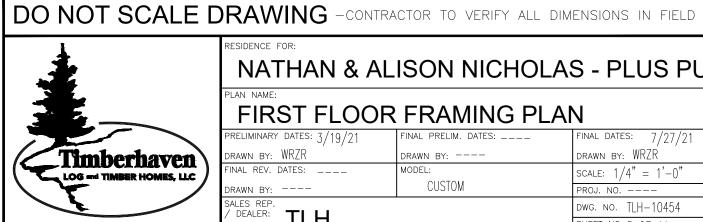

PORCH/DECK FASTENERS

- 5/8" x 6" GALV. BOLT : LEDGER BOARD TO PERIMETER BOX CONNECTION

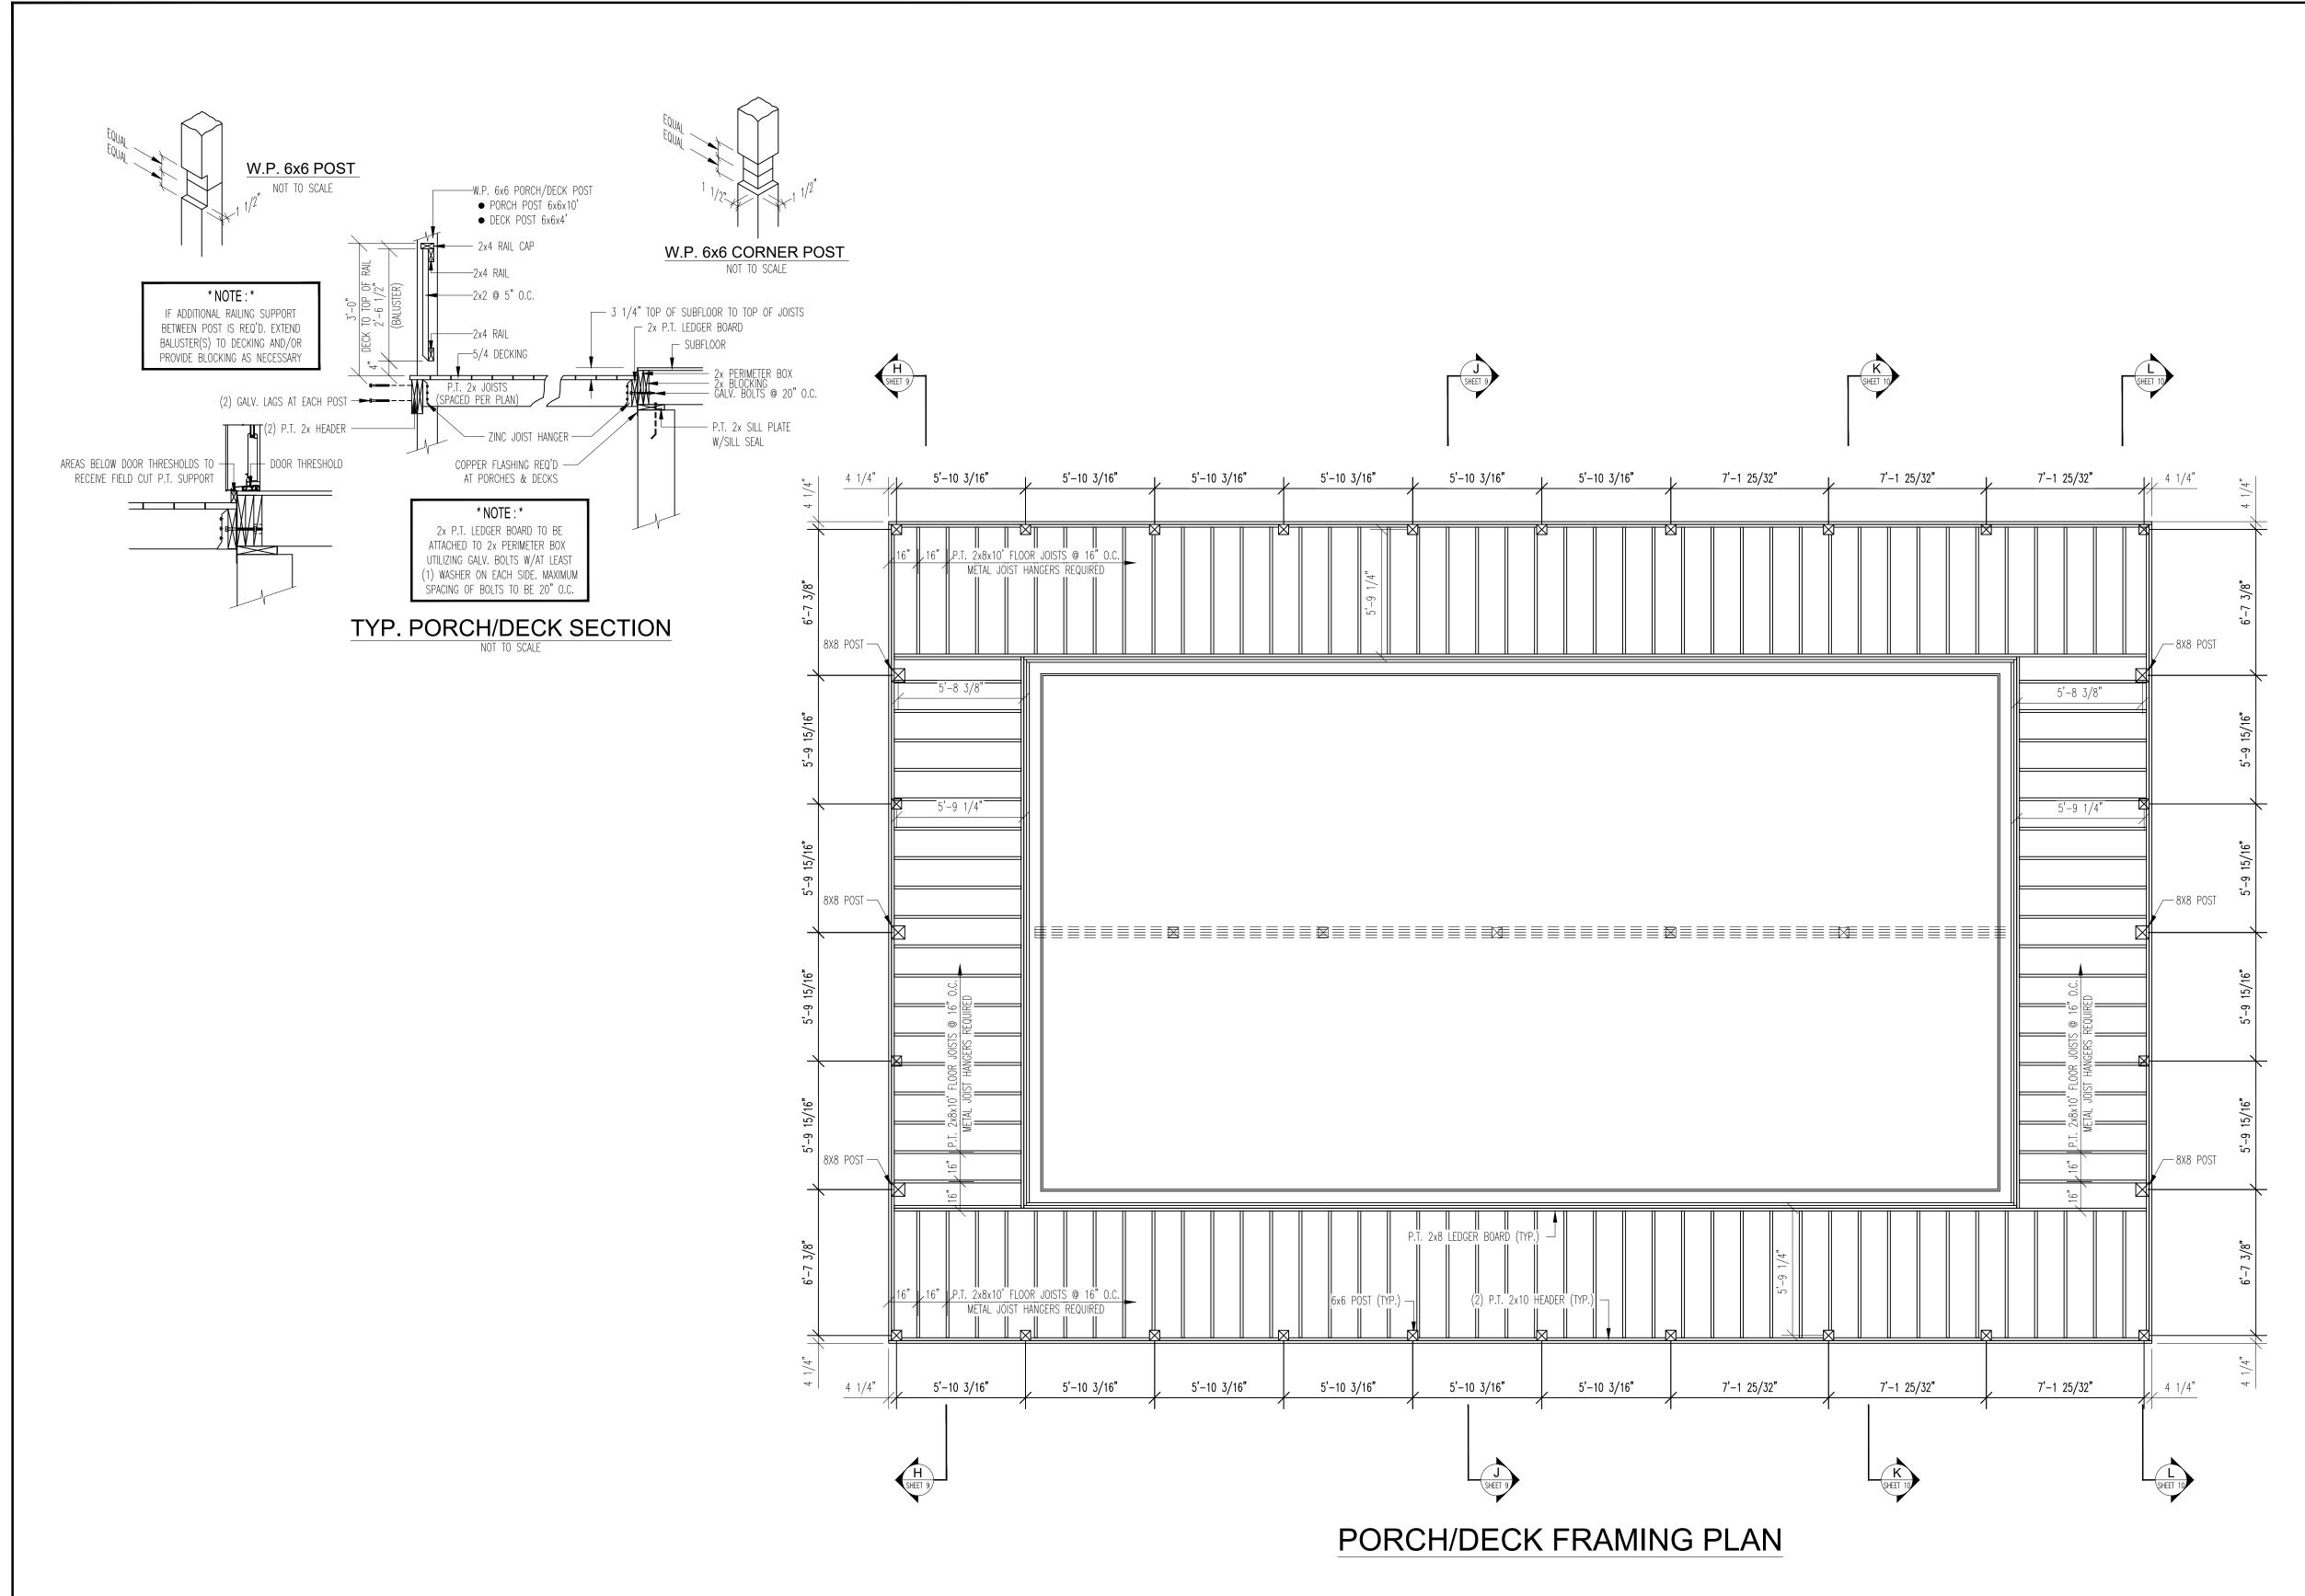- <u>3/8"x 5" GALV. LAGS</u>: DOUBLE 2x HEADER TO POST CONNECTIONS

- <u>2" DECK SCREWS</u>: 5/4 DECKING

- 16d ARDOX NAILS : ACQ CONVENTIONAL FRAMING

- 10d COMMON GALV. NAIL: JOIST HANGER TO HEADER AND JOIST CONNECTIONS

- <u>1 1/2" GALV. JOIST HANGER NAILS</u>: A35Z ANCHORS

- 16d GALV. FINISH NAILS : RAILING


- 8d GALV. FINISH: SOFFIT, 1x8 T&G CEILING PANELING, BALUSTERS, ETC.

- 10" TIMBER SCREWS : PORCH POST ANGLE BRACES

- 3" DECK SCREWS : 2x6 DECKING

- 3/8"x 12" GALV. LAGS : HEAVY TIMBER PORCH HEADERS TO POST CONNECTIONS


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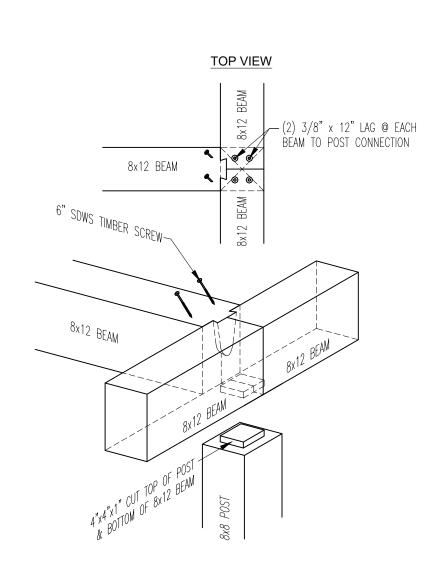
PORCH/DECK FRAMING PLAN

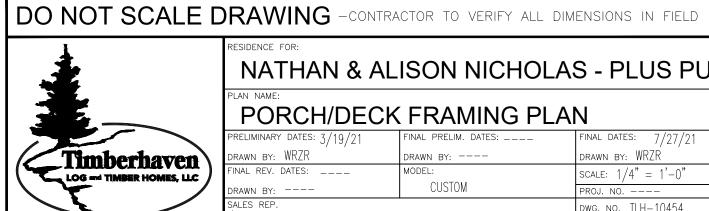NATHAN & ALISON NICHOLAS - PLUS PUU


FINAL DATES: 7/27/21 DRAWN BY: WRZR SCALE: 1/4" = 1'-0" DWG. NO. TLH-10454 SHEET NO. 6 OF 11



NOT TO SCALE

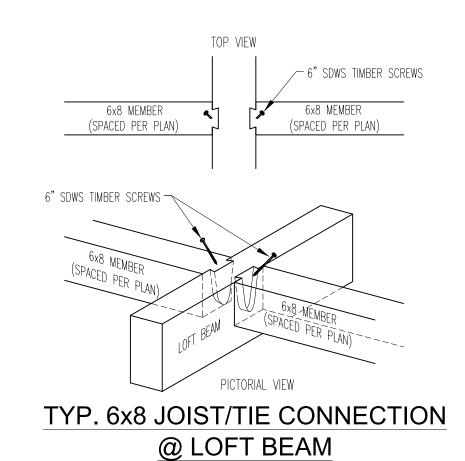


TYP. 8x12 BEAM
CONNECTION @ 8x8 POST
NOT TO SCALE

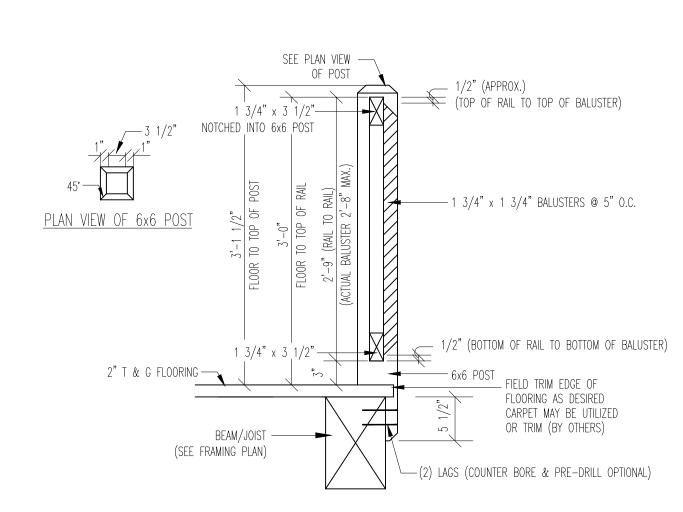


TYP. HANDRAIL DETAIL

@ STAIRS & LOFT

NOT TO SCALE

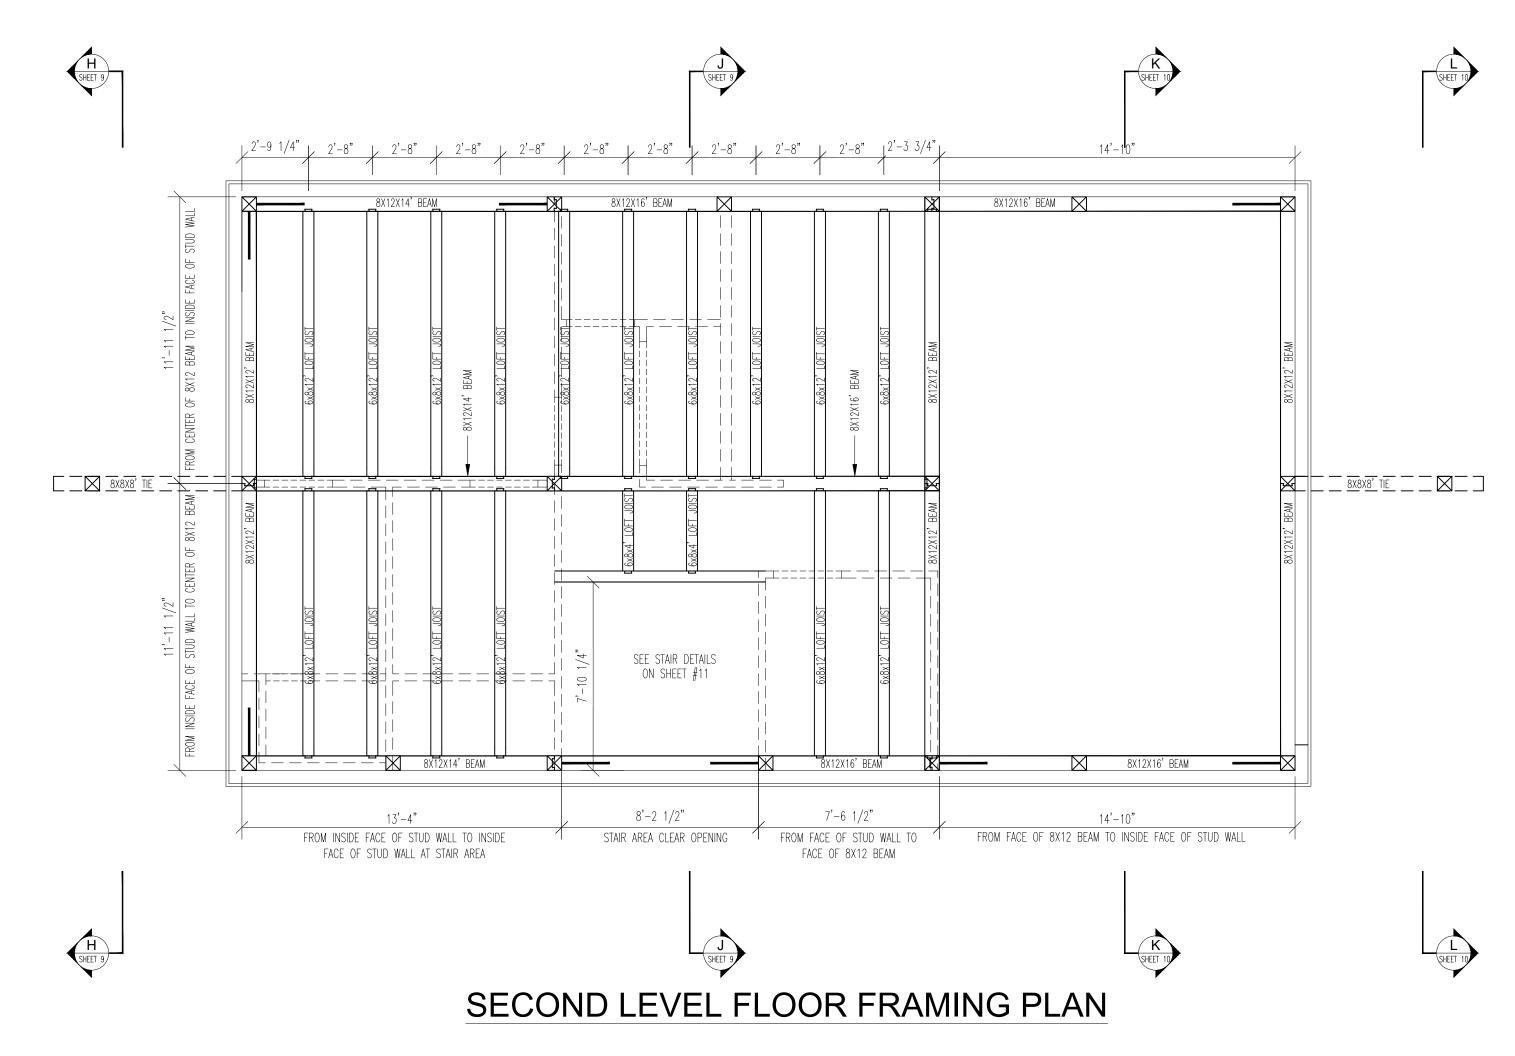

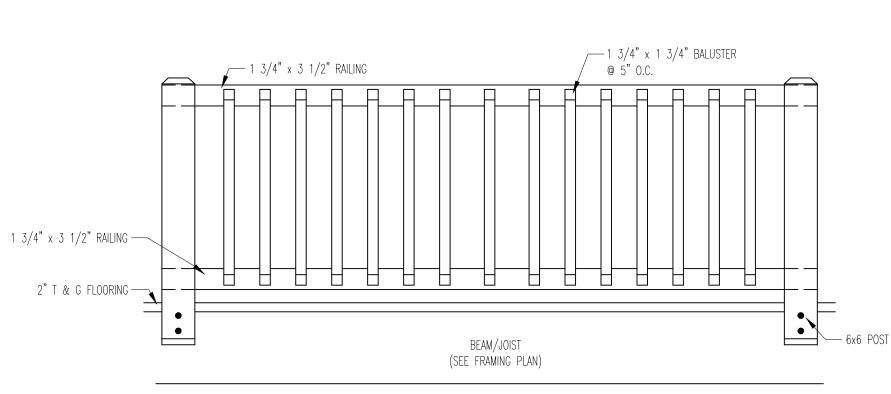

HANDRAIL SCHEMATIC

NOT TO SCALE

HEAVY TIMBER LOFT FLOOR SYSTEM FASTENERS

- <u>3/8" x 12" LAGS</u>: 8x12 AND/OR GLU-LAM BEAMS TO 8x12 AND/OR GLU-LAM BEAMS, 8x12 AND/OR GLU-LAM BEAMS TO POST CONNECTIONS, 6X8 JOISTS TO LOG WALL (REFER TO 6X8 JOIST TO LOG WALL DETAIL)

- 3/8" X 10" LAGS : 6x8/8" ROUND LOFT JOIST TO INTERIOR & EXTERIOR FRAMED WALL CONNECTIONS, LOG WALL

- 3/8" X 8" LAGS : 6x8 JOISTS TO LOG WALL (FASTENED FROM LOG TOWARD JOIST REFER TO 6x8 JOIST TO LOG

3/4" x 7" HEX BOLTS : BH68 HANGER TO 6x8 JOIST CONNECTION

- <u>3/4" x 3" LAGS</u> : BH68 HANGER TO BEAM CONNECTION OR RAFTER CONNECTIONS

• 16d CEMENT COATED SINKERS : 2x6 T&G FLOORING

- 8d CEMENT COATED SINKERS : 1x8 T&G (COMPOSITION FLOORING), METAL BANDING, ETC.

- 1 1/4" DRYWALL SCREW : SUBFLOORING

2nd FLOOR FRAMING GENERAL NOTES


- **GENERAL SPECIFICATONS** : SEE COVERSHEET.

- **DETAILS**: REFER TO APPLICABLE DETAILS FOR 2ND FLOOR FRAMING INFORMATION

 $\underline{\textbf{BROKEN LINES}}: \mathsf{BROKEN LINES INDICATE PARTITION WALLS BELOW}$

- <u>DETAILS</u>: ALL DETAIL REFERENCES NOT NOTED ARE FOUND WITHIN THE DETAIL SHEETS AND TIMBERHAVEN CONSTRUCTION MANUAL. PLEASE REFER TO THE OTHER SHEETS AND MANUAL, TYPICAL.

MATERIALS INCLUDED: ALL DETAILS PERTAINING TO MATERIAL NOT SUPPLIED BY TLH MUST BE VERIFIED PRIOR TO ACTUAL CONSTRUCTION. SEE APPROPRIATE QUOTE AND ALL APPLICABLE CHANGE ORDERS FOR MATERIALS TO BE SUPPLIED BY TLH.

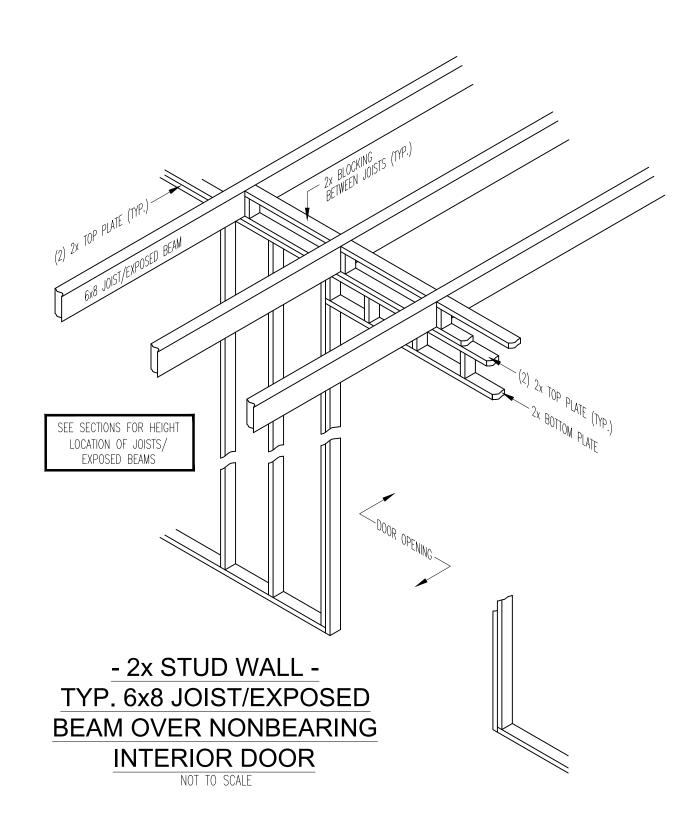

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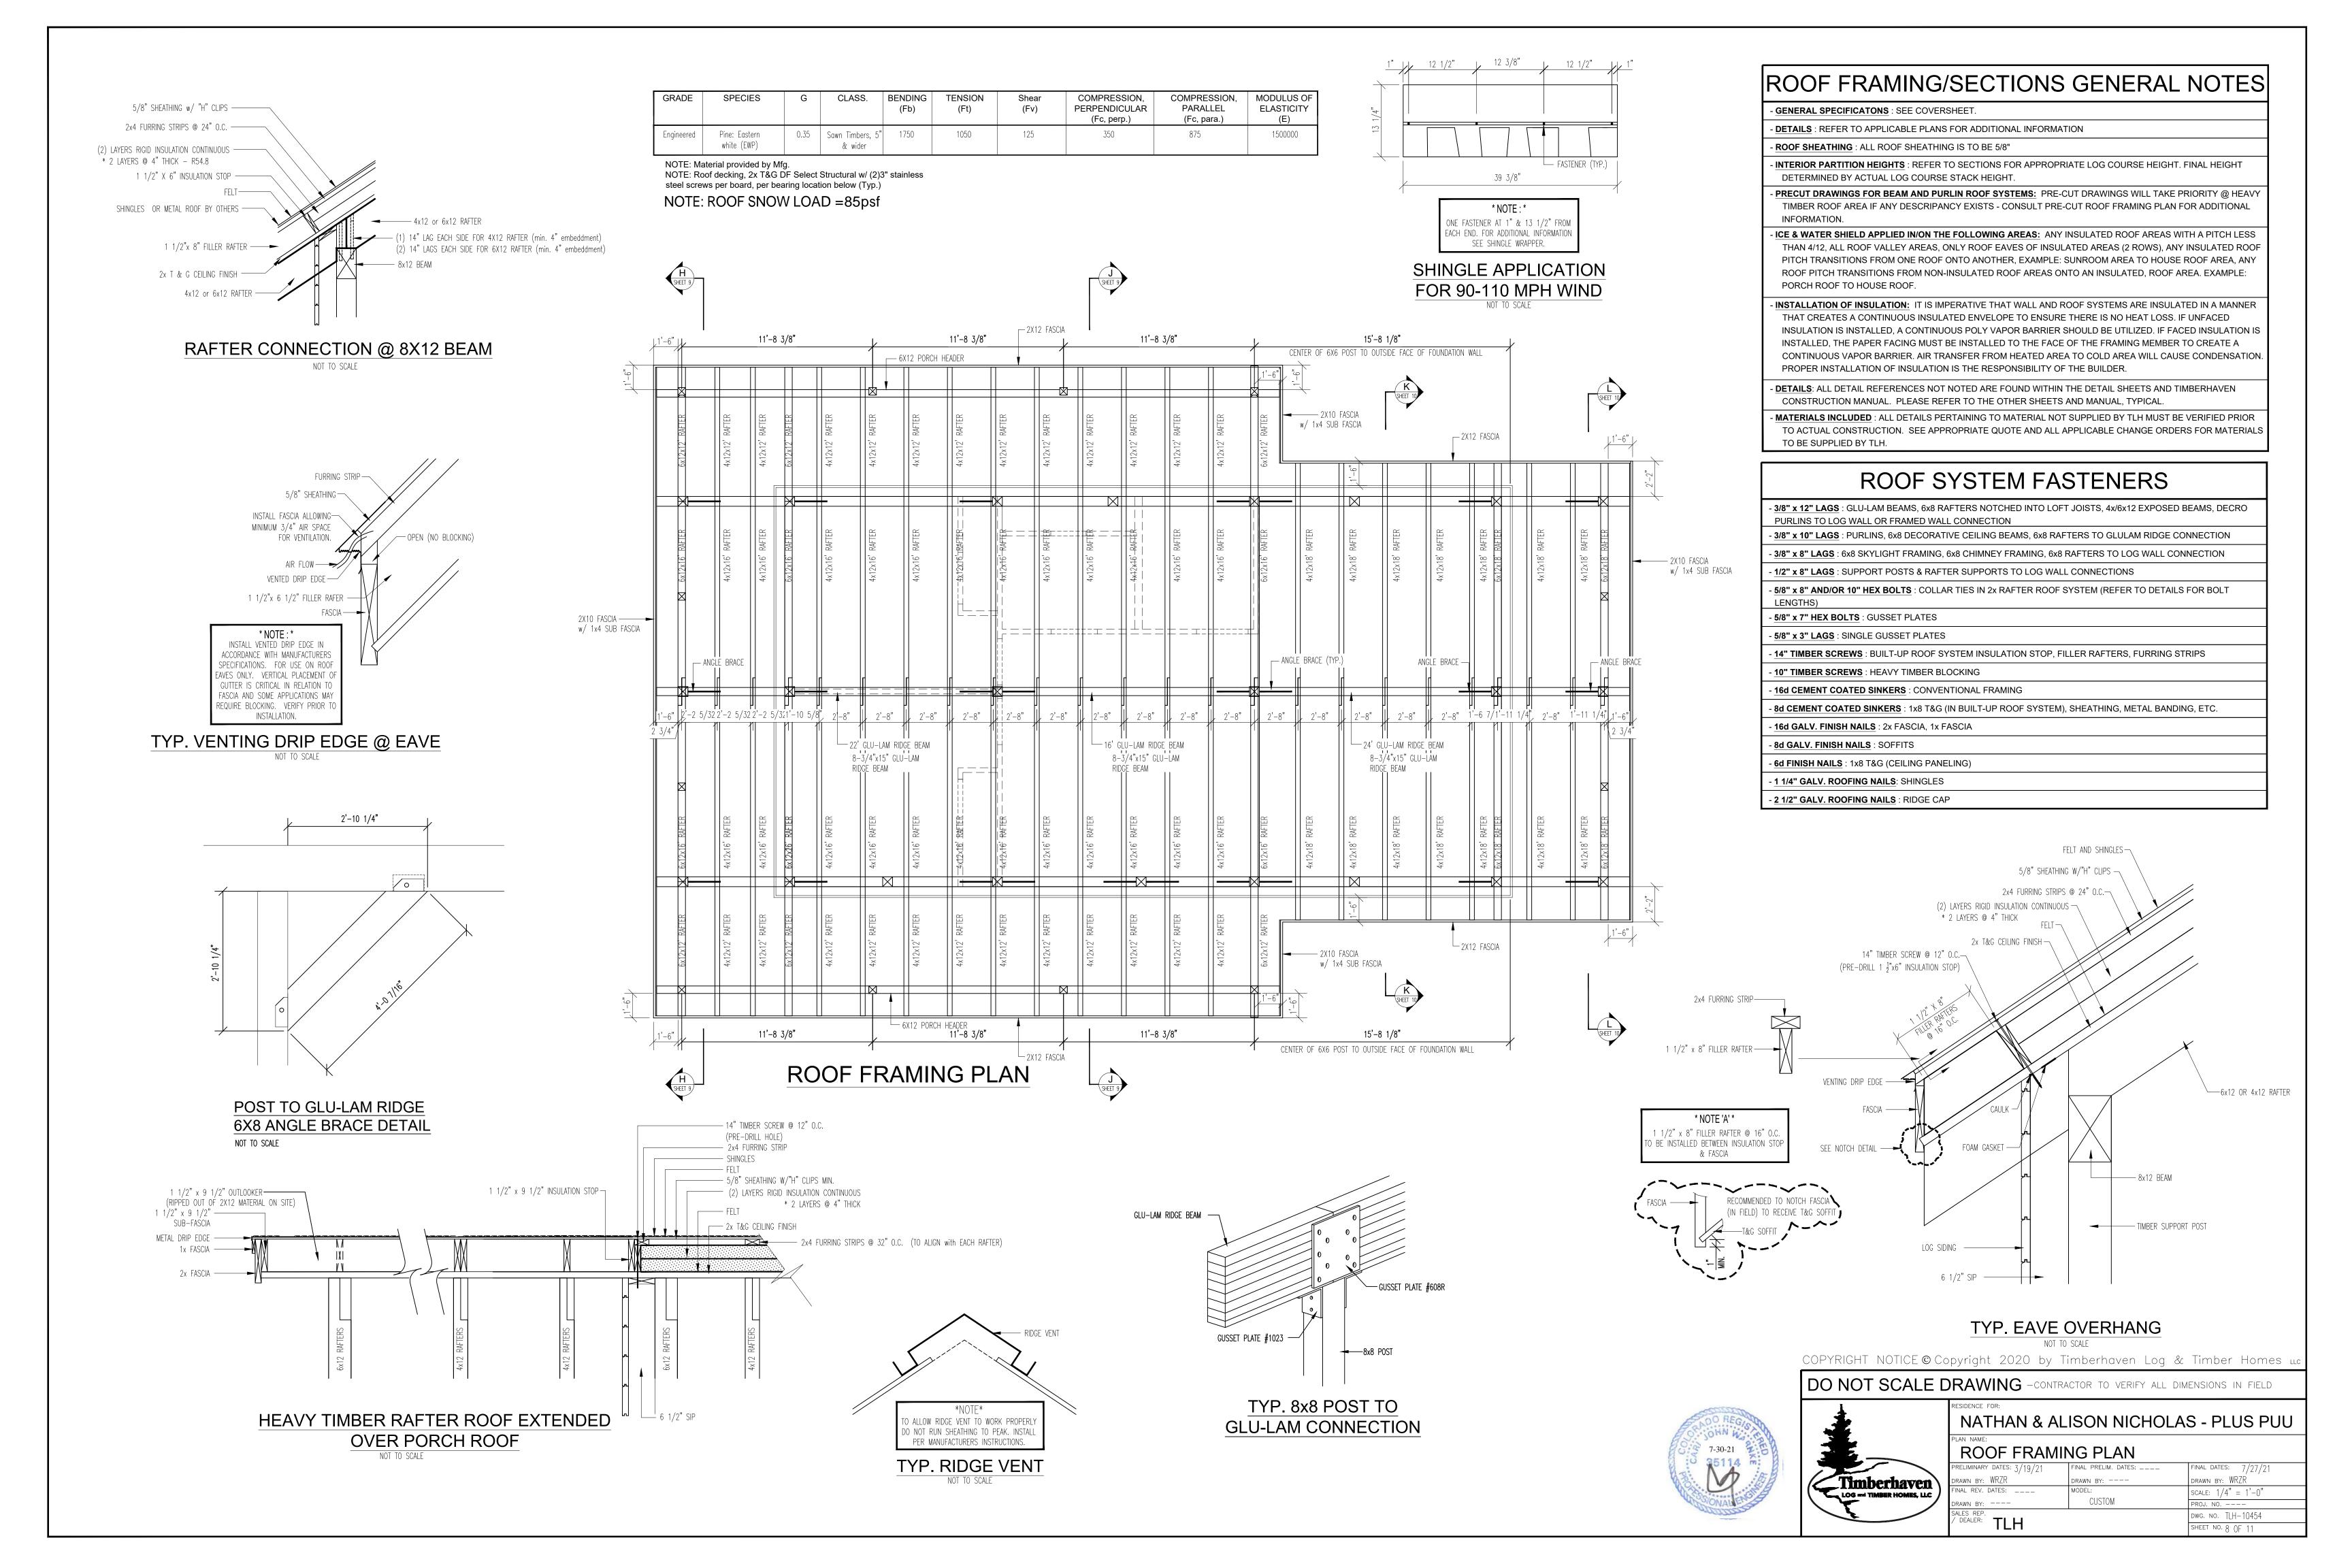
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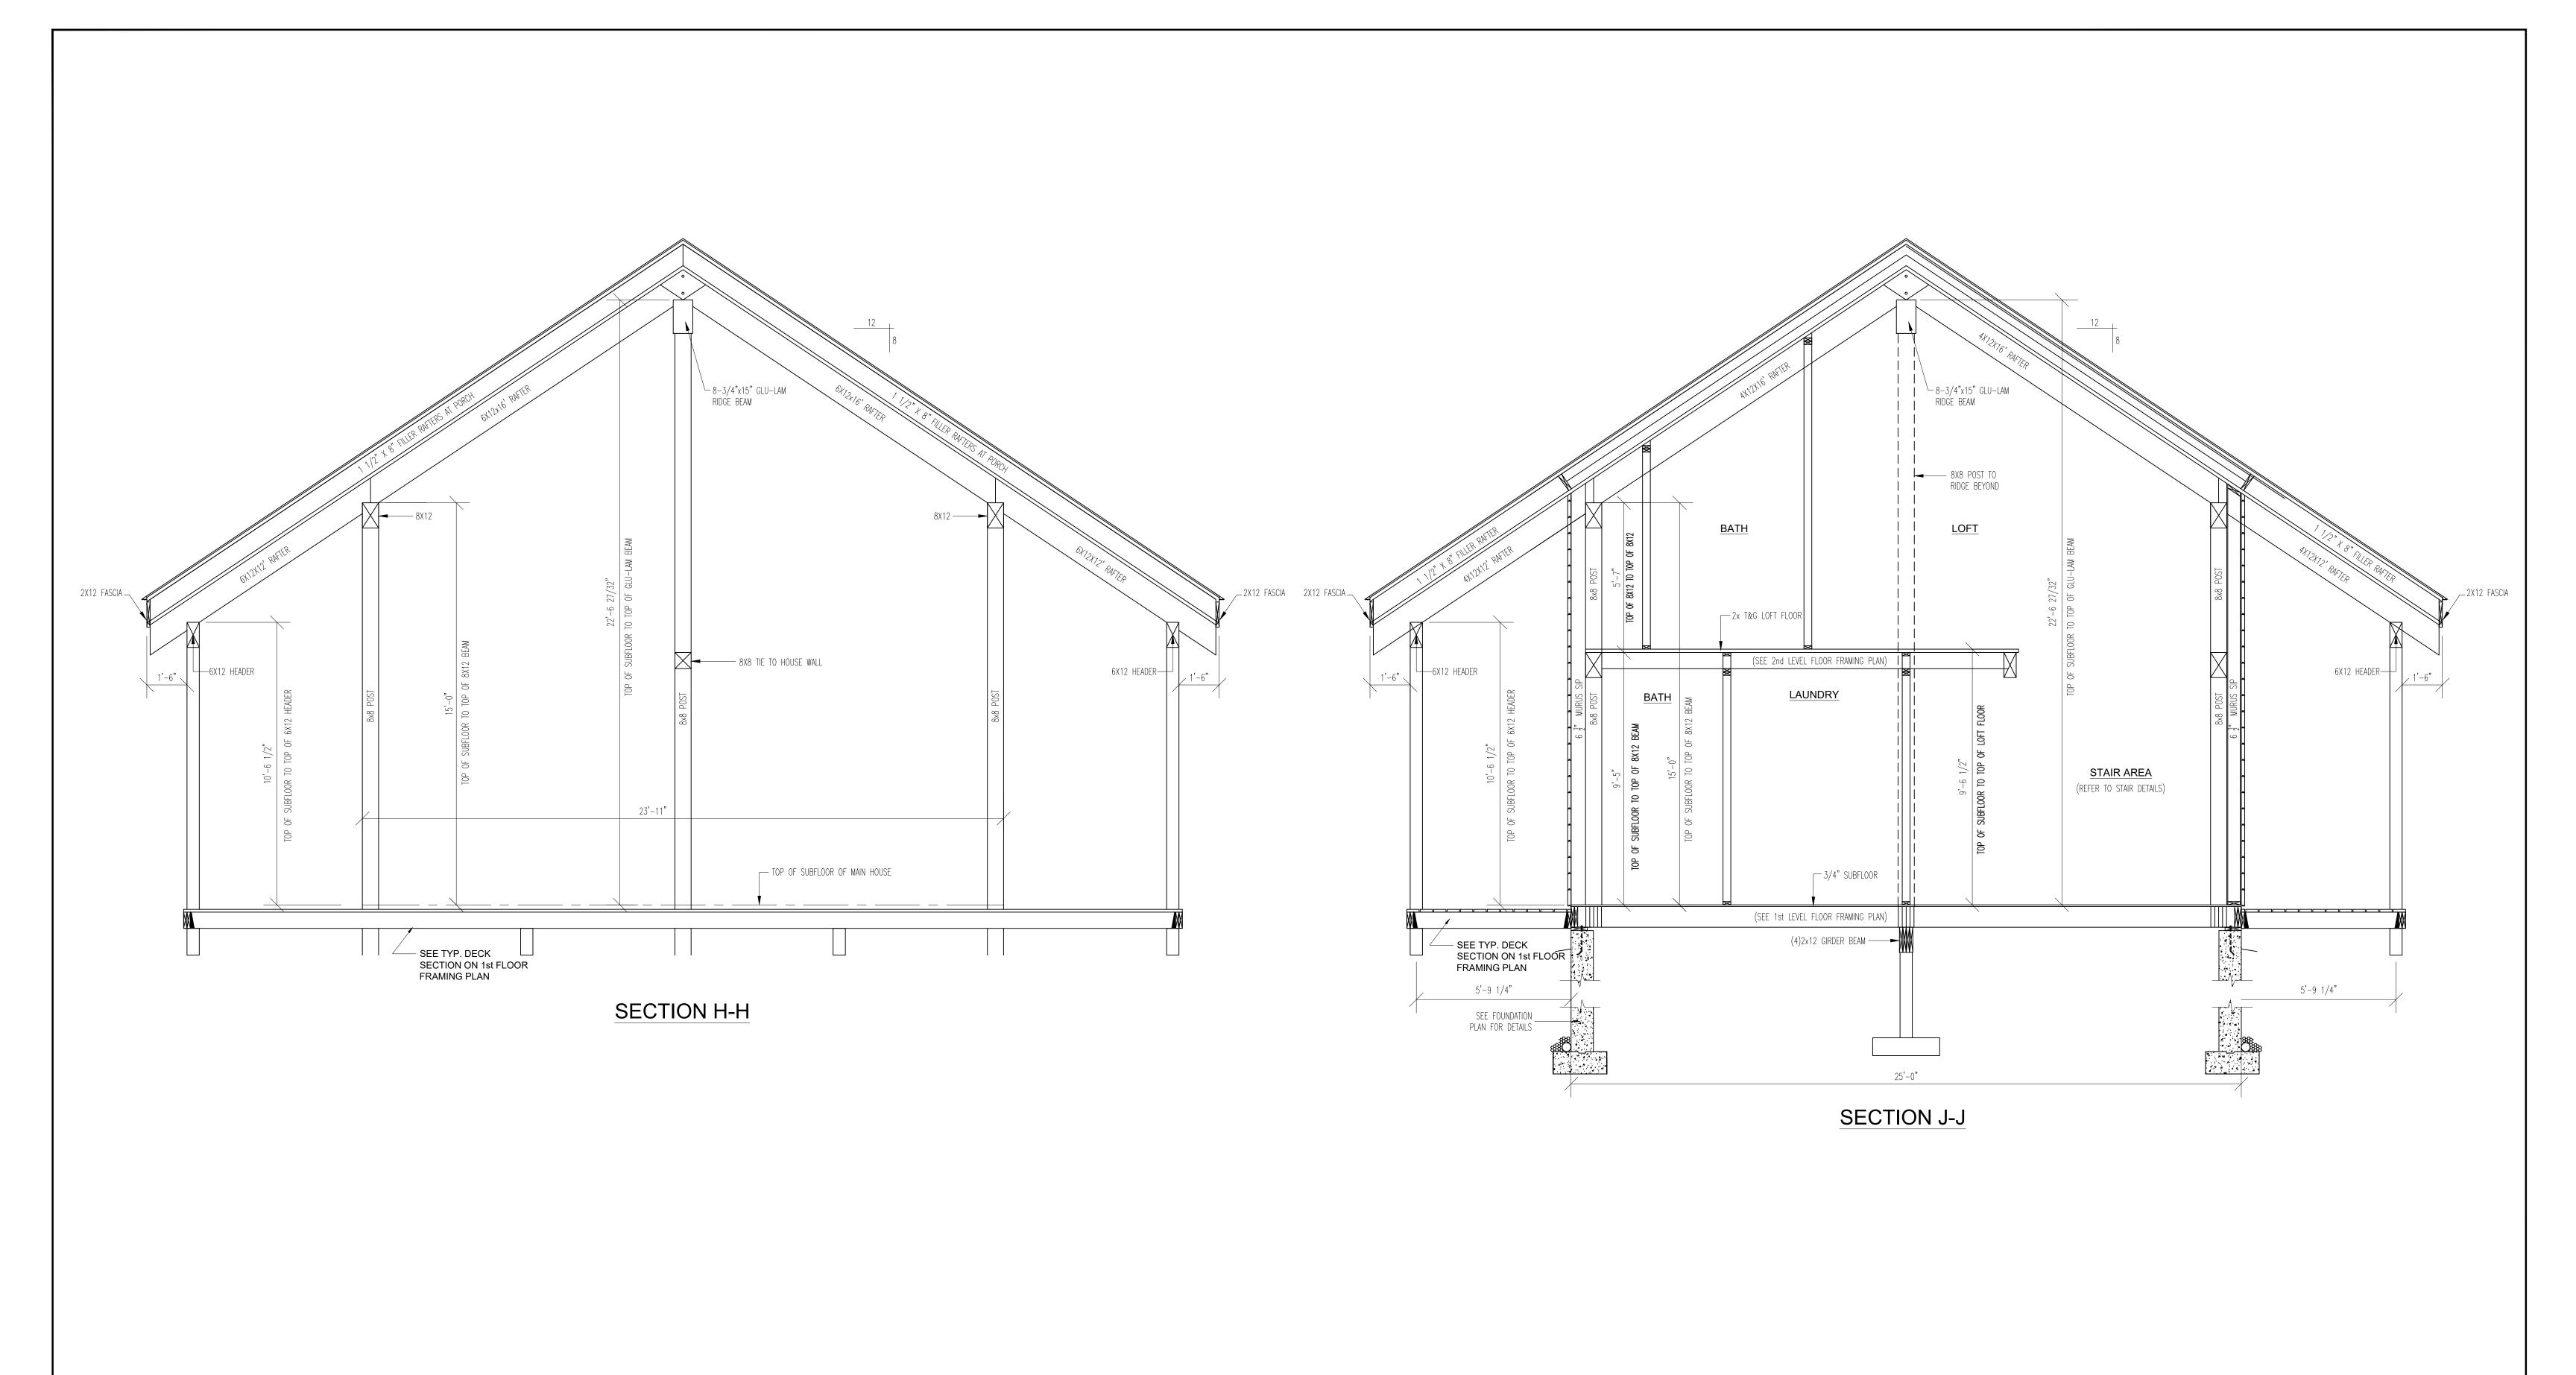




NATHAN & ALISON NICHOLAS - PLUS PUU PLAN NAME: SECOND FLOOR FRAMING PLAN

PRELIMINARY DATES: 3/19/21	FINAL PRELIM. DATES:	FINAL DATES: 7/27/21
drawn by: WRZR	DRAWN BY:	drawn by: WRZR
FINAL REV. DATES:	MODEL:	SCALE: $1/4" = 1'-0"$
DRAWN BY:	CUSTOM	PROJ. NO
SALES REP. / DEALER: TIL	DWG. NO. TLH-10454	
I' STATE I LM		SHEET NO. 7 OF 11





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L	RESIDENCE FOR:
	NATHA
	SECTION NAME:
	PRELIMINARY DATES:
Timberhaven	drawn by: WRZR
LOG and TIMBER HOMES, LLC	FINAL REV. DATES:
	DRAWN BY:
	SALES REP.


NATHAN & ALISON NICHOLAS - PLUS PUU				
SECTIONS				
PRELIMINARY DATES: 3/19/21	FINAL PRELIM. DATES:	FINAL DATES: 7/27/21		
DRAWN BY: WR7R	DRAWN BY:	DRAWN BY: WR7R		


DRAWN BY: WRZR

SCALE: 1/4" = 1'-0"

PROJ. NO. ---
DWG. NO. TLH-10454

SHEET NO. 9 OF 11 CUSTOM

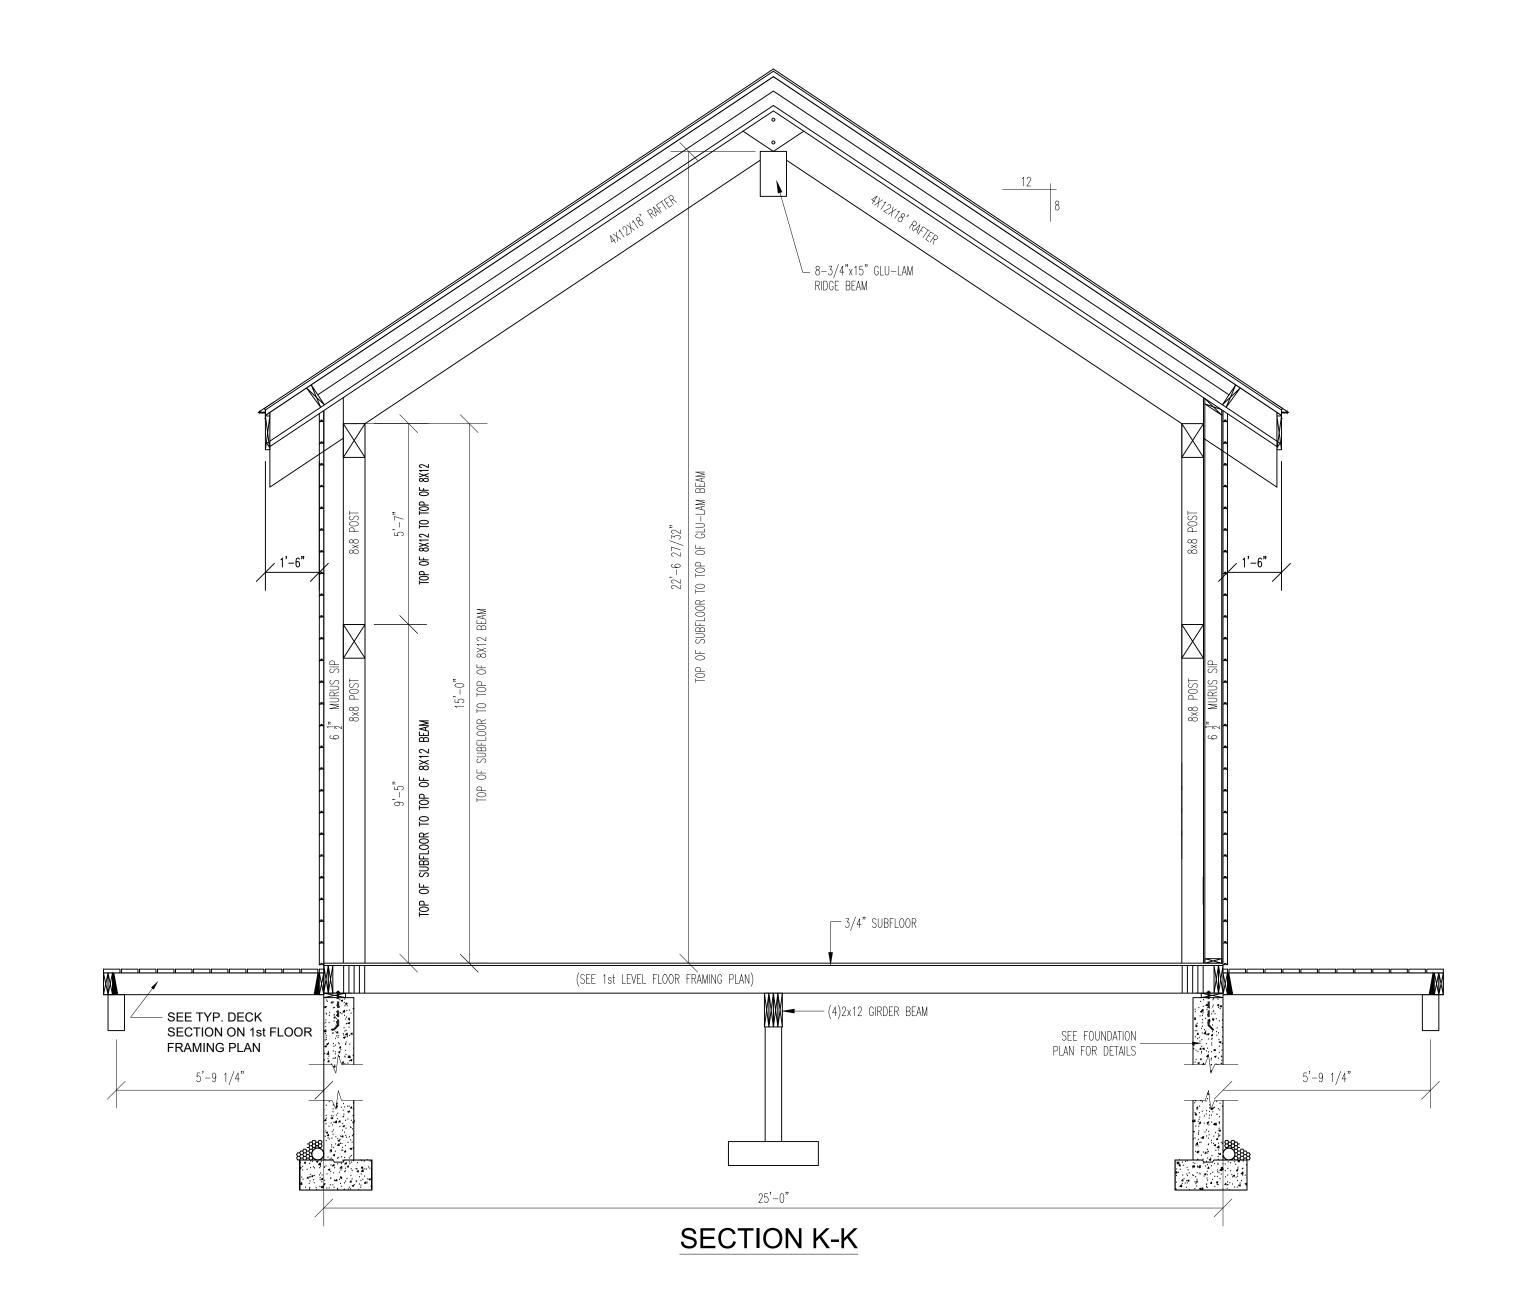

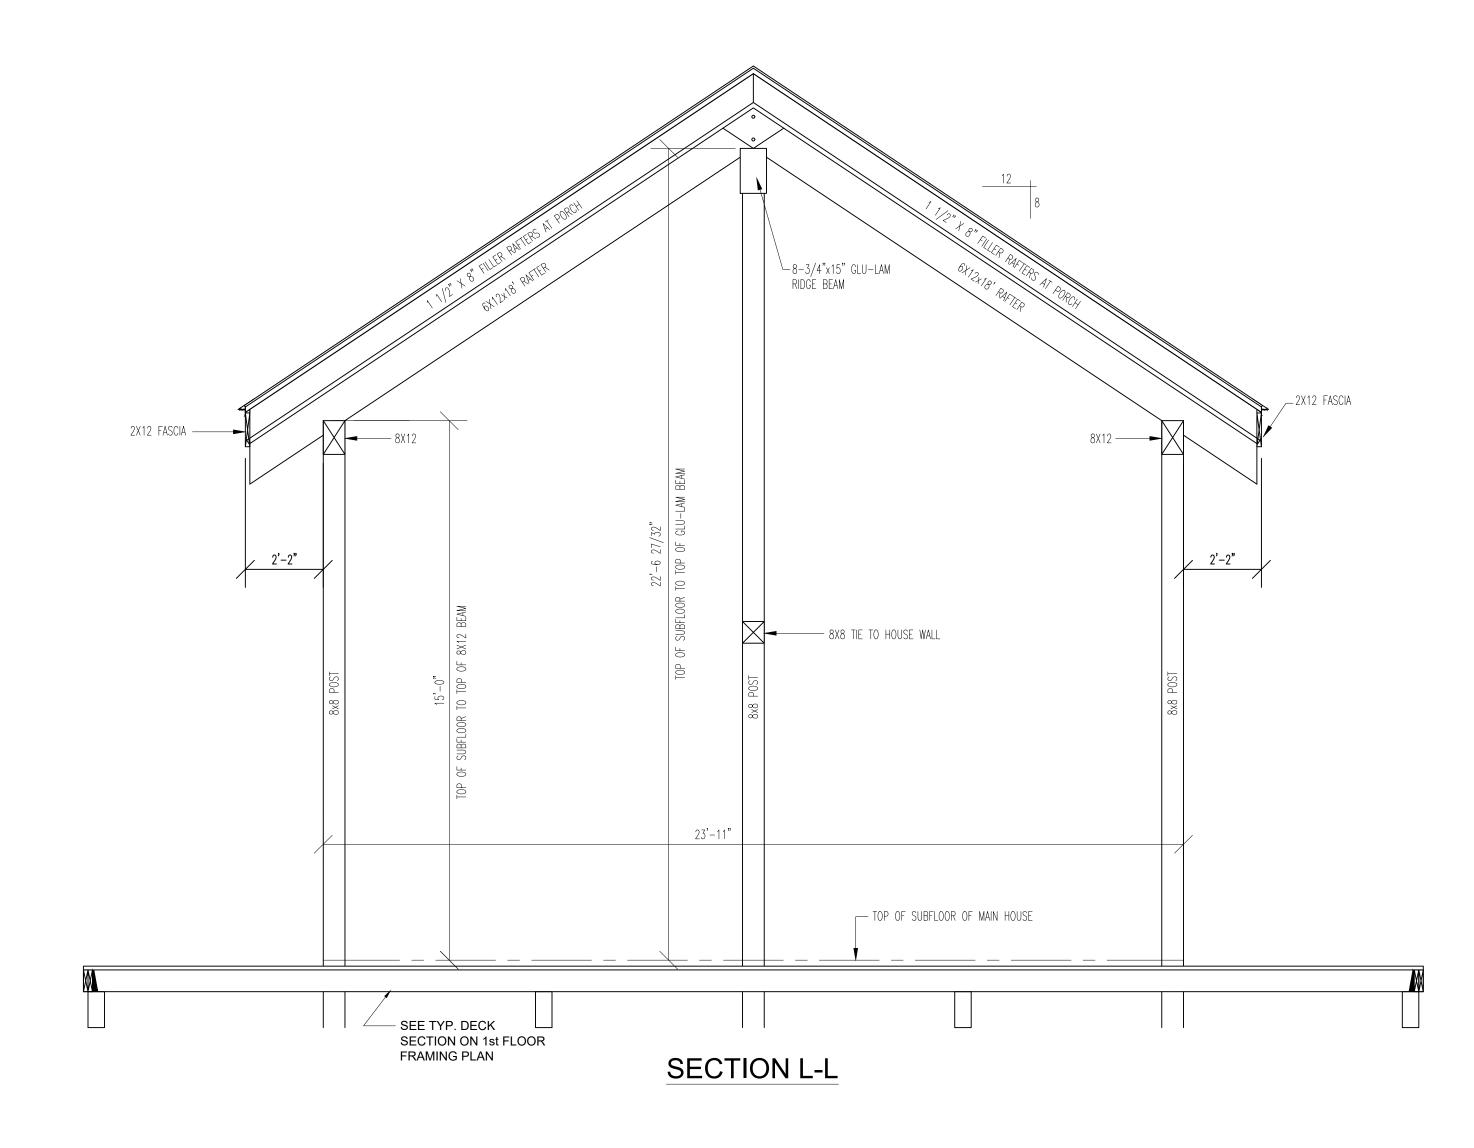



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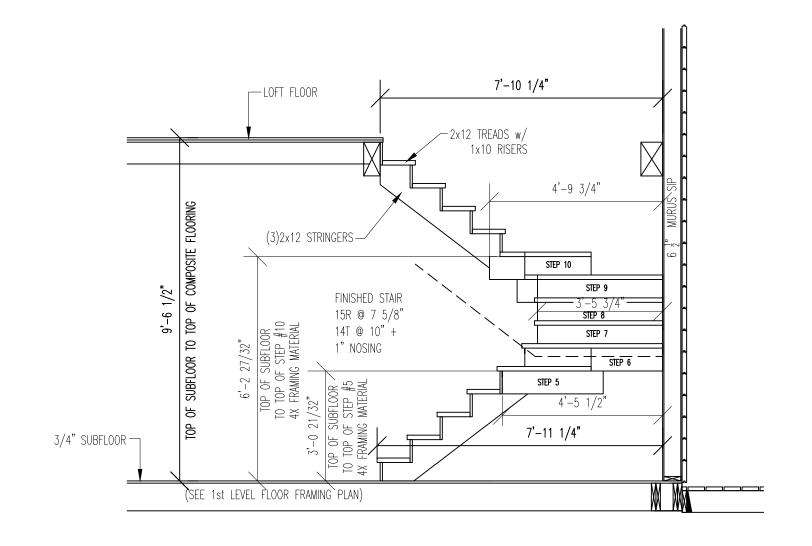
Timberhaven
LOG and TIMBER HOMES, LLC

		IOON MICHOLA	0 - 1 L00 1 C
	PLAN NAME:		
	SECTIONS		
	PRELIMINARY DATES: 3/19/21	FINAL PRELIM. DATES:	FINAL DATES: 7/27/21
\	drawn by: WRZR	DRAWN BY:	drawn by: WRZR
)	FINAL REV. DATES:	MODEL:	SCALE: $1/4$ " = 1'-0"
	DRAWN BY:	CUSTOM	PROJ. NO
	SALES REP. / Dealer: TIL		dwg. no. TLH-10454
	ILM		SHEET NO. 10 OF 11



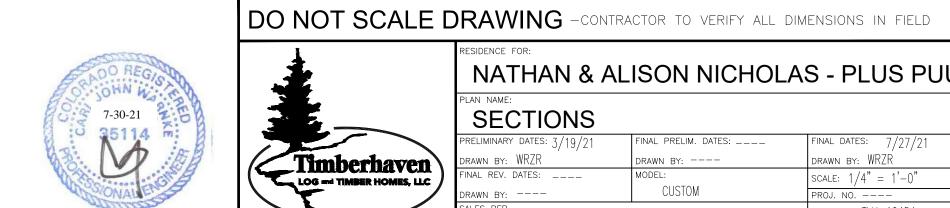


PLAN VIEW STAIRS TO 2ND LEVEL

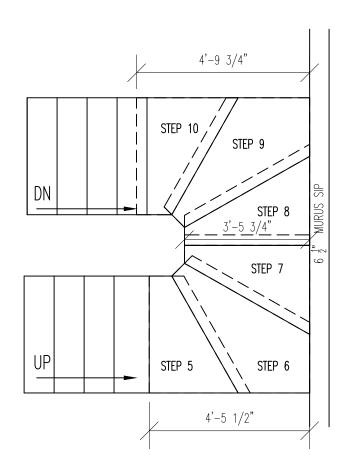


STAIR DETAIL SIDE VIEW

* WINDER TREADS RECEIVE 2X6 T&G FLOOR FINISH * * WINDER TREADS FRAMED w/ 4X12 W.P. MATERIAL AND RIPPED TO HEIGHT AS REQ'D IN FIELD *

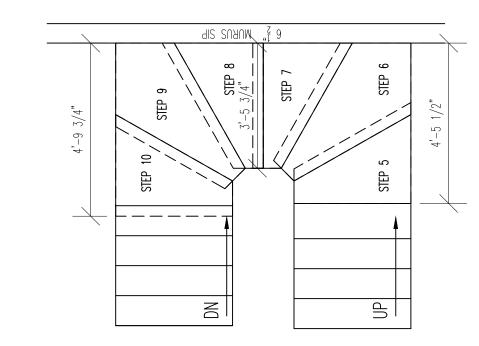

PLAN VIEW STAIRS TO 2ND LEVEL

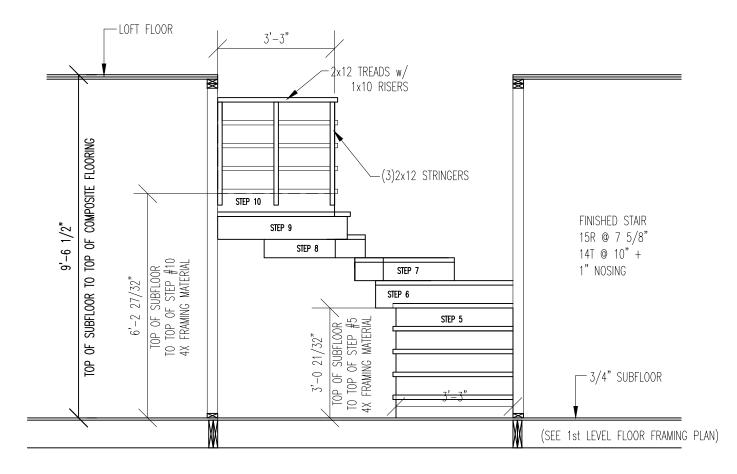

STAIR DETAIL FRONT VIEW

* WINDER TREADS RECEIVE 2X6 T&G FLOOR FINISH * * WINDER TREADS FRAMED w/ 4X12 W.P. MATERIAL AND RIPPED TO HEIGHT AS REQ'D IN FIELD *

STAIR FASTENERS


- 3/8" x 8" LAGS: (SPIRAL) TREAD TO POST

- 3/8" x 5 1/2" LAGS: (HEAVY TIMBER AND 1/2 LOG) STRINGERS AND TREADS, LANDING, LANDING SUPPORT POSTS, (SPIRAL) TREAD TO RAILING POST, AND 6x6 AND 8" ROUND RAILING POSTS

- 3/8" x 3" LAGS: (FINISHED AND BASEMENT) LANDING AND SUPPORT POSTS, AND 4x4 RAILING POSTS

- 16d BRIGHT FINISH NAILS: (FINISHED AND BASEMENT) TREAD AND RISER NAILS

- 10d FINISH NAILS: RAILING AND BALUSTERS

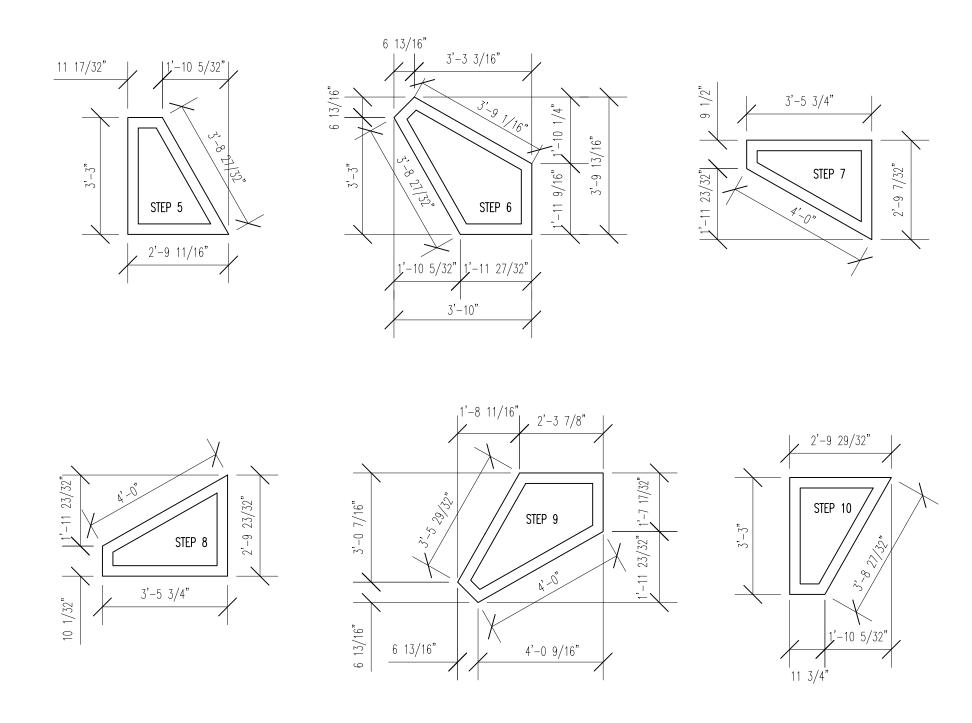

1ST LEVEL WINDER TREAD DETAILS

* WINDER TREADS RECEIVE 2X6 T&G FLOOR FINISH * st winder treads framed w/ 4x12 w.p. material and ripped to height as req'd in field st





DO NOT SCALE DRAWING - CONTRACTOR TO VERIFY ALL DIMENSIONS IN FIELD NATHAN & ALISON NICHOLAS - PLUS PUU

STAIR DETAILS

FINAL PRELIM. DATES: ____ drawn by: WRZŔ SCALE: 1/4" = 1'-0" PROJ. NO. ----DWG. NO. TLH-10454 SHEET NO. 11 OF 11

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