

SYM	BOLS		)	
$\bowtie$	WOOD IN SECTION	E,	X	
	CONCRETE IN SECTION			- ELEVATION NUMBER VIEW DIRECTION C
	SAND OR GRAVEL IN SECTION			BUILDING ELEVATIO
	STEEL IN SECTION	t.	1/	- DESCRIBES PAGE DETAIL IS ON
20000	BATT INSULATION IN SECTION	15B	15B-	- DESCRIBES DET.
	INSULATION NAILBASE IN SECTION		~	LETTER
	ARCH ROOF	1 (1		- VIEW DIRECTION SECTION DETAILS
mmn	BOARD AND BATTEN SIDING	1		POST CONNECTION T

REVISIO	ON HISTOR	Ý
REV.#	DATE:	DESCRIPTION:
0	2/9/2021	INITIAL DRAWINGS
1	02/25/2021	MODIFIED LAYOUT, ADDED FOUNDATION PLAN
2	03/15/2021	MODIFIED BATHROOMS ON FLOOR LAYOUT, REMOVED MUD ROOM WINDOW
3	04/19/2021	FINAL PLAN SET
4	04/29/2021	ENGINEER REDLINES
5	06/08/2021	PERMITTING CHANGES
6	07//08/2021	FOUNDATION CHANGE
1	00/00/2021	-
8	00/00/2021	

LOCAL BUILDING CODE SPECIFICATIONNS TAKE PRECEDENCE OVER THE STANDARD INFORMATION SHOWN IN

THESE DRAWINGS. IT IS THE RESPONSIBILITY OF THE BUYER, OR ON SITE FOUNDATION CONTRACTOR TO

AND RELATED DETAILS. FOOTINGS AND DETAILS SHOWN ARE FOR ILLUSTRATION ONLY. POST AND BEAM

FRAMED STRUCTURES TRANSMIT HEAVY CONCENTRATED LOADS THROUGH THE POSTS TO THE FOUNDATION. WE

SATISFY THE LOCAL BUILDING CODE REQUIREMENTS. SOIL CONDITION, FROSTLINE DEPTH, LOCAL CODES, HIDDEN CONDITIONS AND GRADE VARIATION TO BE BUILDERS FINAL DETERMINATION FACTOR IN SIZING OF FOOTINGS



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00/00/2021


STRUCTURAL FRAMING: DOUG FIR #1 OR BETTER


RECOMMEND FOUNDATION DESIGN TAKE THIS INTO CONSIDERATION.


FOUNDATION NOTES:

## CUSTOMER: KEELIN REGAN-REED

JOB CODE: KREI2I-I

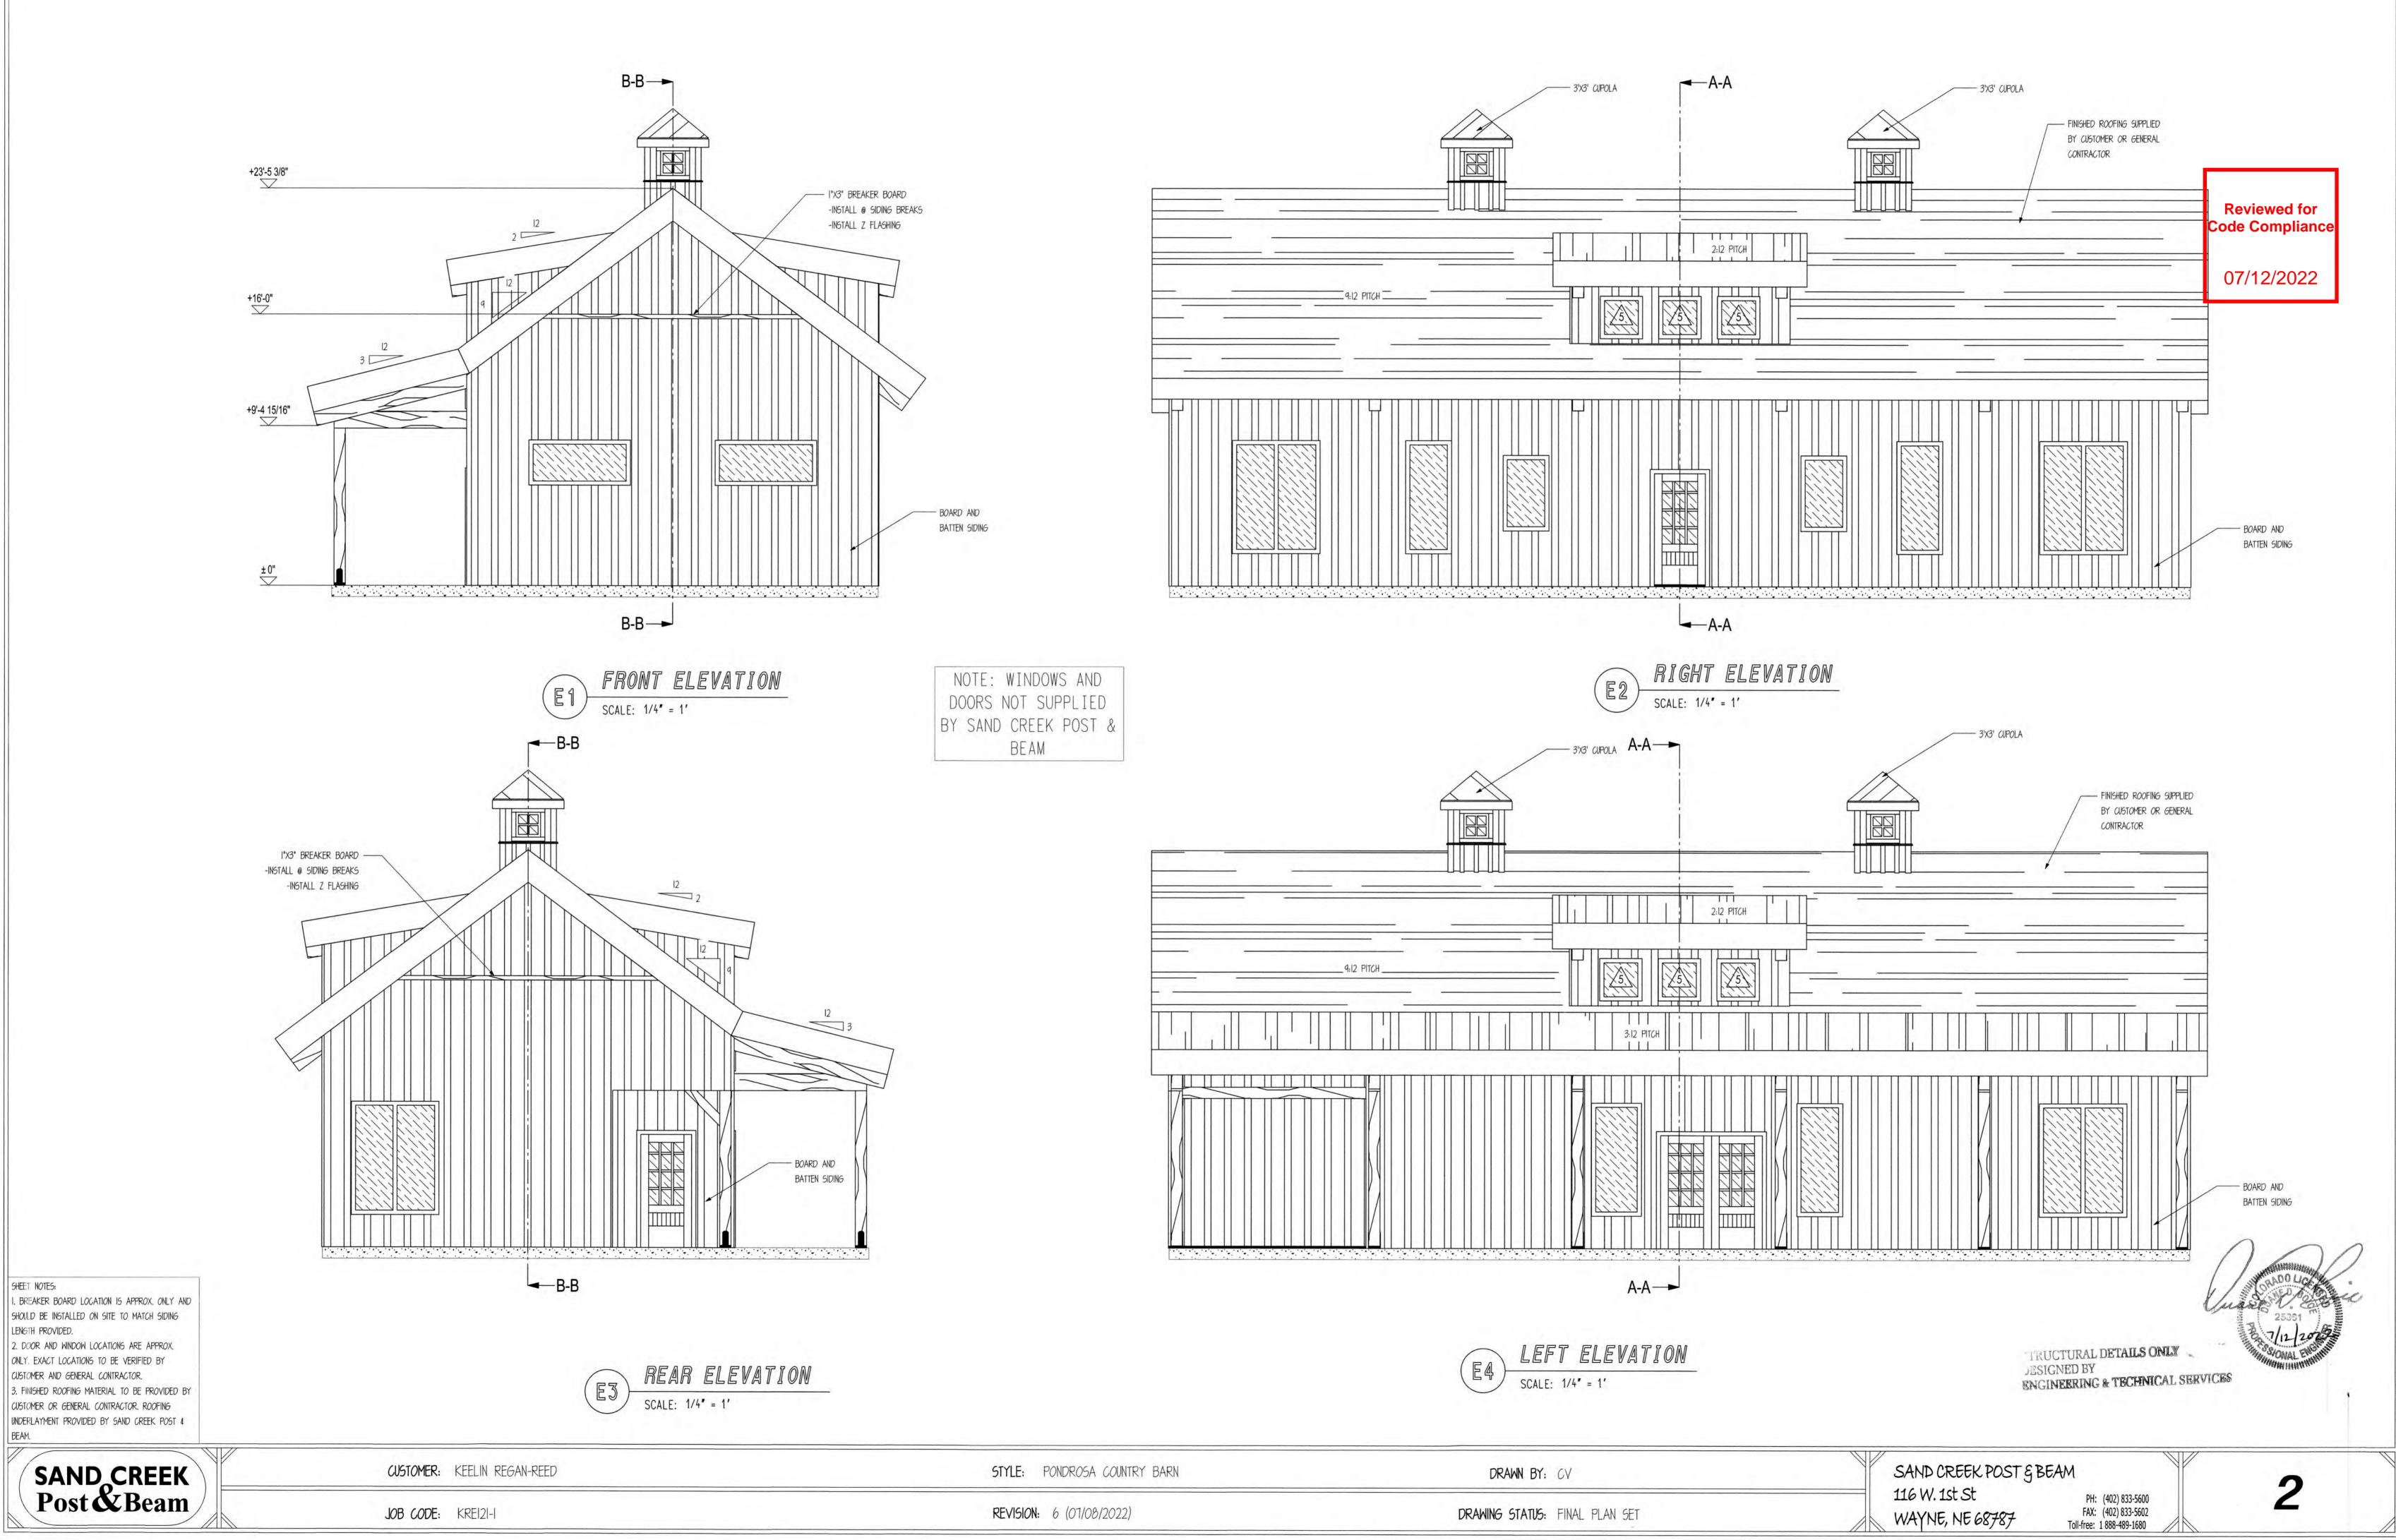

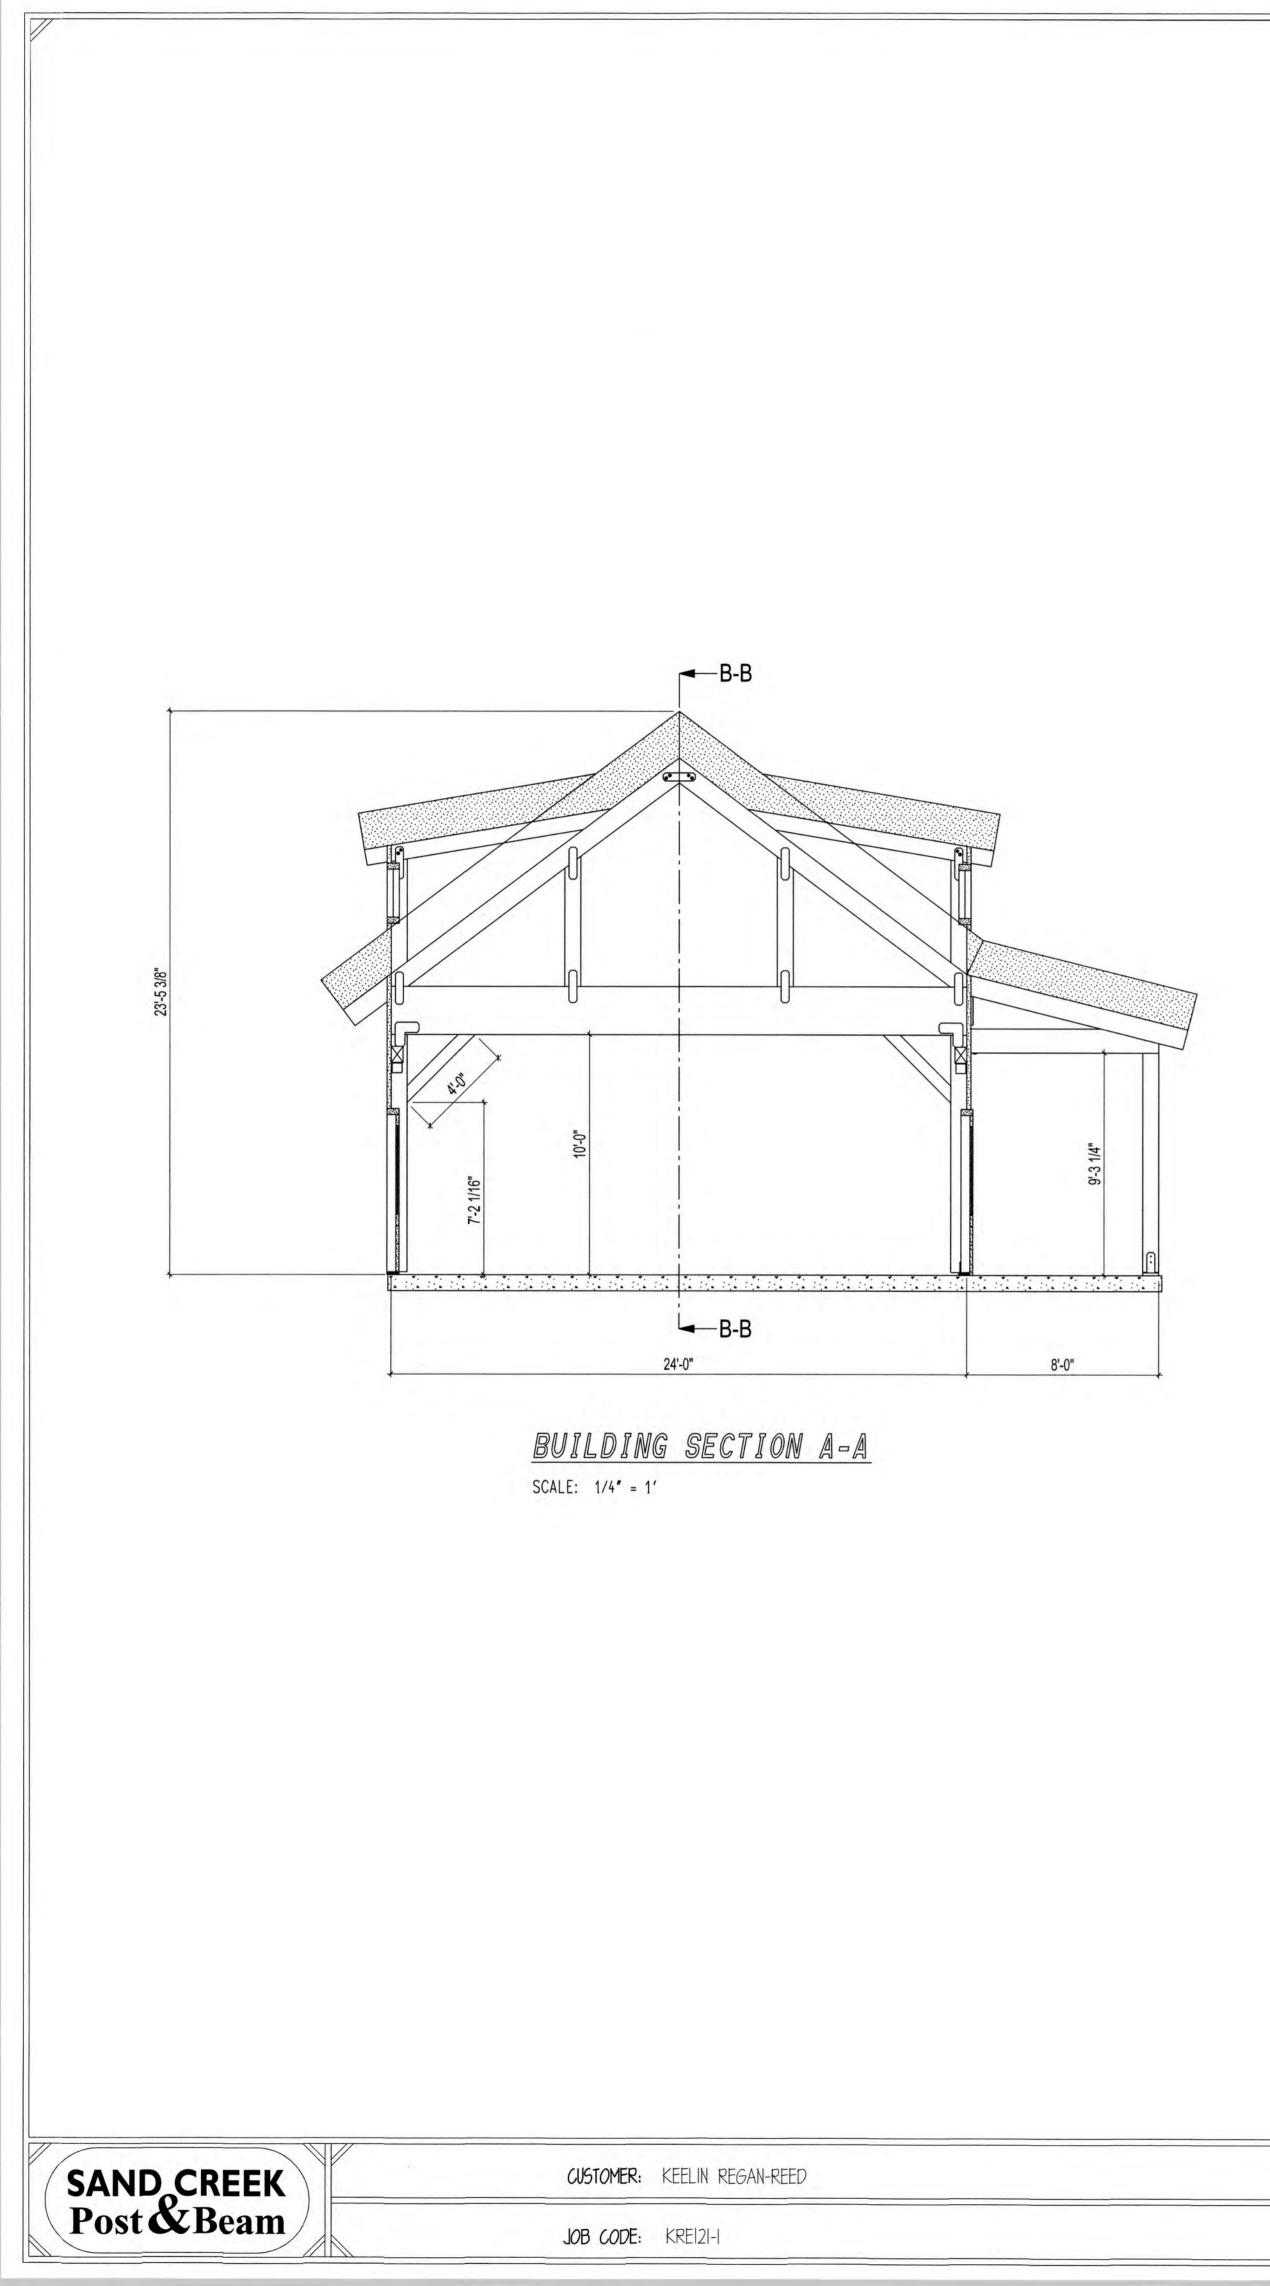

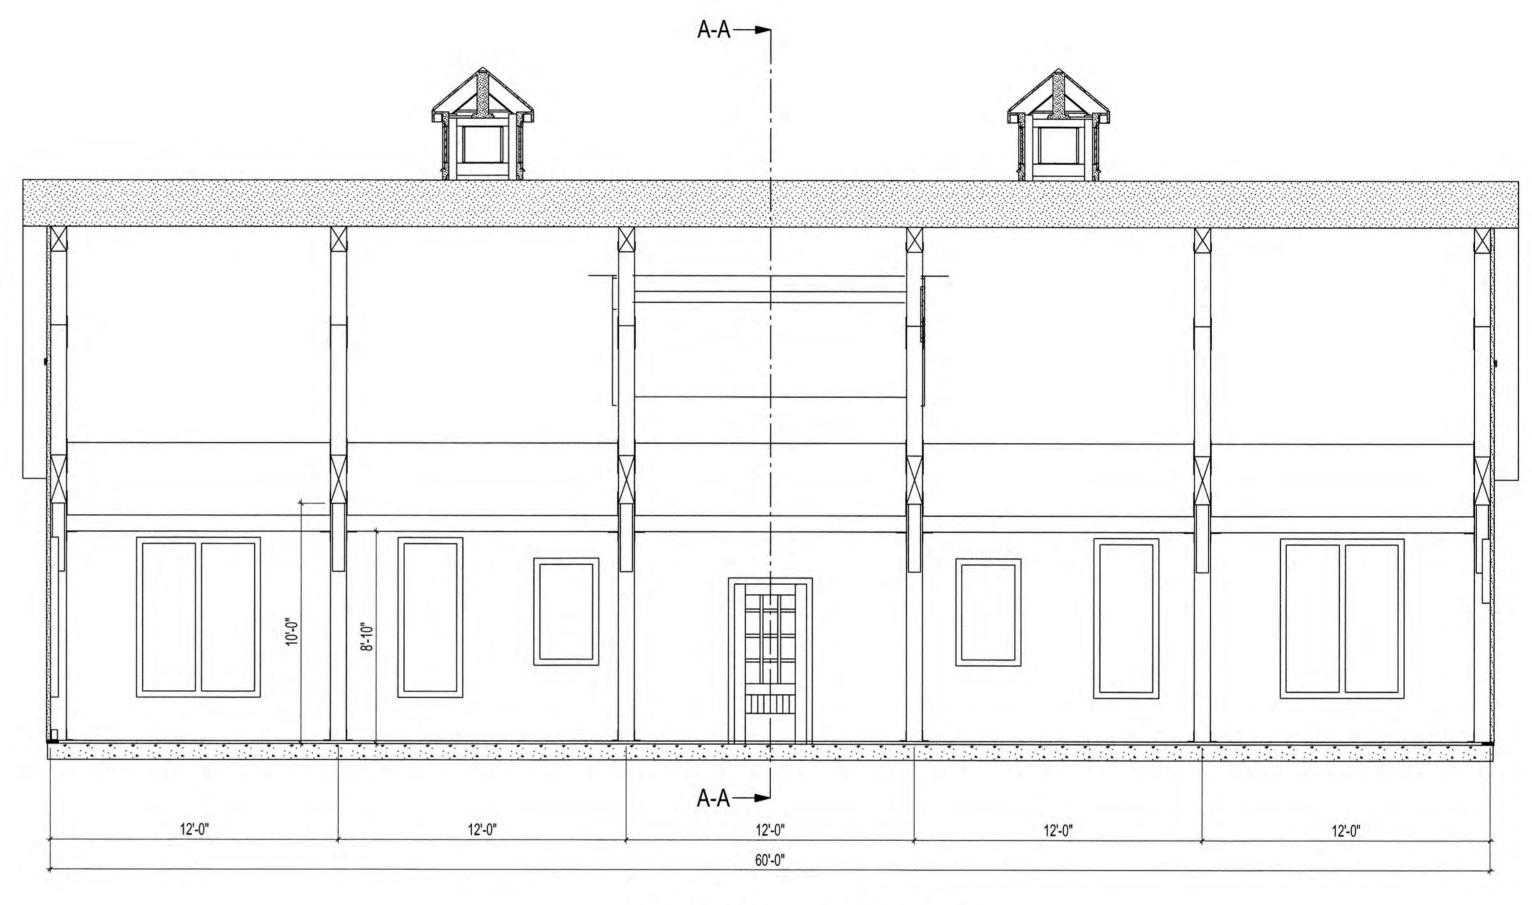

BUILDING SECTION B-B

SCALE: 1/4" = 1'

STYLE: PONDROSA COUNTRY BARN	DRAWN BY: CV
REVISION: 6 (07/08/2022)	DRAWING STATUS: FINAL PLAN SET

Reviewed for Code Compliance

07/12/2022


STRUCTURAL DETAILS ONLY DESIGNED BY ENGINEERING & TECHNICAL SERVICES

			11
SAND CREEK POST & B	SEAM	•	
 116 W. 1st St	PH: (402) 833-5600	3	
WAYNE, NE 68787	FAX: (402) 833-5602 Toll-free: 1 888-489-1680		

EXTERIOR DOOR SCHEDULE						
MARK	DOOR WIDTH	DOOR HEIGHT	DOOR THICKNESS	DOOR MATERIAL	DOOR GLASS	FRAME MATERIAL
$\triangle$	36 "	80 "	1-3/4 "	FBR. GLASS	SIMULATED DIVIDED LIGHT LOW-E	PRIMED PINE
B	72 "	80 "	1-3/4 "	STEEL	1 LITE INSULATED LOW-E	PRIMED PINE

			WINDOW SCHEE	DULE	
MARK	WINDOW WIDTH	WINDOW HEIGHT	WINDOW GLASS	FRAME MATERIAL	WINDOW STYLE
$\triangle$	65-1/2"	26 "	U.24 INSULATED LOW-E HIGH ALTITUDE	FBR. GLASS	FIXED
2	29-1/2"	47-1/2"	U.24 INSULATED LOW-E HIGH ALTITUDE	FBR. GLASS	DOUBLE HUNG
3	29-1/2"	74 "	U.28 INSULATED LOW-E HIGH ALTITUDE	FBR. GLASS	DOUBLE HUNG (EGRESS)
$\bigtriangleup$	29-1/2"	74 "	U.28 INSULATED LOW-E HIGH ALTITUDE	FBR. GLASS	DOUBLE HUNG (TEMPERED)
<u>/</u> 5	23-1/2"	23-1/2"	U.24 INSULATED LOW-E HIGH ALTITUDE	FBR. GLASS	FIXED



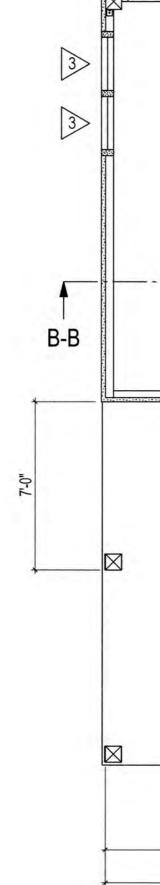

SHEET NOTES:

I. FLOOR LAYOUT DRAWINGS ARE NOT DESIGNED BY AN ARCHITECT. ADDITIONAL PROFESSIONAL SERVICES MAY BE REQUIRED TO COMPLY WITH LOCAL CODES AND REGULATIONS. 2. SAND CREEK POST & BEAM IS NOT RESPONSIBLE FOR DESIGNING ELECTRICAL, PLUMBING, AND HVAC PLANS. 3. INTERIOR PARTITION WALLS, WINDOWS, DOORS, AND FIXTURES ARE PROVIDED BY CUSTOMER OR GENERAL CONTRACTOR. 4. DAYLIGHT OPENING, VENT OPENING, AND EGRESS REQUIREMENTS ARE THE RESPONSIBILITY OF THE CUSTOMER/GENERAL CONTRACTOR. 5. DOOR AND WINDOW LOCATIONS ARE APPROX. ONLY. EXACT LOCATION TO BE DETERMINED BY

THE CUSTOMER AND GENERAL CONTRACTOR.




GENERAL NOTES: -ALL SPACES WILL BE HEATED VIA RADIANT FLOOR HEATING SMOKE/CO DETECTOR LOCATIONS

-WALL OF EACH BEDROOM.(3) -HALLWAY WALL OF MUDROOM LEFT SIDE OF E2 (1) -ON DIVIDER WALL IN HALLWAY BETWEEN BEDROOMS OR E3 (1)

CUSTOMER: KEELIN REGAN-REED

JOB CODE: KRE121-1

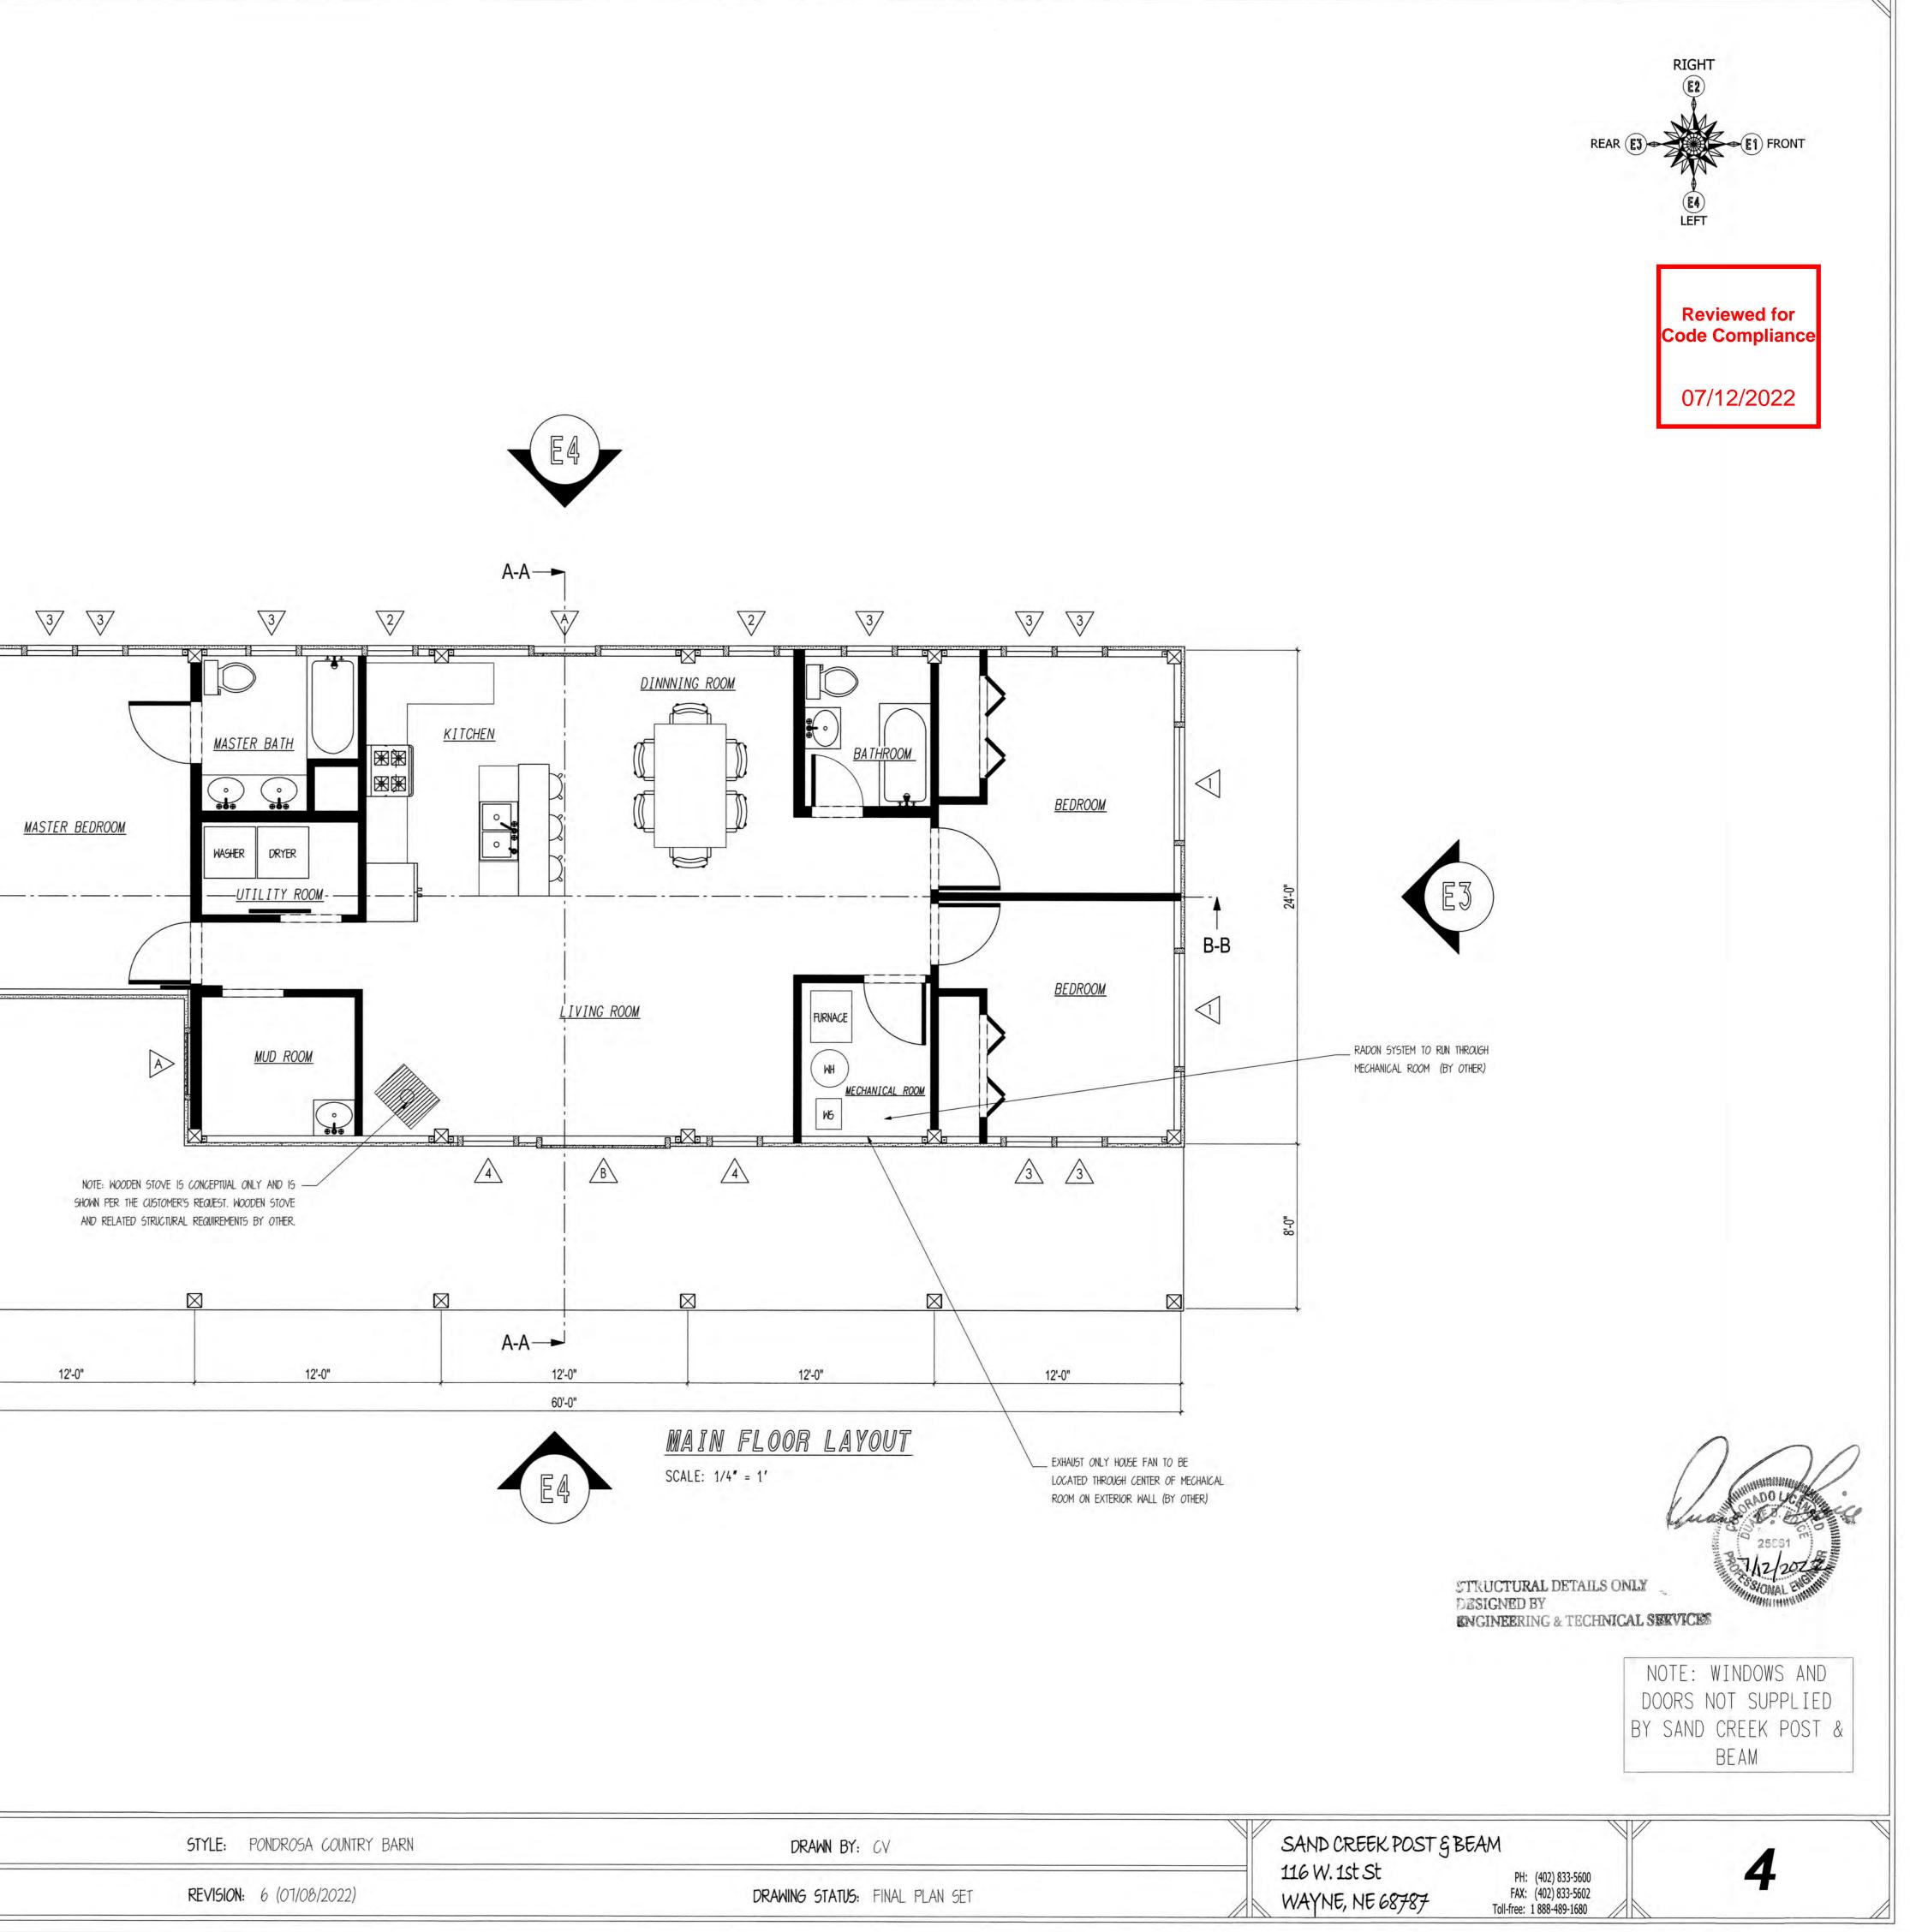

STYLE: PONDROSA COUNTRY BARN	DRAWN BY: CV
<b>REVISION:</b> 6 (07/08/2022)	DRAWING STATUS: FINAL PLAN SET