
# STAGECOACH RESERVOIR ENLARGEMENT RESERVOIR AMENITY IMPROVEMENTS

# Construction Drawings July 2008

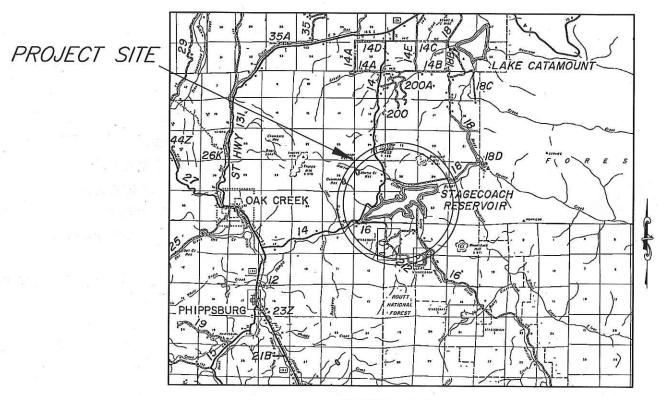

VICINITY MAP

Not to Scale

# DRAWING INDEX

C-001	GENERAL NOTES & LEGENDS
C-101	OVERALL SITE PLAN
C-102	AREA "A" - SWIM BEACH
C-103	AREA "A" - SWIM BEACH PATIO AREA
C-104	AREA "A" - SWIM BEACH VOLLEYBALL AREA
C-105	AREA "A" - SWIM BEACH PICNIC TABLE AREAS
C-106	AREA "B" - MARINA BOAT RAMP AND DOCKS
C-107	AREA "C" - HAYBRO DAY USE AREA
C-108	AREA "D" - FISHERMAN ACCESS
C-109	AREA "E" - PARKING LOT AND VAULT TOILET ON
	RCR-14
C-110	AREA "F" - PARKING LOT AND VAULT TOILET ON
*	RCR-16 NEAR YAMPA RIVER BRIDGE
C-111	AREA "G" - PARKING LOT ON RCR-16
C-112	AREA "H" - LITTLE MORRISON CREEK BOAT RAMP,
	VAULT TOILET, AND PARKING LOT
C-113	AREA "I" — ELK RUN TRAIL AND PEDESTRIAL
*	BRIDGE AT LITTLE MORRISON CREEK
C-114	AREA "J" - FISH BARRIER AT THE RCR-16
	48" CULVERT
C-500	DETAILS
	EROSION AND SEDIMENTATION CONTROL DETAILS
C-502	EROSION AND SEDIMENTATION CONTROL DETAILS

PRELIMINARY PLANS **NOT FOR CONSTRUCTION** FOR PLANNING APPROVALS ONLY

GEOTECHNICAL ENGINEER: Northwest Colorado Consultants, Inc. PO Box 775226 Steamboat Springs, CO 80477 (970) 879-7888

SURVEYOR:

Emerald Mountain Surveys, Inc. PO Box 774812 Steamboat Springs, CO 80477 970-879-8998

WETLAND CONSULTANT:

PO Box 270 Yampa, CO 80483 (970) 638-4462

Upper Yampa Water Conservancy District P.O. Box 880339 Steamboat Springs, CO 80488 (970) 879-2424

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Civil Design Consultants, Inc.

Engineers and Planners First Financial Center, 2145 Resort Drive, Suite 100 Steamboat Springs, CO 80487 Tel (970) 879-3022 • Fax (970) 879-3028

Enlorgement
CDC PROJ. NO: 1526.0041
OWNER: UYWCD
ISSUED: 01/31/08 REF: Final Engr.
REV: 07/15/08 REF: Constr. Dwgs

SHEET NO. C-101 PROJECT NO. 1526.004T

#### GENERAL NOTES

- 1. BASE MAP PLANIMETRICS AND TOPOGRAPHY PROVIDED BY PROJECT
- 2. FLOOD HAZARD MAPPING AND WATER BODY SETBACKS PER PROJECT
- 3. WETLAND DELINEATION, MITIGATION AND SECTION 404 PERMITTING PER PROJECT WETLANDS CONSULTANT.
- THESE DRAWINGS DO NOT INCLUDE PROVISIONS FOR JOBSITE SAFETY. JOBSITE SAFETY IS THE RESPONSIBILITY OF THE CONTRACTOR.
- 5. ALL TRAFFIC CONTROL DEVICES SHALL BE PER "MANUAL OF UNIFORM TRAFFIC CONTROL DEVICES". LATEST EDITION.
- 6. FOR WORK WITHIN THE CITY OF STEAMBOAT SPRINGS, CONTRACTOR SHALL PREPARE AND OBTAIN A CONSTRUCTION SITE MANAGEMENT PLAN MEETING CITY OF STEAMBOAT SPRINGS' REQUIREMENTS. THE CONTRACTOR MAY SUPPLEMENT THE INFORMATION PROVIDED ON THESE DRAWINGS AND SPECIFICATIONS AS REQUIRED. THE CIVIL ENGINEER SHALL HAVE NO DUTY OR RESPONSIBILITY WITH RESPECT TO PREPARATION OF THIS PLAN.
- 7. FOR COMMERCIAL, INDUSTRIAL AND MULTI-FAMILY SITES, SITE PLAN AND A.D.A. REQUIREMENTS PER PROJECT ARCHITECT. REFER TO ARCHITECTURAL SITE PLAN FOR BUILDING LOCATION AND STAKING.
- 8. WHERE REFERENCED, "CDOT STANDARDS" SHALL BE THE LATEST EDITIONS
  - CDOT STANDARD PLANS, M&S STANDARDS, AND/OR B. CDOT STANDARD SPECIFICATIONS FOR ROAD AND BRIDGE CONSTRUCTION

#### GRADING & DRAINAGE NOTES

- SOILS BORINGS OR TEST PIT INFORMATION PER INVESTIGATION REPORT BY PROJECT GEOTECHINCAL ENGINEER. SEE SPECIFICATIONS
- 2. ALL OVERLOT GRADING SHALL COMPLY WITH APPROPRIATE SECTIONS OF THE CURRENT BUILDING CODE.
- CONTRACTOR SHALL OBTAIN A GRADING AND EXCAVATION PERMIT AS APPLICABLE.
- PAVEMENT SECTIONS, CUT AND FILL SLOPE, AND RETAINING WALL RECOMMENDATIONS BY PROJECT GEOTECHNICAL ENGINEER, AS LISTED IN REPORT ABOVE. SEE SPECIFICATIONS.
- CONTRACTOR SHALL OBTAIN A GENERAL PERMIT FOR DEWATERING ASSOCIATED WITH CONSTRUCTION ACTIVITY, AS REQUIRED BY THE COLORADO DEPARTMENT OF HEALTH AND ENVIRONMENT, WHERE
- CULVERT LOCATIONS AND INVERTS ARE APPROXIMATE. CONTRACTOR SHALL CONFIRM THAT CULVERTS MATCH FIELD CONDITIONS AND THAT A MINIMUM 12" COVER IS PROVIDED TO DESIGN FINISH GRADE. CONSTRUCT GRADUAL TRANSITION DITCHES IN AND OUT OF CULVERTS AS REQUIRED.
- IF PROVIDED, REFER TO LANDSCAPE PLAN BY THE PROJECT LANDSCAPE ARCHITECT FOR LANDSCAPING AND FINAL GRADING DETAILS WITHIN LANDSCAPED AREAS.

#### INDUSTRIAL, COMMERCIAL AND MULTI-FAMILY

- FINISH GRADING SURROUNDING BUILDINGS SHALL BE SLOPED MINIMUM OF INCH PER FOOT AWAY FROM THE FOUNDATION FOR 10 FT. MINIMUM, PER GEOTECHNICAL REPORT RECOMMENDATIONS.
- REFER TO ARCHITECTURAL REQUIREMENTS FOR ACCESS DRIVE HEATING (IF INDICATED), AND RETAINING WALLS. PAVEMENT HEATING AND RETAINING
- 10. RECOMMENDATIONS FOR FOUNDATION DRAINAGE AND FOUNDATION DRAINAGE

#### RAW LAND SUBDIVISIONS

11. THESE DRAWINGS WERE PREPARED FOR THE PURPOSE OF CONSTRUCTING A SUBDIVISION AND ARE NOT INTENDED TO BE USED FOR WORK ON INDIVIDUAL LOTS. CONSTRUCTED TOPOGRAPHY MAY VARY FROM THAT SHOWN. THE HORIZONTAL AND VERTICAL LOCATION OF ROADWAYS, WATER AND SEWER LINES AND SERVICES, OTHER UTILITIES AND DRAINAGES SHOULD BE FIFTD-VERIFIED PRIOR TO DESIGN OR CONSTRUCTION OF STRUCTURES ON INDIVIDUAL LOTS. VERIFY ALL PROPERTY LINES, EASEMENTS AND BUILDING ENVELOPES.

# WATER, SEWER, & DRY UTILITY NOTES

- ALL CONSTRUCTION AND MATERIALS FOR WATER AND SEWER SHALL BE IN ACCORDANCE WITH THE CURRENT EDITION OF THE STANDARDS AND SPECIFICATIONS ISSUED BY THE GOVERNING WATER AND SEWER DISTRICT. THE CONTRACTOR SHALL OBTAIN COPIES OF THESE STANDARDS AND SPECIFICATIONS FROM THE DISTRICT.
- 2. A RIGHT-OF-WAY EXCAVATION PERMIT IS REQUIRED FOR ALL UTILITY CUTS WITHIN ROAD RIGHTS-OF-WAY. TRAFFIC CONTROL PLANS MEETING M.U.T.C.D. REQUIREMENTS ARE REQUIRED PRIOR TO ANY WORK IN ROAD RIGHTS-OF-WAY. NO WORK SHALL OCCUR IN THE R.O.W. BETWEEN NOVEMBER 1 - APRIL 1 UNLESS A WRITTEN VARIANCE HAS BEEN APPROVED AND ISSUED BY THE CITY PUBLIC WORKS DIRECTOR.
- 3. TEST HOLES ARE REQUIRED TO VERIFY LOCATION AND ELEVATION OF EXISTING INFRASTRUCTURE AT POINTS OF CONNECTION PRIOR TO
- CONTRACTOR SHALL OBTAIN A MINIMAL INDUSTRIAL DISCHARGE PERMIT, AS REQUIRED BY THE COLORADO DEPARTMENT OF HEALTH AND ENVIRONMENT, FOR THE DISPOSAL OF CHLORINATED WATER FROM TESTING AND FLUSHING ACTIVITIES.
- 5. EXISTING DRY UTILITY LOCATIONS HAVE BEEN PLOTTED FROM THE BEST AVAILABLE INFORMATION. IT IS THE CONTRACTOR'S RESPONSIBILITY TO FIELD VERIFY THE LOCATION AND ELEVATION OF ALL EXISTING DRY UTILITIES PRIOR TO BEGINNING ANY EXCAVATION. RELOCATION OF SOME EXISTING DRY UTILITIES MAY BE NECESSARY. CONTRACTOR SHALL BE RESPONSIBLE FOR ANY DAMAGES TO EXISTING DRY UTILITIES CAUSED BY HIS OPERATIONS.
- 6. COMPLETE SUBGRADE CONSTRUCTION PRIOR TO WATER, SEWER, AND DRY UTILITY INSTALLATION.
- MANHOLE AND VAULT RIM ELEVATIONS ARE APPROXIMATE AND REPRESENT APPROXIMATE FINISH ELEVATIONS. CONTRACTOR IS RESPONSIBLE FOR ORDERING AND INSTALLING COMPONENTS SUCH THAT THE SPECIFICATIONS OF THE GOVERNING WATER AND SEWER DISTRICT ARE MET, INCLUDING ADJUSTMENTS FROM INDICATED ELEVATIONS, IF REQUIRED.
- 8. WATER AND SEWER SERVICE SIZES TO BE AS NOTED ON THE DRAWINGS. FOR INDUSTRIAL, COMMERCIAL OR MULTI-FAMILY SITES, VERIFY BUILDING WATER AND SEWER SERVICE SIZES AND ENTRY LOCATIONS WITH PROJECT ARCHITECT AND/OR MECHANICAL ENGINEER PRIOR TO SEWER AND WATER
- 9. MAINTAIN 12 FT, CLEAR DISTANCE BETWEEN FIRE HYDRANTS AND CURB BOXES, SEWER CLEANOUTS AND ALL ABOVE GROUND DRY UTILITY
- 10. EASEMENTS OF VARIOUS TYPES ARE TO BE DEDICATED AS SHOWN ON THE PLAT OR DRAWINGS. ANY REVEGETATION WITHIN DRAINAGE AND UTILITY EASEMENTS SHALL BE OF A LOW GROWTH NATURE. MAINTAIN 10 FT. MINIMUM SEPARATION FROM WATER AND SEWER MAINS AND APPURTENANCES TO TREES, BOULDERS, ETC.
- 11. PROPOSED ELECTRIC, TELEPHONE, CABLE TV, AND GAS LINE LOCATIONS AND ABOVE GROUND FACILITIES SHOWN ARE PRELIMINARY AND MAY VARY WHEN DESIGN IS COMPLETED BY THE UTILITY COMPANIES. MAINTAIN 5' MINIMUM SEPARATION BETWEEN DRY UTILITIES AND PARALLEL WATER/SEWER
- 12. CONDUITS FOR DRY UTILITY CROSSINGS SHALL BE 4" SCHED. 40, GRAY, ELECTRICAL PVC. CAP ENDS AND PROVIDE 4x4 TREATED TIMBER MARKING POSTS FACH END
- 13. CONTRACTOR IS RESPONSIBLE FOR COORDINATING DRY UTILITY INSTALLATION WITH THE RESPECTIVE DRY UTILITY COMPANIES.
- 14. PROVIDE MINIMUM 48 HRS, NOTICE TO AFFECTED HOMEOWNERS AND UTILITY DISTRICTS PRIOR TO SCHEDULED UTILITY DISRUPTIONS.

# **EROSION & SEDIMENT CONTROL NOTES**

- 1. THE REQUIRED MINIMUM PERMANENT STORMWATER MANAGEMENT PRACTICES ARE SHOWN AND NOTED ON THE DRAWINGS. SOME TEMPORARY MEASURES MAY ALSO BE SHOWN. THE CONTRACTOR SHALL MODIFY AND SUPPLEMENT PRACTICES SHOWN AS NECESSARY TO SATISFY STORMWATER PLAN AND PERMITTING REQUIREMENTS. COMPLY WITH THE BOOKLET "EROSION AND SEDIMENT CONTROL DURING CONSTRUCTION", ROUTT COUNTY, COLORADO.
- FOR WORK OUTSIDE OF THE CITY OF STEAMBOAT SPRINGS CONTRACTOR SHALL OBTAIN A STORM WATER MANAGEMENT PERMIT AS REQUIRED BY ROUTT COUNTY. THE CONTRACTOR MAY SUPPLEMENT THE INFORMATION PROVIDED ON THESE DRAWINGS AND SPECIFICATIONS AS NECESSARY FOR PREPARATION OF A STORMWATER MANAGEMENT PLAN TO OBTAIN SUCH PERMIT. THE CIVIL ENGINEER SHALL HAVE NO DUTY OR RESPONSIBILITY WITH RESPECT TO PREPARATION OF THIS PLAN.
- 3. CONTRACTOR SHALL OBTAIN A STORMWATER DISCHARGE CONTRACTOR STALL OBTAIN A STORMHALER DISCHARGE
  CONSTRUCTION GENERAL PERMIT, AS REQUIRED BY THE COLORADO
  DEPARTMENT OF PUBLIC HEALTH AND ENVIRONMENT. THE CONTRACTOR
  MAY SUPPLEMENT THE INFORMATION PROVIDED ON THESE DRAWINGS AND SPECIFICATIONS AS NECESSARY FOR PREPARATION OF A STORMWATER MANAGEMENT PLAN TO OBTAIN SUCH PERMIT. THE CIVIL ENGINEER SHALL HAVE NO DUTY OR RESPONSIBILITY WITH RESPECT TO PREPARATION OF
- 4. ALL DRAINAGE SWALES SHALL BE GRASS-LINED EXCEPT: RIPRAP OR GEOTEXTILE CHANNEL LINING SHALL BE PROVIDED WHERE INDICATED.
- ALL DISTURBED AREAS NOT RECEIVING FINISH GRADE OR LANDSCAPE TREATMENT SHALL RECEIVE TOPSOIL REPLACEMENT AND NATIVE GRASS REVEGETATION AS A MINIMUM, EXCEPT FOR ROCK SURFACES, UNLESS NOTED OTHERWISE. REVEGETATION SHALL OCCUR AS SOON AS FEASIBLE
- 6. IF INDICATED, ALL CULVERT INLETS AND OUTLETS SHALL HAVE FLARED END SECTIONS OR HEADWALLS, AND RIPRAP PADS. RIPRAP FOR PADS IS NOT SHOWN ON PLANS UNLESS MORE AREA IS REQUIRED THAN INDICATED ON
- CONTRACTOR SHALL MAINTAIN EROSION AND SEDIMENT CONTROL MEASURES UNTIL ESTABLISHMENT OF REVEGETATION TO THE SATISFACTION OF THE AGENCY HAVING JURISDICTION AND SHALL REMOVE ALL TEMPORARY CONTROL MEASURES WHICH HAVE OUTLIVED THEIR USEFULNESS AT FINAL
- 8. CONTRACTOR SHALL APPLY FOR AND OBTAIN A FUGITIVE DUST PERMIT, AS REQUIRED BY THE COLORADO DEPARTMENT OF PUBLIC HEALTH AND
- 9. ALL CONTROLS SHALL BE INSTALLED AS EARLY AS PRACTICAL. DOWNSTREAM PERIMETER CONTROLS SHALL BE INSTALLED PRIOR TO STRIPPING AND STOCKPILING, ALL CONTROLS SHALL BE MONITORED REGULARLY, MODIFIED TO MAINTAIN EFFECTIVENESS, AND CLEANED PRIOR THE ONSET OF WINTER, NO LATER THAN OCTOBER 31ST OF ANY YEAR.
- 10. IN A PHASED CONSTRUCTION PROJECT, THE ABOVE MEASURES AND PROCEDURES SHALL BE IMPLEMENTED AND COMPLETED AS EACH PHASE PROGRESSES, BEFORE PROCEEDING ON TO THE NEXT PHASE.

# STAKING NOTES

- STAKING OF THE WORK SHALL BE PROVIDED BY THE CONTRACTOR, UNLESS INDICATED OTHERWISE. THE ENGINEER WILL PROVIDE AN ELECTRONIC (CADD) FILE OF RELEVANT PORTIONS OF THE CIVIL WORK IN ADDITION TO THE HARDCOPY DOCUMENTS. SUCH CADD FILES MAY NOT SHOW ALL ITEMS REQUIRED TO BE STAKED.
- 2. IN THE EVENT OF A CONFLICT BETWEEN THE ELECTRONIC (CADD) FILE AND THE CONTRACT DRAWINGS AND SPECIFICATIONS, THE CONTRACT DRAWINGS AND SPECIFICATIONS SHALL GOVERN. THE AVAILABILITY AND USE OF CADD FILES SHALL NOT IN ANY WAY RELIEVE THE CONTRACTOR'S RESPONSIBILITY FOR THE PROPER CHECKING AND COORDINATION OF DIMENSIONS, LINES, GRADES AND QUANTITIES OF MATERIALS AS REQUIRED FOR COMPLETE AND ACCURATE COMPLETION OF THE WORK
- 3. DO NOT STAKE USING CONTOUR LINES. GRADES SHOULD BE DETERMINED FROM SPOT ELEVATIONS AND NOTED ELEVATIONS ON CONSTRUCTION
- 4. FOR STAKING OF CATCH BASINS AND INLETS, CONTRACTOR AND/OR SURVEYOR IS RESPONSIBLE FOR DETERMINING STRUCTURE LOCATION AND PIPE ALIGNMENT FROM INFORMATION PROVIDED.

		7
	$\underline{\mathit{LEGEN}}$	<u>ID</u>
EXISTING	PROPOSED	(1)
***************************************	***************************************	WATER (SIZE & TYPE AS NOTED)
	<del>-\$-</del> ►	VALVE, REDUCER
( <del>100</del> )	<del></del>	AIR RELEASE VALVE IN MANHOLE
	-	WATER SERVICE W/CURB STOP
<del></del>	<b>-</b> →	FIRE HYDRANT & GATE VALVE
		BLOWOFF HYDRANT
mare of the same and	<b>—</b>	SEWER (SIZE & TYPE AS NOTED)
(*)4-		SEWER MANHOLE
-D	→ —	SEWER SERVICE, CLEANOUT
	PS	PRESSURE SEWER SERVICE W/CURB STOP & CHECK VALVE
E	— E —	ELECTRIC LINE
FO	—F0—	FIBER OPTICS LINE
T	— T —	TELEPHONE LINE
G	— G —	GAS LINE
I)/	<u>тv —</u>	CABLE TV LINE
		ELEC, TEL, TV PED GROUPING
		ELEC TRANSFORMER OR SWITCH GEAR
<u> </u>	<u> </u>	ELEC CUBICLE
0		TEL PED
O		CATV PED DRY UTILITY CONDUIT (NUMBER)
Ø	(2) Ø	POWER POLE
150 150	<i>1</i> 20	LIGHT POLE
		GUY WIRE
		PUBLIC LANDS SURVEY LINE PROPERTY LINE
		EASEMENT LINE
		B'LDG. ENVELOPE/SETBACK LINE
PROPERTY OWNER		ADJACENT PROPERTY OWNER
	6690	CONTOUR
× 95.4	× 95.8 FG	SPOT ELEVATION
× 95.00 TBC	× 95.00 TBC	TOP BACK OF CURB ELEVATION
× 95.00 FL	× 95.00 FL × 95.00 EA	FLOW LINE ELEVATION
× 95.00 EA	× 95.00 EA F.F. 6700	EDGE OF ASPHALT ELEVATION FINISH FLOOR ELEVATION
(	0,00	ROCK OUTCROP
1-1-1	<b>6</b> XX	
<u></u>	XXX	WETLAND
1		TREE/VEGETATION LINE
XX	×	FENCE
		TOP OF CUTS
	where we were the second	TOE OF FILLS
	3:1	SITE GRADING SLOPE
	<b>−2.5</b> % <b>→</b>	PAVEMENT/CONCRETE SLOPE
		STORM DRAIN (SIZE & TYPE NOTED)
)== t==	) <del>       </del>	The transfer of the same of th
<u> </u>		CULVERT; FLARED END SECT./HEADW'L.
		SUBDRAIN

---- SUBDRAIN DRAINAGE SWALE/ IRRIG. DITCH STORM DRAIN CATCH BASIN/INLET STORM DRAIN CLEANOUT/MANHOLE EEG. RIPRAP

ROCK CHECK DAM JUTE NETTING/EROSION CONTROL BLANKE TD TEMPORARY DIVERSION DIKE ---- EL ---- EROSION LOG

- SF - SILT FENCE K (TYPE) SIGNS ⊙ B.M.

BENCH MARK ◆ TP #25 TEST PIT TRAIL OR SIDEWALK GUARDRAIL (METAL)

GUTTER/CURB AND GUTTER

EDGE OF PAVEMENT/SHOULDER Copyright CIVIL DESIGN CONSULTANTS, INC. 2008

Dote: 31 JAN 08 UPPER YAMPA WATER CONSERVANCY DISTRICT Drawn: LB STAGECOACH RESERVOIR ENLARGEMENT esigned: BF Scale: As Noted

GENERAL NOTES & LEGENDS CONSTRUCTION DRAWING

Civil Design Consultants, Inc. Engineers and Planners

VERTICAL WATERLINE BEND CENTER OF MANHOLE <INTERSECTION: CENTER OF CATCH BASIN FOR AREA CENTER OF IN-LINE VALVE OR VALVE SPECIFICALLY DIMENSIONED FROM FITTING BASE <CENTER> DRAIN/ CENTER OF BACK EDGE OR (GENERALLY, VALVES NEAR CORNER OF BACK
EDGE OF GRATE FOR
INLETS IN GUTTERS
<CENTER, MIDPT., WATERLINE BEND (HORIZONTAL) <INTERSECTION> PICKED FOR STAKEOUT.)

SURVEY STAKEOUT PICK POINTS IN CADD FILES

<INDICATES SNAP MODE>

WATERLINE TEE <INTERSECTION> <CENTER>

EDGE OF ASPHALT AT CENTER OF CLEANOUT END OF SEWER GUTTER <INSERT> <INSERT> <INTERSECTION>

95.00 EA 95.50 TBC/ \95.00 FL GUTTER <INSERT>

CENTER OF FIRE

95.00 TBC OR EA

EDGE OF GUTTER

- INSERTS

<CENTER> CENTER OF CURB

ENDPT.>

<CENTER:

TOP BACK OF CURB FLOW LINE O


REVISIONS

CALL UTILITY NOTIFICATION CENTER OF COLORADO

1-800-922-1987

CALL 2 BUSINESS DAYS IN ADVANCE BEFORE YOU DIG, GRADE, OR EXCAVATE FOR THE MARKING OF UNDERGROUND MEMBER UTILITIES

First Financial Center, 2145 Resort Drive, Suite 100 Steamboat Springs, CO 80487 Tel (970) 879-3022 • Fax (970) 879-3028 SHEET NO. C-001 PROJECT NO. 1526.004T

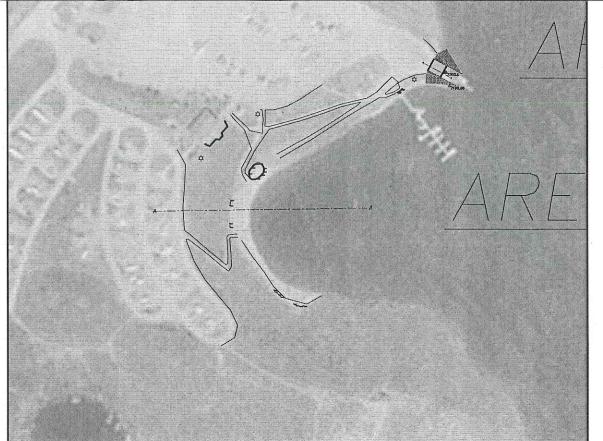


GENERAL AREA MAP

SCALE: 1" = 100

#### **CONSTRUCTION NOTES:**

- CONTRACTOR SHALL NOT DISTURB EXISTING VEGETATION UNLESS ABSOLUTELY NECESSARY FOR CONSTRUCTION. PROPOSED DISTURBANCE AREAS MUST BE CLEARED WITH PARK RANGER PRIOR TO DISTURBANCE.
- 2. CONTRACTOR SHALL NOT DISTURB AREA OR BEGIN MOVING INTO WORK AREAS UNTIL AFTER LABOR DAY.
- CONSTRUCTION ACCESS INTO THE WORK AREA SHALL BE ALONG THE EXISTING TRAIL FROM THE BOAT RAMP AREA.
- BEACH FILL MATERIAL SHALL BE FROM A DESIGNATED BORROW PIT NEARBY AND COMPACTED TO 95% OF ASTM 698 WITHIN 2% OF OPTIMUM MOISTURE CONTENT.
- 5. BEACH SAND SHALL BR OBTAINED FROM A
  DESIGNATED BORROW PITS IN THE AREA.
  GRADATION OF THE SAND SHALL PASS A NO. 4
  SCREEN AND SHALL HAVE NO FINES SMALLER THAN
  A NO. 100 SCREEN. REDMOND PIT FINES SHALL NOT BE ALLOWED.
- THE BEACH SAND SHALL BE VIBRATAORY ROLLER COMPACTED TO 95% OF ASTM 698 AT OR OVER OPTIMUM MOISTURE CONTENT.
- BEACH SAND SHALL BE THE LIGHTEST COLOR AVAILABLE IN THE AREA.
- SEE SHEETS C-103 THROUGH C-105 FOR ADDITIONAL DETAILS REGARDING THE PATIO, VOLLEYBALL, AND PICNIC AREAS.

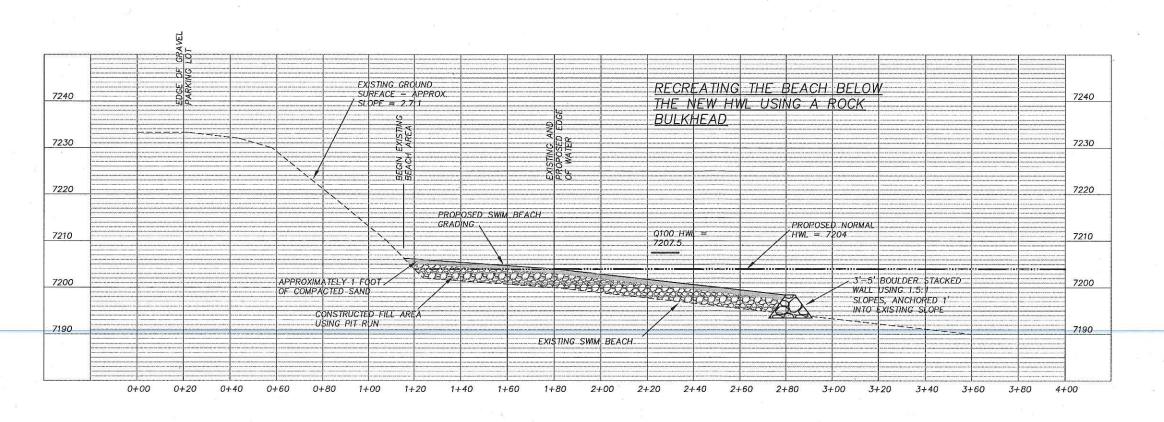

BEACH SECTION A-A

SCALE: 1" = 20' HORIZ. 1" = 10' VERT.

( IN FEET ) 1 inch = 60 ft. 2' CONTOUR INTERVAL (STAGECOACH RESERVOIR SPILLWAY DATUM) 11x17 DRAWINGS HAVE BEEN REDUCED TO HALF SIZE CALL UTILITY NOTIFICATION CENTER OF COLORADO 1-800-922-1987 REVISIONS ltem Copyright CIVIL DESIGN CONSULTANTS, INC. 2008 Date: 31 JAN 08 UPPER YAMPA WATER Drawn: CL / LB CONSERVANCY DISTRICT Designed: CL / DB STAGECOACH RESERVOIR ENLARGEMENT Scale: As Noted AREA "A" - SWIM BEACH CONSTRUCTION DRAWING Civil Design Consultants, Inc. Engineers and Planners
First Financial Center, 2145 Resort Drive, Suite 100
Steamboat Springs, CO 80487
Tel (970) 879-3022 • Fax (970) 879-3028

SHEET NO. C-102 PROJECT NO. 1526.004T

SHEET NO. C-103 PROJECT NO. 1526.004T

SHEET NO. C-105 PROJECT NO. 1526.004T

CONTRACTOR SHALL WORK WITH ENGINEER AND STATE PARKS RANGER TO MOVE APPROXIMATELY 8 EXISTING STATIONARY GRILLS TO A HIGHER ELEVATION, IF NECESSARY. MOVED GRILLS SHALL BE PLACED IN CONCRETE FOUNDATIONS AS EXISTING. SCALE: 1'' = 20'PLAN VIEW GENERAL AREA MAP SCALE: 1" = 50'7210 ( IN FEET )


1 inch = 20 ft.

2' CONTOUR INTERVAL

(STAGECOACH RESERVOIR SPILLWAY DATUM)

11×17 DRAWINGS HAVE BEEN REDUCED TO HALF SIZE 7208 CALL UTILITY NOTIFICATION CENTER OF COLORADO 7206 1-800-922-1987 7204 7202 7200 Copyright CIVIL DESIGN CONSULTANTS, INC. 2008 Date: 31 JAN 08 UPPER YAMPA WATER CONSERVANCY DISTRICT Drown: CL / LB STAGECOACH RESERVOIR ENLARGEMENT Designed: CL / D8 0+40 0+60 0+80 1+00 1+20 1+40 1+60 Scale: As Noted AREA "C" -- HAYBRO DAY USE AREA CONSTRUCTION DRAWING Civil Design Consultants, Inc.
Engineers and Planners
First Financial Center, 2145 Resort Drive, Suite 100
Steamboat Springs, CO 80487
Tel (970) 879-3022 - Fax (970) 879-3028 SCALE: 1" = 20' HORIZ. ROAD SECTION A-A 1" = 2' VERT.SHEET NO. C-107 PROJECT NO. 1526.004T

CONSTRUCTION NOTES:

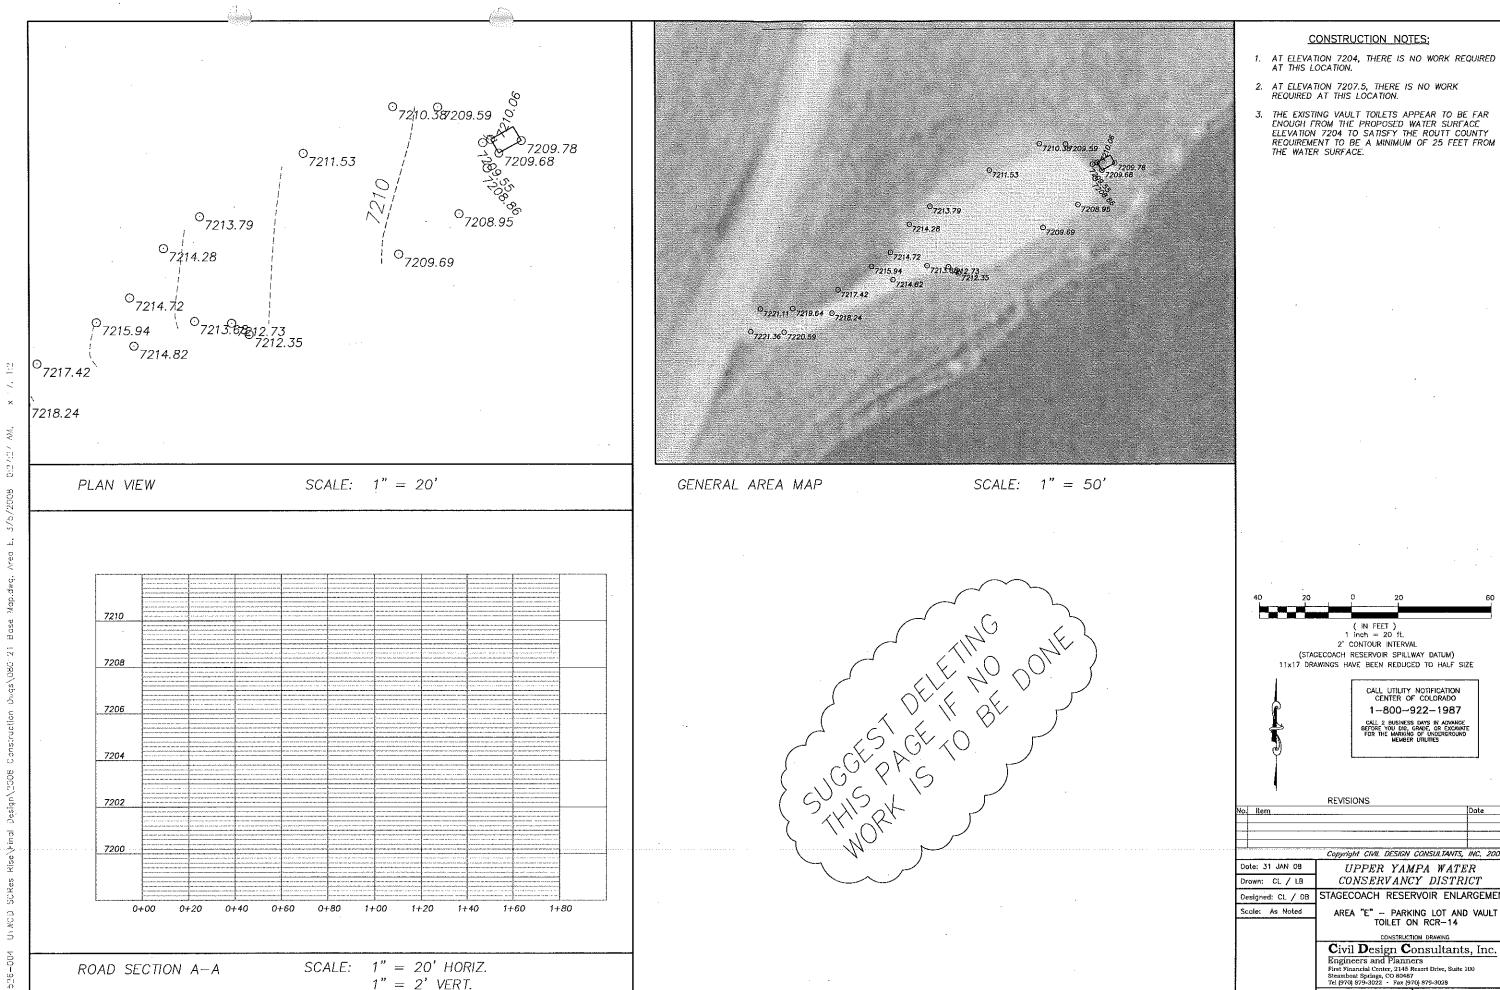

( IN FEET )
1 inch = 20 ft.
2' CONTOUR INTERVAL

REVISIONS

CALL UTILITY NOTIFICATION CENTER OF COLORADO

1-800-922-1987

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STAGECOACH RESERVOIR ENLARGEMENT

AREA "E" — PARKING LOT AND VAULT TOILET ON RCR-14


CONSTRUCTION DRAWING


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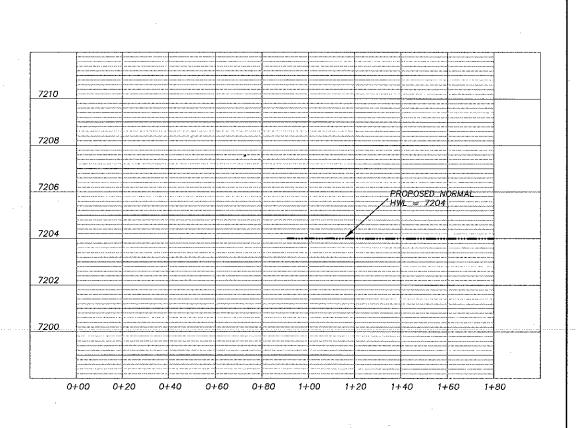
SHEET NO. C-109 PROJECT NO. 1526.004T

UPPER YAMPA WATER CONSERVANCY DISTRICT

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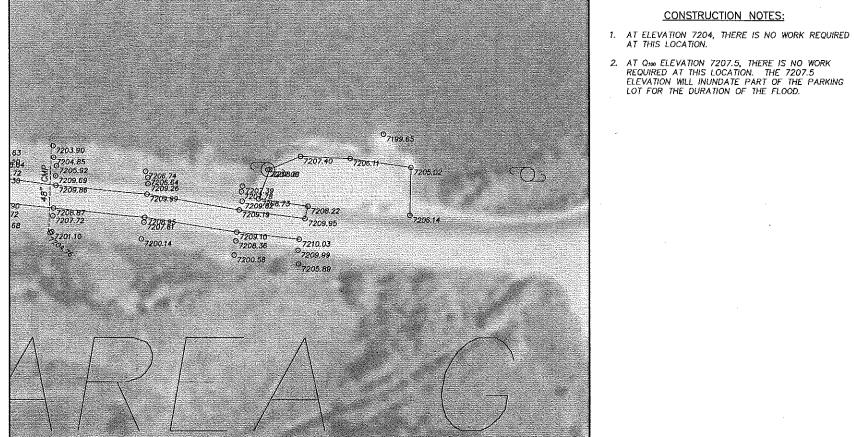


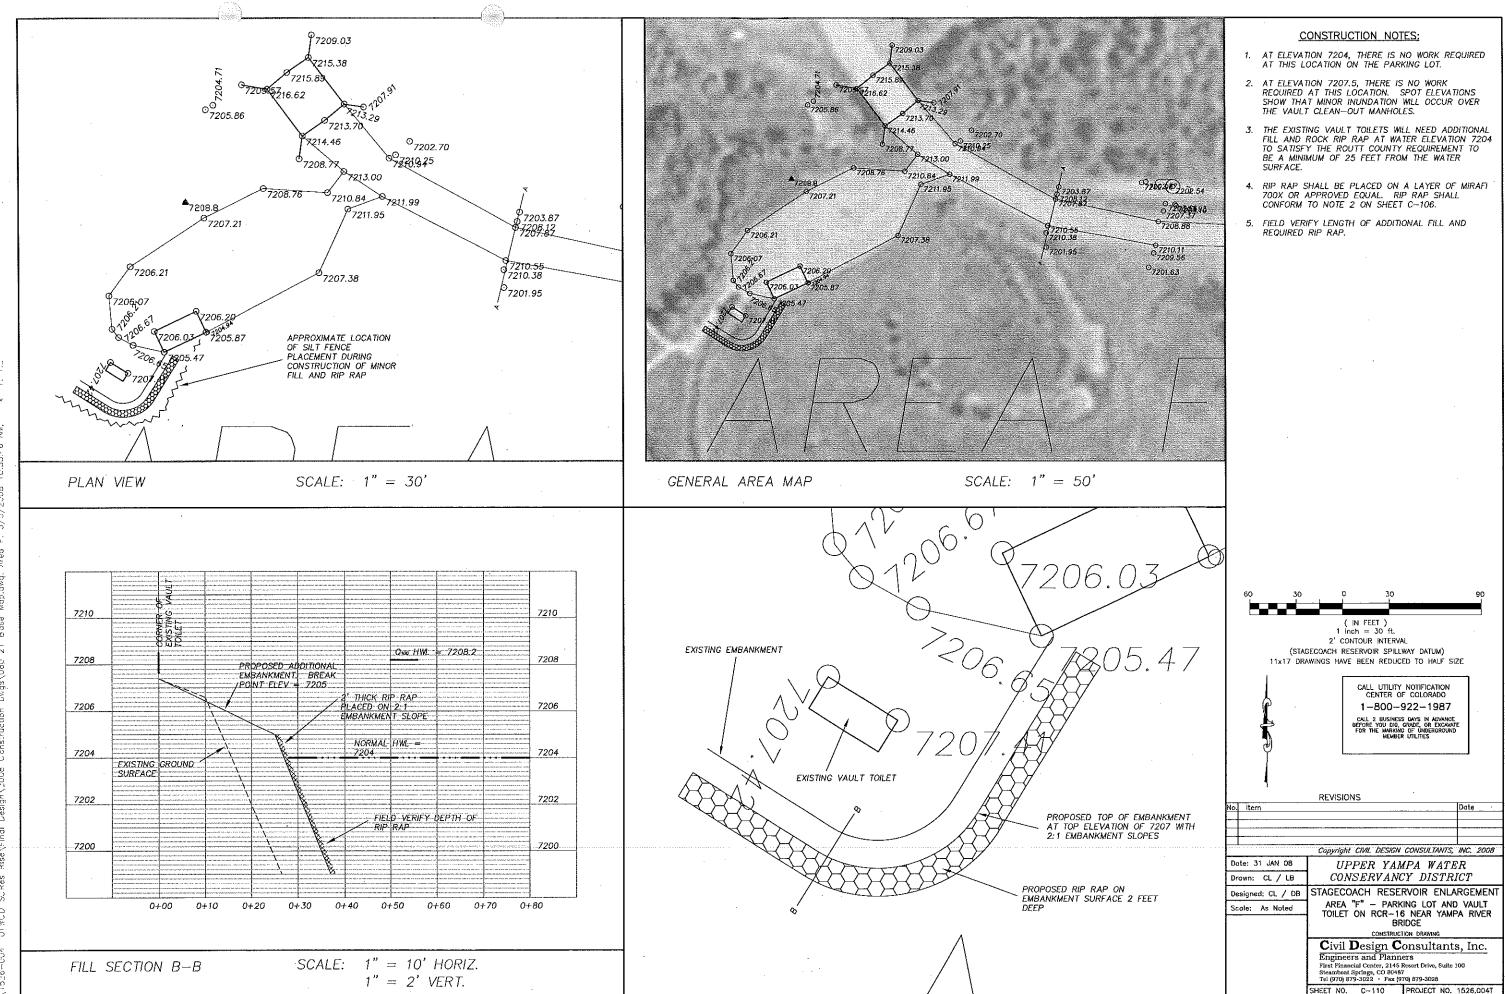



SCALE: 1" = 20' HORIZ.

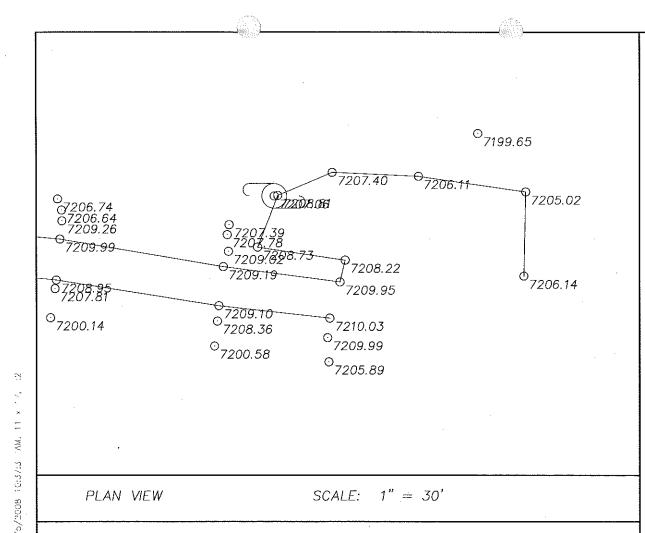1" = 2' VERT.


ROAD SECTION A-A



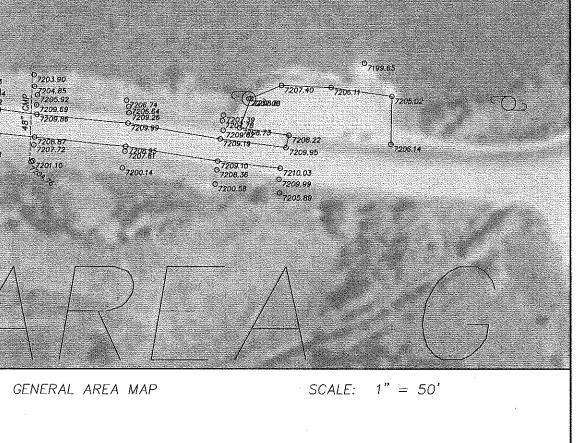

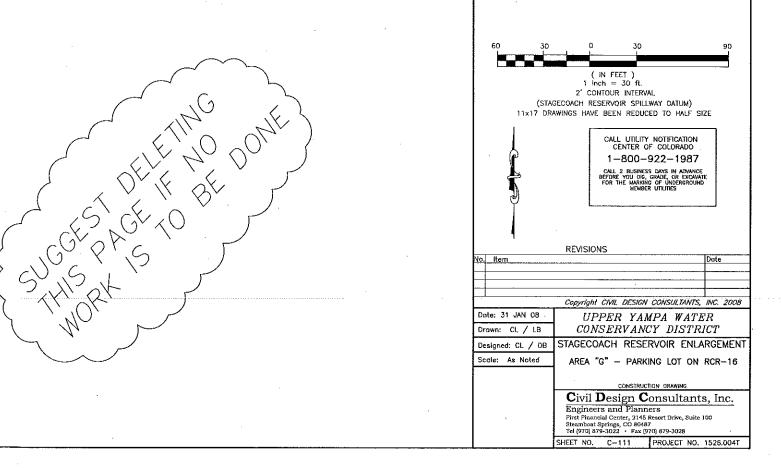

**CONSTRUCTION NOTES:** 

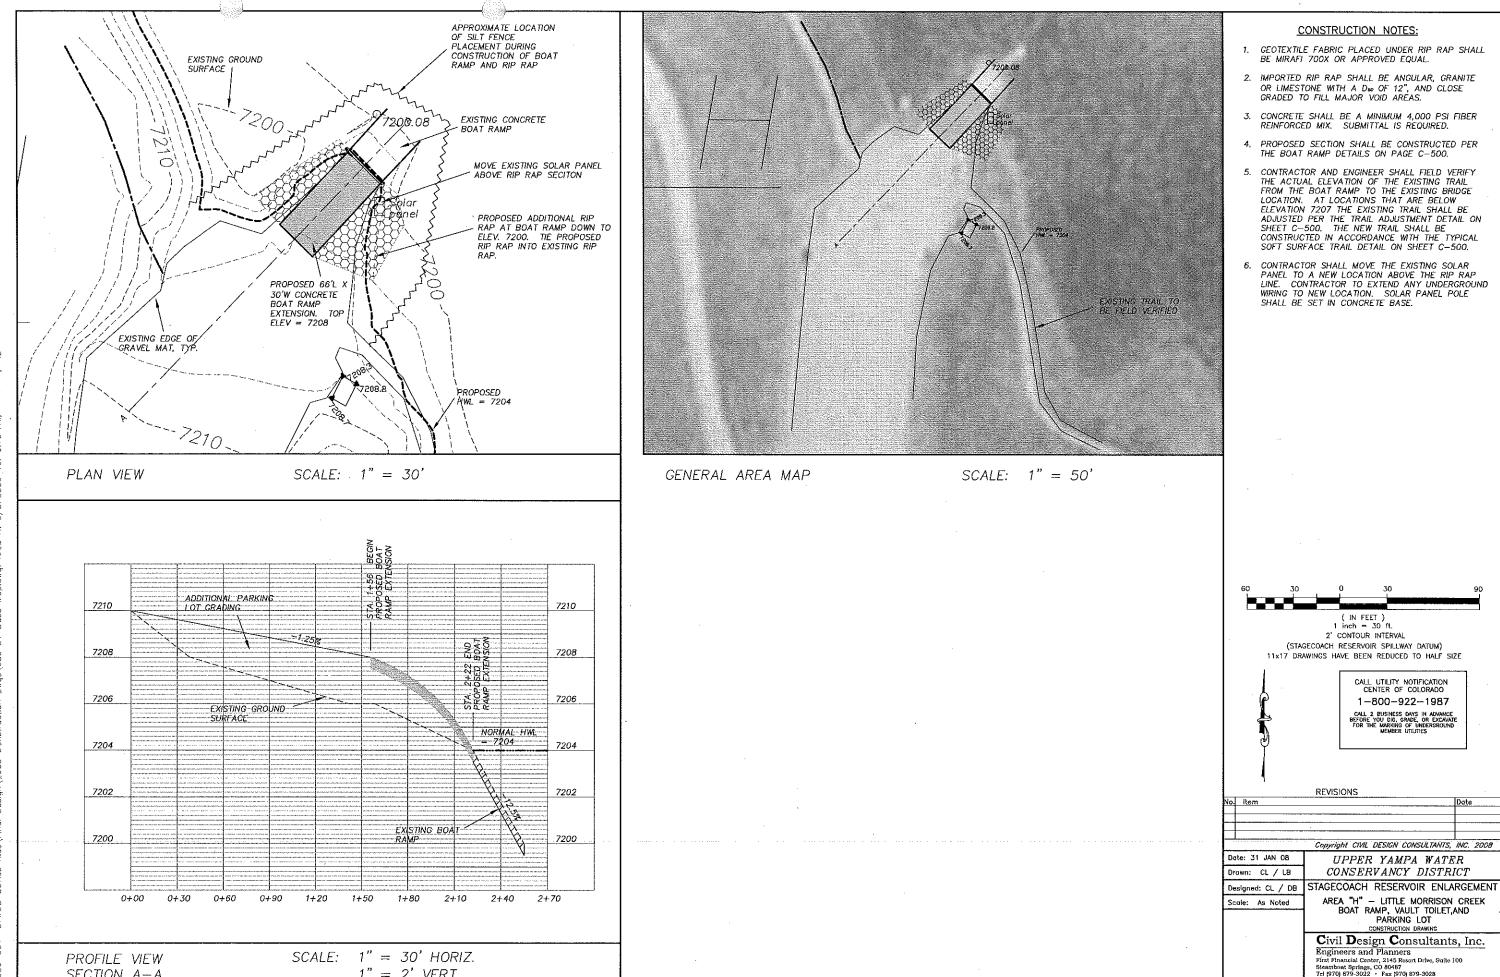



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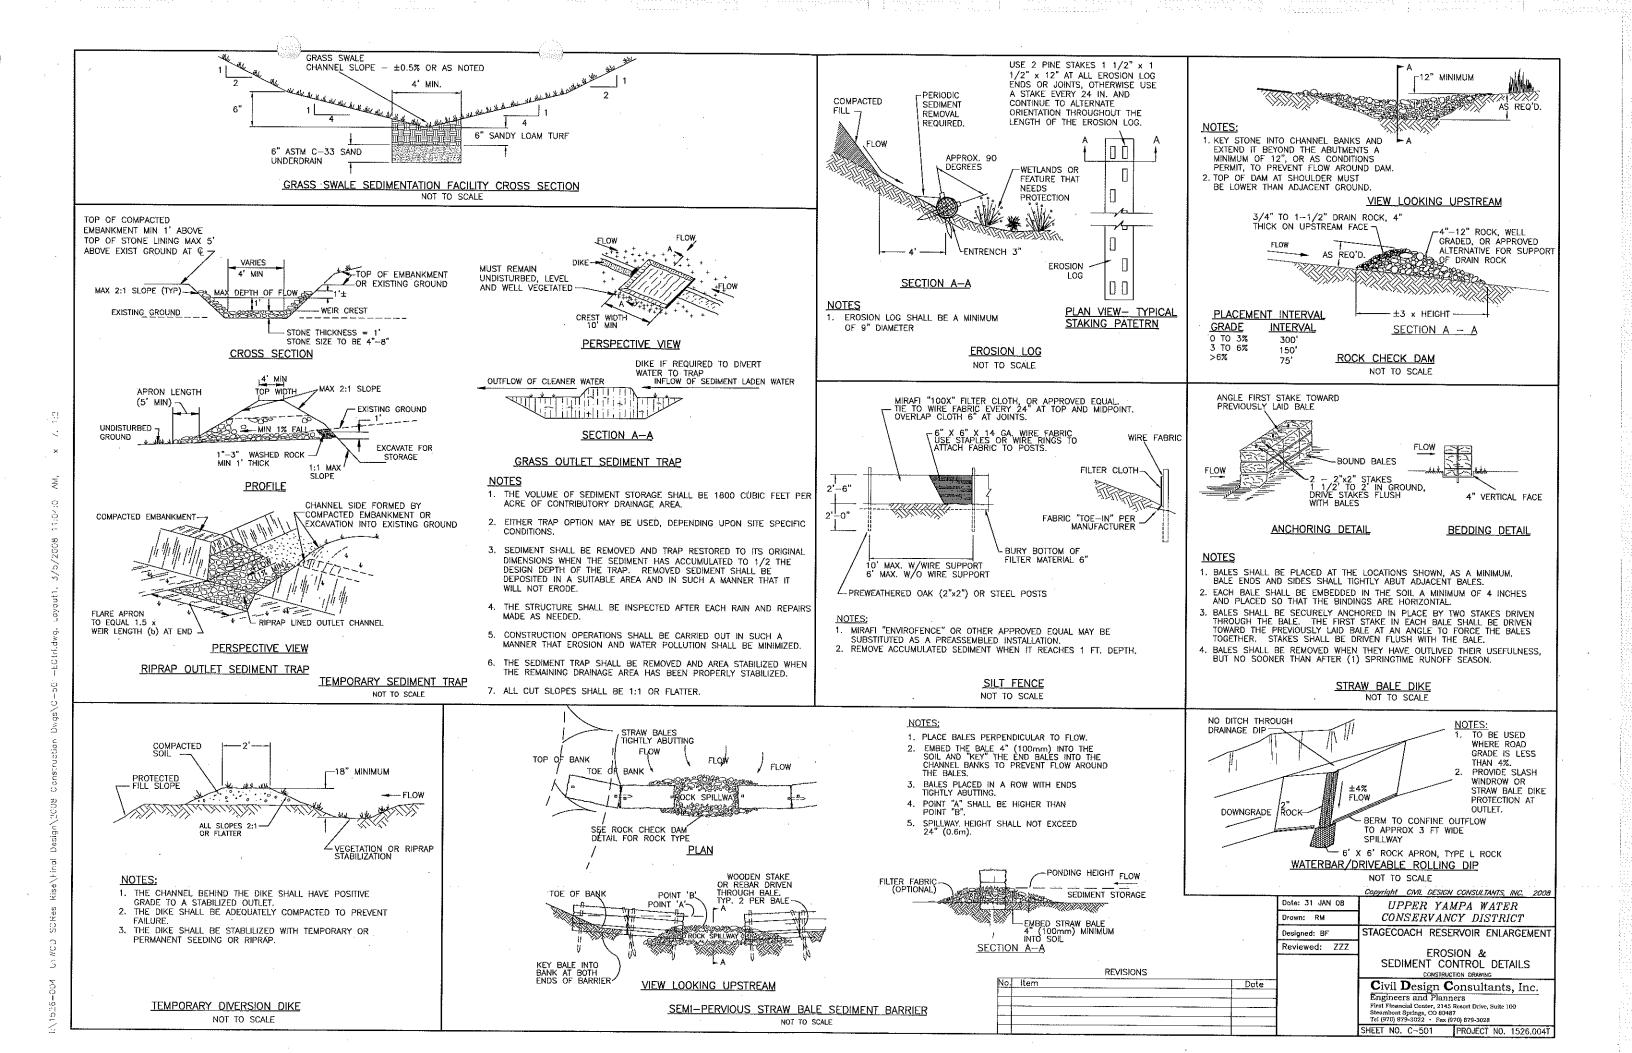
SHEET NO. C-112 PROJECT NO. 1526,004T


SECTION A-A


1" = 2' VERT.



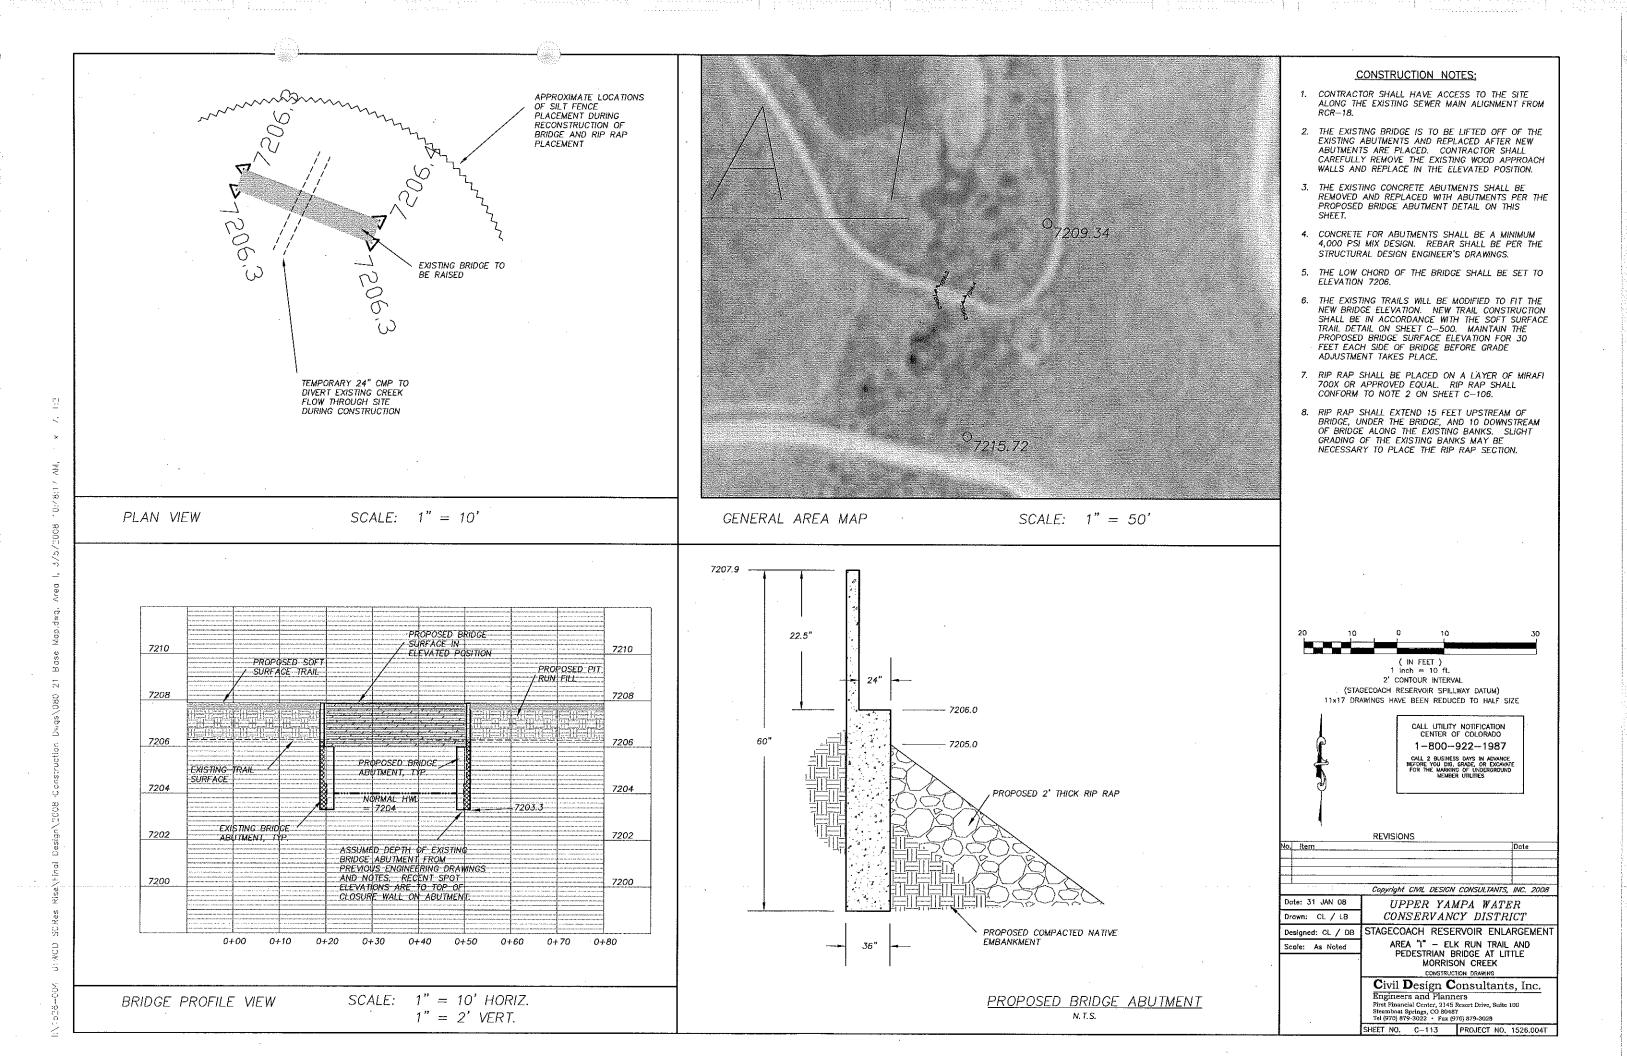

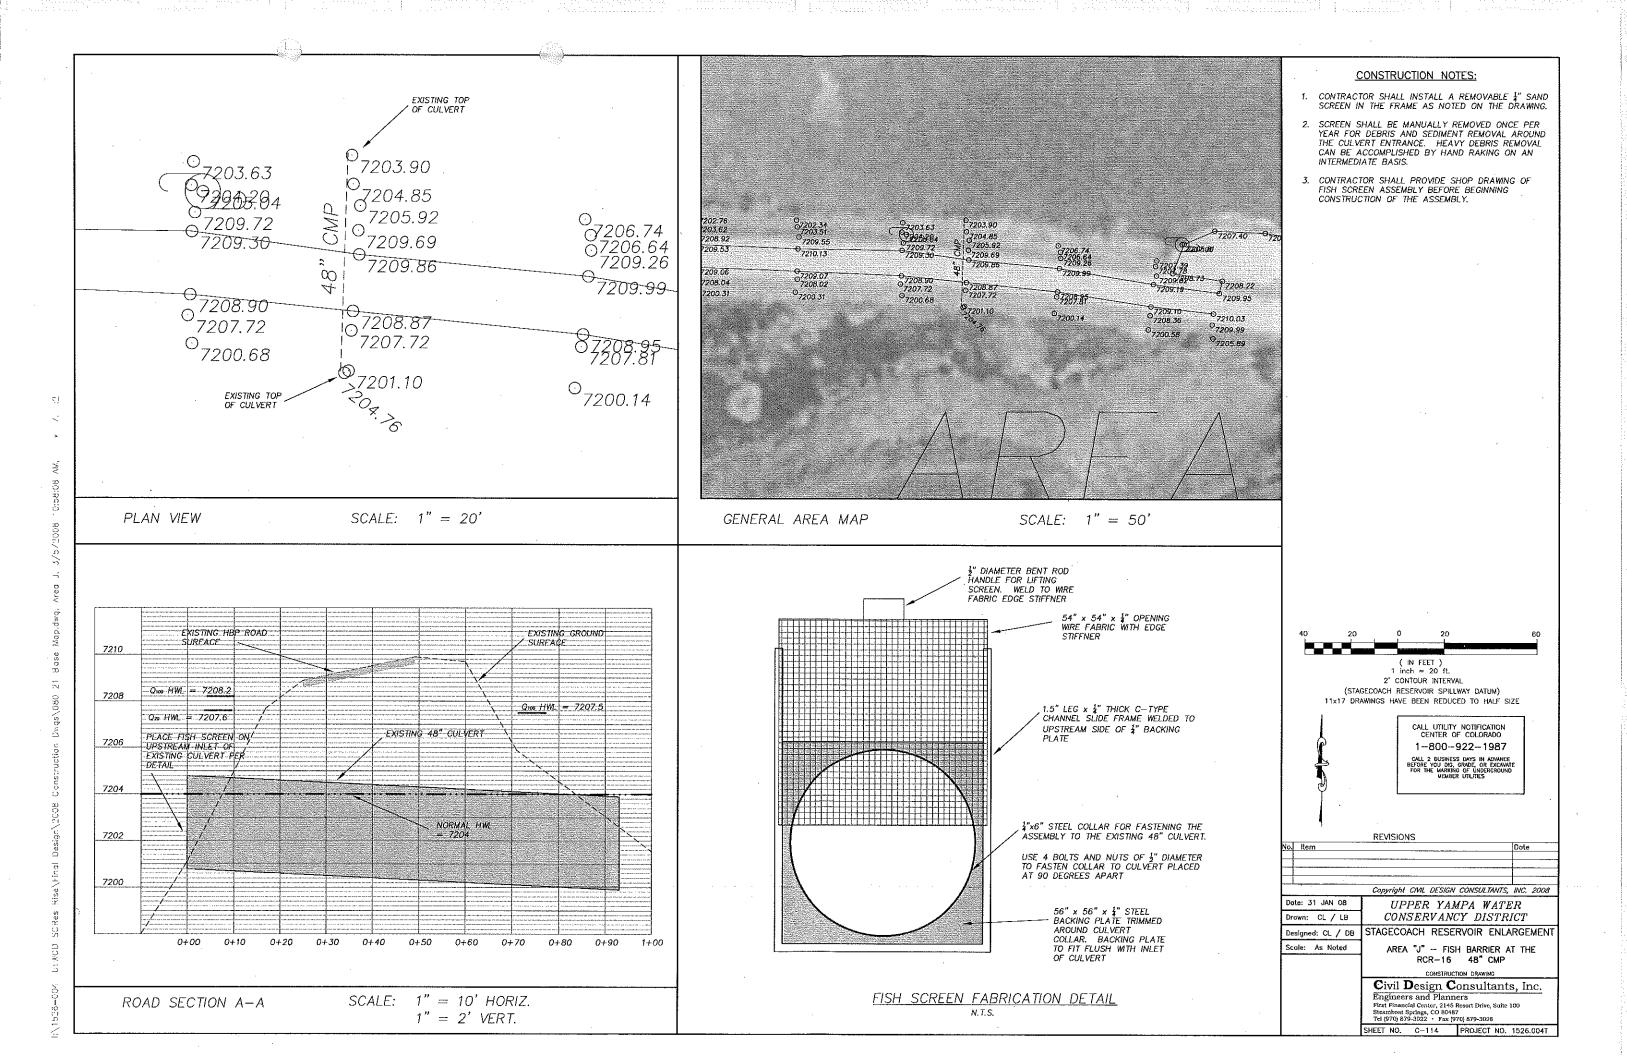


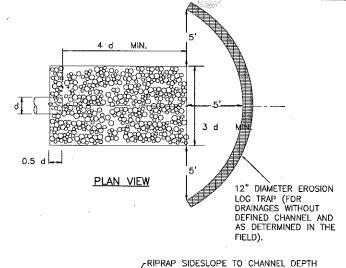

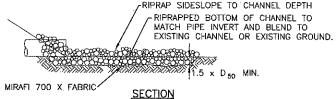


1. RIPRAP  $D_{50} = 6$ " (DRAINAGES WITH 18" OR SMALLER CULVERTS) 2. RIPRAP  $D_{50}^{30} = 12$ " (DRAINAGES WITH CULVERTS LARGER THAN 18")

> CULVERT DISCHARGE ROCK APRON NOT TO SCALE

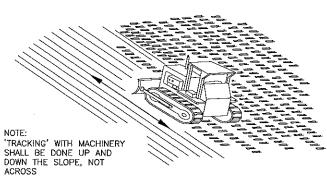


SLOPE TRACKING
NOT TO SCALE

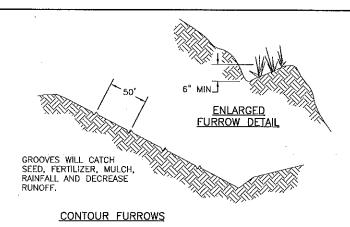


SURFACE ROUGHENING NOT TO SCALE

RIPRAP THICKNESS EXISTING ERODED RIVER BANK (P) FABRIC (P) ROCK RIPRAP (P) FABRIC- $T(1+Z^2)$ = 2.7RIPRAP PARAMETERS D50 d 12 IN Ø 18 INCHES 1.5 VARIES 2.25

TYPICAL BANK STABILIZATION
NOT TO SCALE

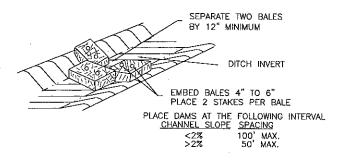


HAY CHECK DAM NOT TO SCALE

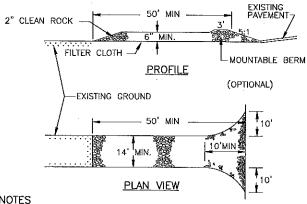

- 1. PLACE FILTER CLOTH OVER THE ENTIRE AREA PRIOR TO PLACING OF STONE.
- 2. ALL SURFACE WATER FLOWING OR DIVERTED TOWARD CONSTRUCTION ENTRANCES SHALL BE PIPED ACROSS THE ENTRANCE. IF PIPING IS IMPRACTICAL, A MOUNTABLE BERM WITH 5:1 SLOPES WILL BE PERMITTED.
- 3. THE ENTRANCE SHALL BE MAINTAINED IN A CONDITION WHICH WILL PREVENT TRACKING OR FLOWING OF SEDIMENT ONTO THE PUBLIC RIGHT-OF-WAY. THIS MAY REQUIRE PERIODIC TOP DRESSING WITH ADDITIONAL STONE AS CONDITIONS DEMAND AND REPAIR AND/OR CLEANOUT OF ANY MEASURES USED TO TRAP SEDIMENT. ALL SEDIMENT SPILLED, DROPPED, WASHED OR TRACKED ONTO PUBLIC RIGHTS-OF-WAY MUST BE REMOVED IMMEDIATELY.

# STABILIZED CONSTRUCTION ENTRANCE


NOT TO SCALE

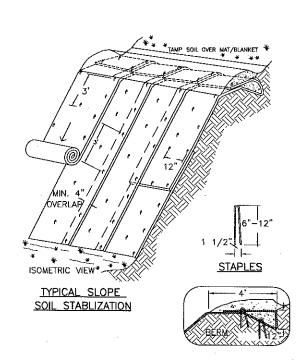


- 1. SLOPE SURFACE SHALL BE FREE OF ROCKS, CLODS, STICKS AND GRASS. MATS/ BLANKETS SHALL HAVE GOOD SOIL CONTACT.
- 2. INSTALL BLANKETS/MATS VERTICALLY DOWNSLOPE.
- 3. LAY BLANKETS/MATS LOOSELY AND STAKE OR STAPLE TO MAINTAIN DIRECT CONTACT WITH THE SOIL. DO NOT STRETCH.
- 4. SEE SPECIFICATIONS FOR BLANKET OR MAT TYPE.
- 5. DETAIL SHOWS TYPICAL MINIMUM REQUIREMENTS. STAKING OR STAPLING LAYOUT TO BE PER MANUFACTURERS SPECIFICATIONS.


#### EROSION CONTROL BLANKETS / TURF REINFORCEMENT MATS SLOPE INSTALLATION NOT TO SCALE



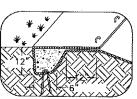

LONGITUDINAL ANCHOR TRENCH TERMINAL SLOPE AND CHANNEL **ANCHOR TRENCH** 

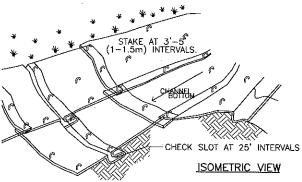

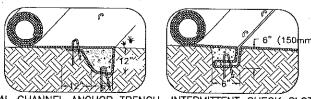


INITIAL CHANNEL ANCHOR TRENCH INTERMITTENT CHECK SLOT

- NOTES:

  1. CHECK SLOTS & OVERLAPS TO BE CONSTRUCTED PER MANUFACTURERS SPECIFICATIONS.
- 2. STAKING OR STAPLING LAYOUT PER MANUFACTURERS SPECIFICATIONS,

## EROSION BLANKETS / TURF REINFORCEMENT MATS CHANNEL INSTALLATION

NOT TO SCALE

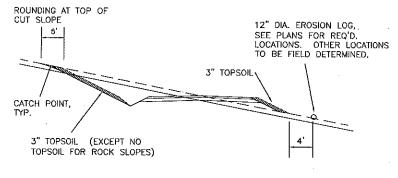

- 1. SEE SPECIFICATIONS FOR REVECETATION REQUIREMENTS AND TEMPORARY SLOPE STABILIZATIONS MEASURES.
- CUT AND FILL SLOPES TO BE IN A ROUGHENED CONDITION PRIOR TO TOPSOILING AND REVETATION. TEMPORARY SLOPE STABILIZATION MAY BE REQUIRED AT ANY TIME PRIOR TO FINAL REVEGETATION ACCEPTANCE.

TYPICAL EROSION AND SEDIMENT CONTROL TREATMENT ON SLOPES NOT TO SCALE

> REVISIONS Date

	Copyright CIVIL DESIGN CONSULTANTS, INC. 2008
Date: 31 JAN 08	UPPER YAMPA WATER
Drown: RM	CONSERVANCY DISTRICT
Designed: BF	STAGECOACH RESERVOIR ENLARGEMENT
Reviewed: ZZZ	EROSION & SEDIMENT CONTROL DETAILS CONSTRUCTION DRAWING
- - - - - - - -	Civil Design Consultants, Inc. Engineers and Planners First Financial Center, 2145 Resort Drive, Suite 100 Steamboat Springs, CO 80487 Tet (970) 879-3022 - Fax (970) 879-3028

SHEET NO. C-502 PROJECT NO. 1526,004T